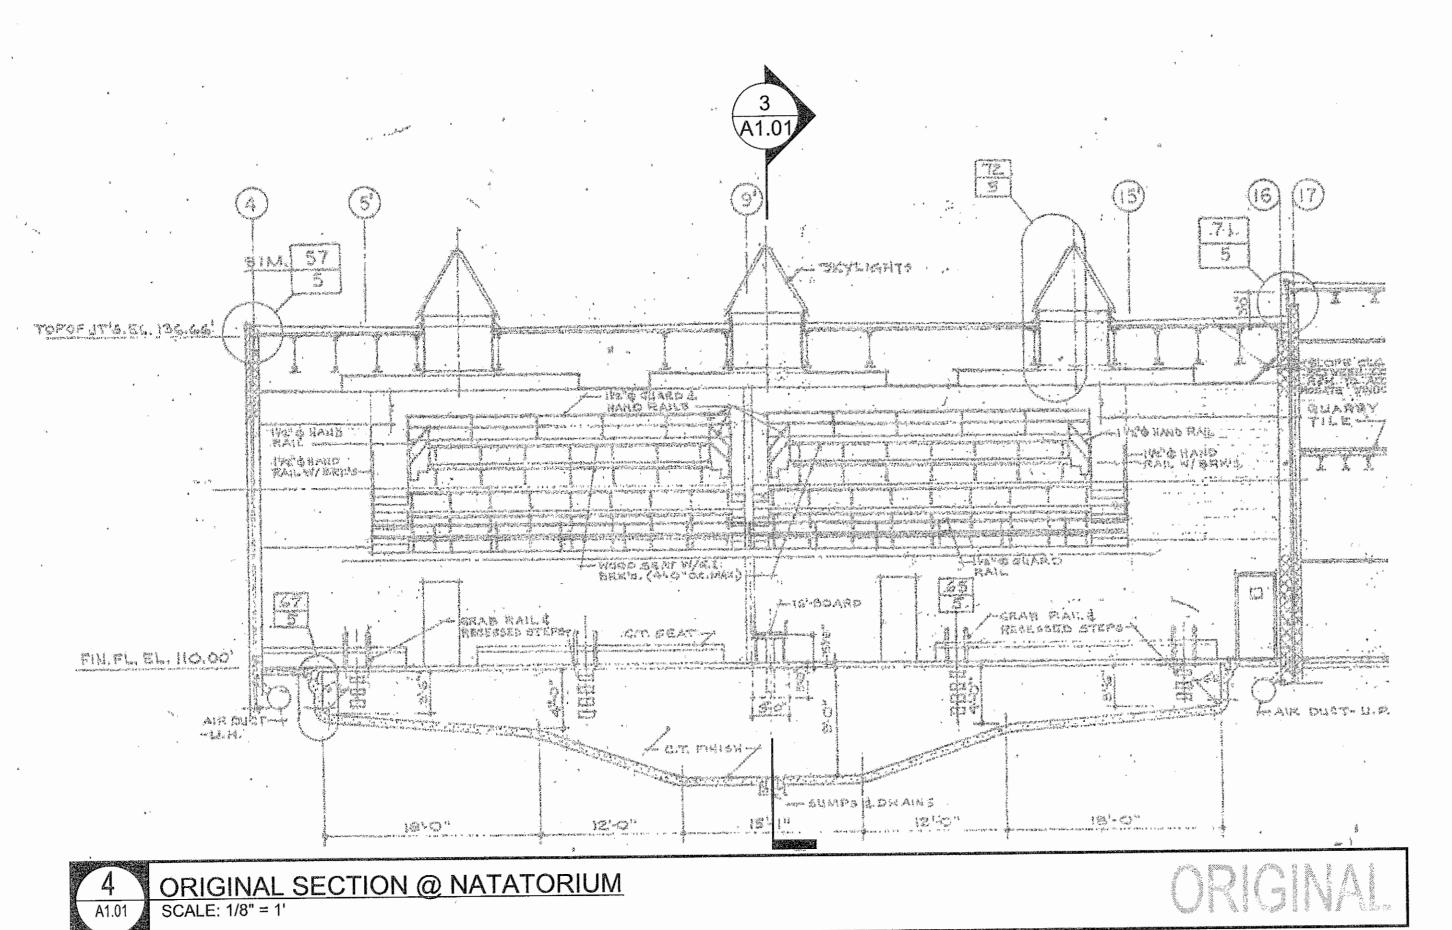
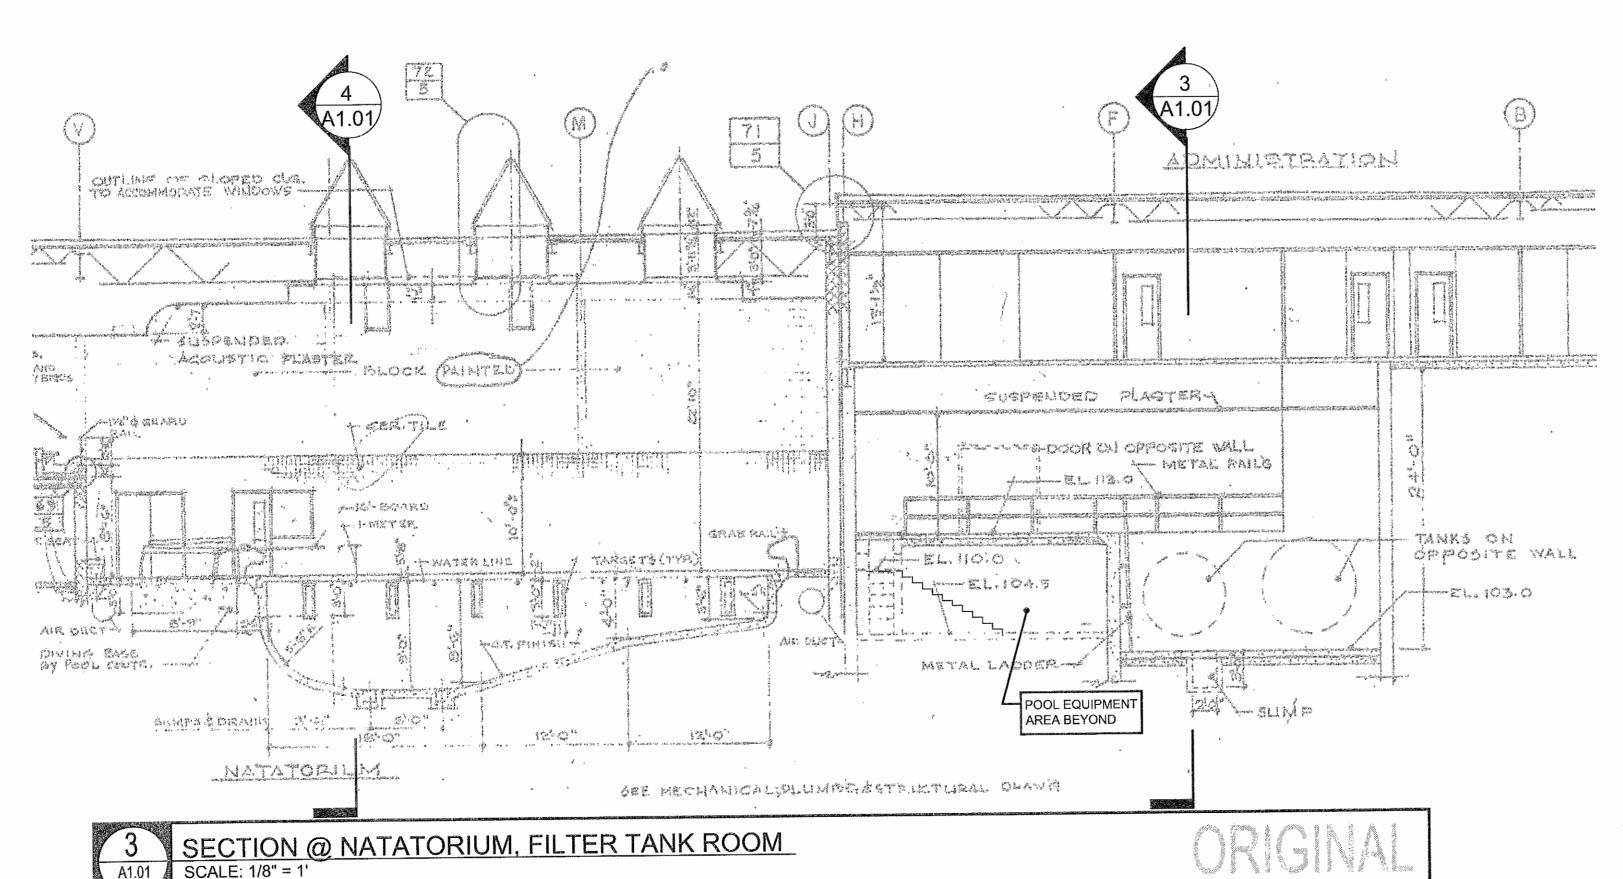


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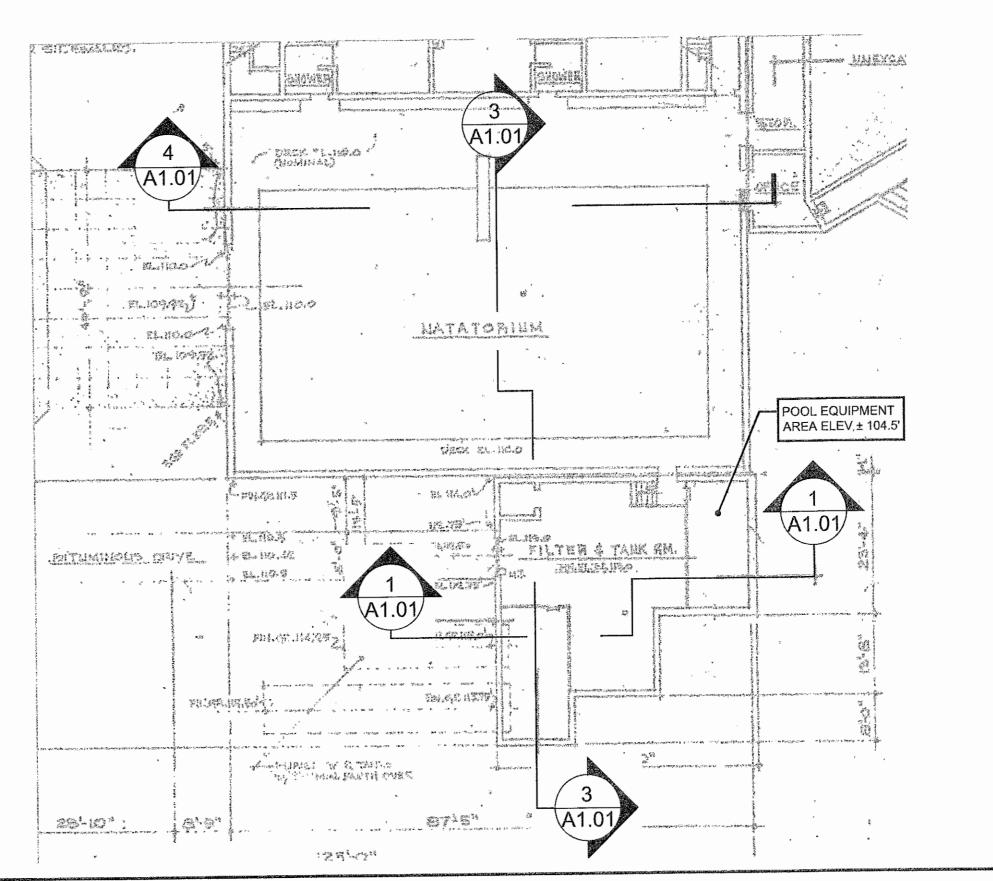
PURPOSE FOR ORIGINAL DRAWING INCLUSION: TO SHOW ORIGINAL CONDITIONS AND RELATIONSHIPS.

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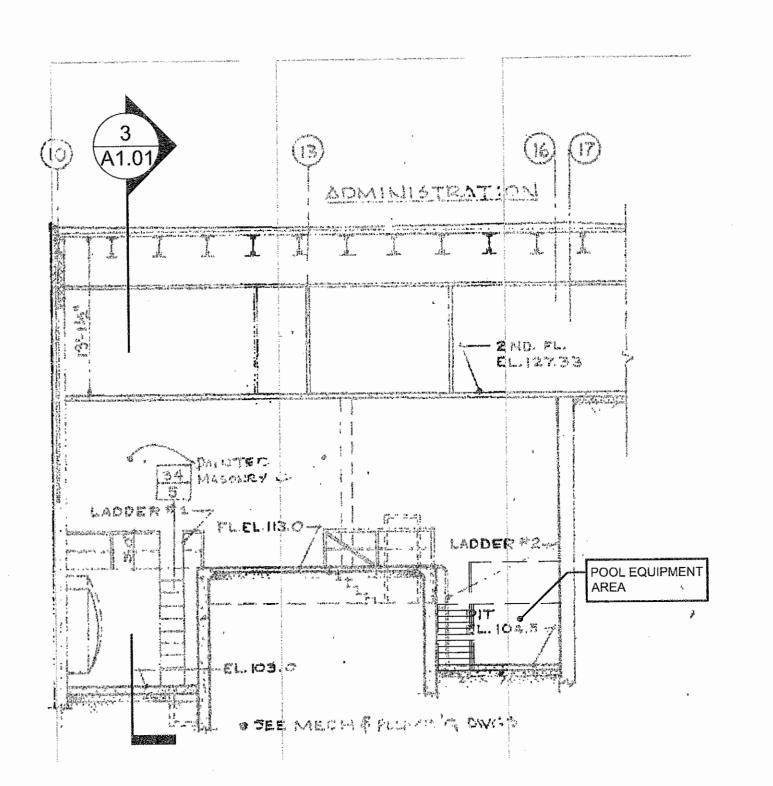


PLAN @ NATATORIUM, FILTER & TANK ROOM

SCALE: 1/8" = 1'

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SECTION @ FILTER & TANK ROOM
SCALE: 1/8" = 1'

@ FILTER & TANK ROOM_
I'

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ARCHITECT

9211 CORPORATE BLVD, SUITE 340
ROCKVILLE, MD 20850
301-770-0177(P) 301-330-3224(F)

STRUCTURAL

COMPREHENSIVE

STRUCTURAL SOLUTIONS

12410 MILESTONE CENTER DRIVE #600
GERMANTOWN, MD 20876
240-200-5599 (P)

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EXPIRATION DATE 03/27/18.

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3	100% SUBMISSION	1/25/18
4	BID SUBMISSION	2/5/18

NORTH HARFORD MIDDLE SCHOOL POOL REPAIR


112 PYLESVILLE ROAD PYLESVILLE, MD

ORIGINAL ARCHITECTURAL
CONSTR. DOCS FOR
REFERENCE: OVERALL
NATATORIUM LAYOUT

PROJECT NO.
17013

DATE
2/5/18

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3 PLUMBING PLAN
A1.02 SCALE: 1/8" = 1'

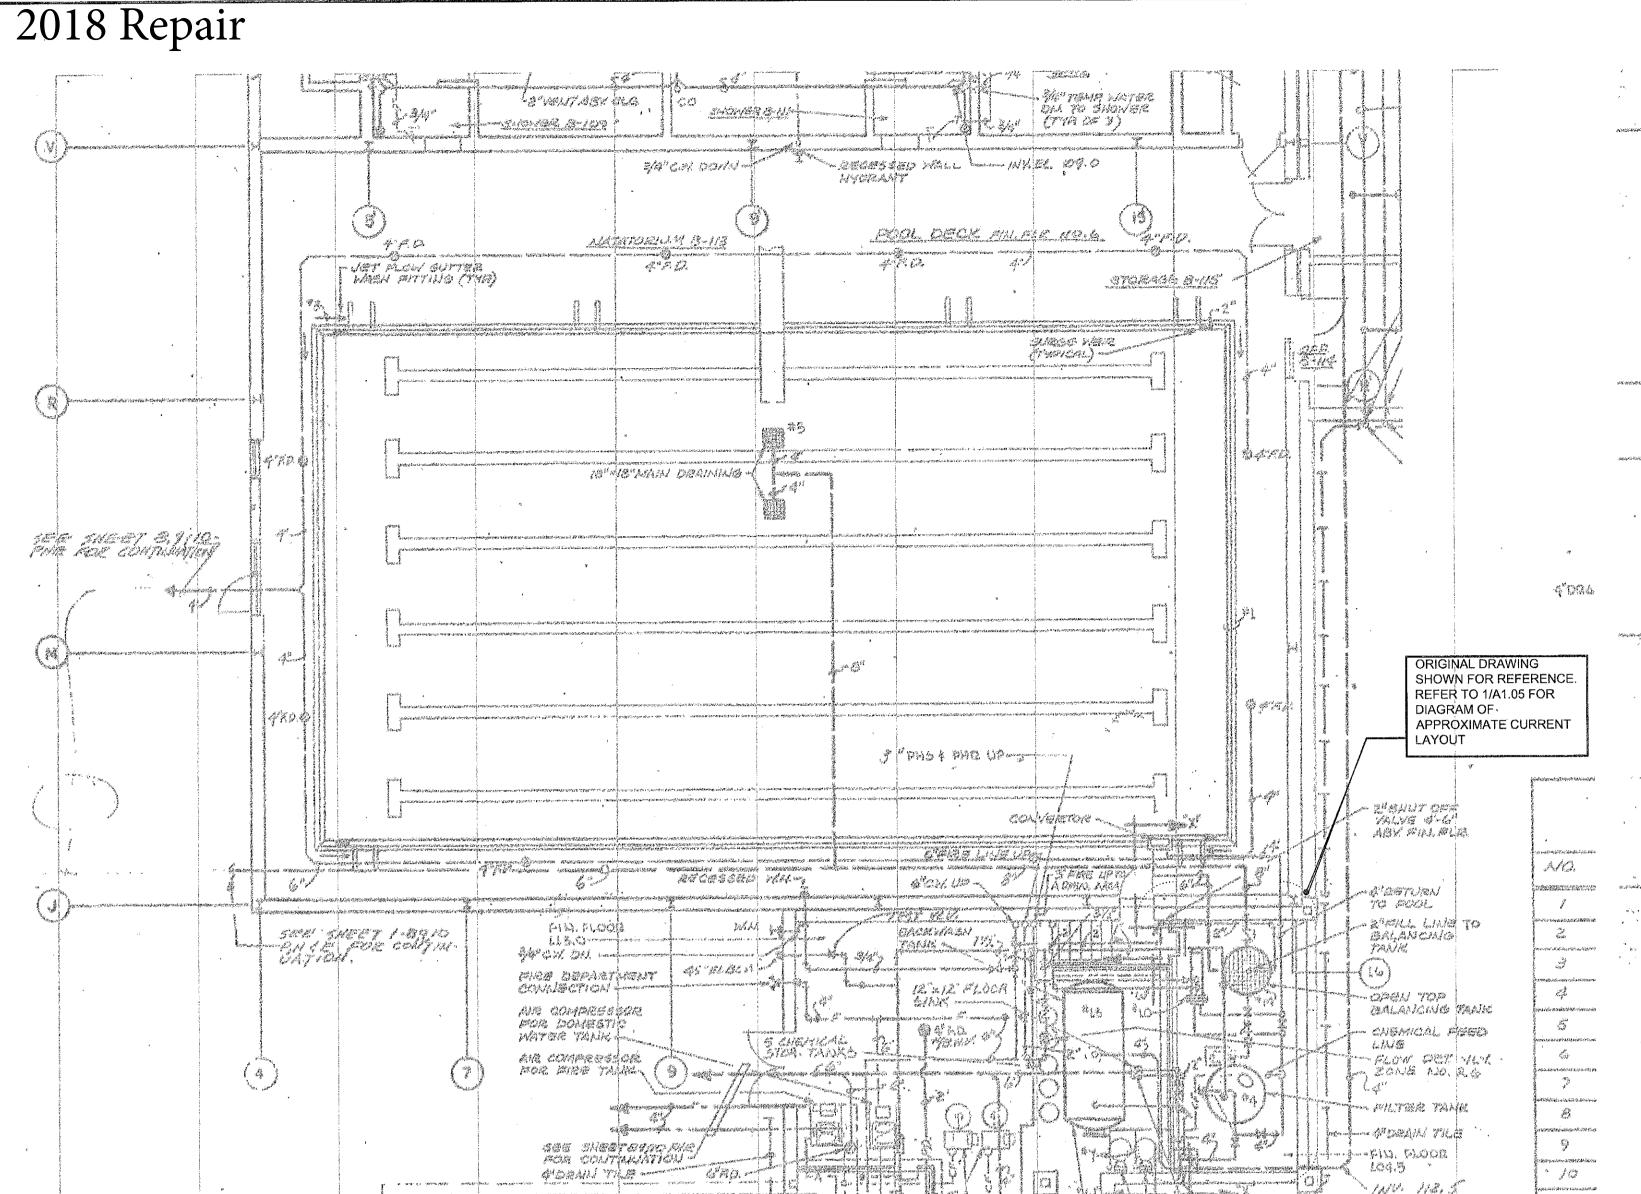ORGINAL

PURPOSE FOR ORIGINAL DRAWING INCLUSION: TO SHOW COMPLETE SYSTEM OF DECK DRAINS INCLUDING LOCATIONS AND RELATED PIPING.

NOTE 1: ORIGINAL DRAWINGS INCLUDED HEREIN ARE FOR REFERENCE AND SHALL NOT SUBSTITUTE FOR FIELD VERIFICATION IN AREAS OF PROPOSED WORK.

NOTE 2: IF DECK DRAIN SYSTEM IS DISTURBED, IT SHALL BE REPAIRED AND/OR PORTIONS REPLACED TO RETURN SYSTEM TO FULLY FUNCTIONAL CONDITION.

2 MECHANICAL PLAN
A1.02 SCALE: 1/8" = 1'

A1.02 SCALE: 1/8" = 1'

PURPOSE FOR ORIGINAL DRAWING INCLUSION: TO SHOW LOCATION OF BELOW DECK TRANSITE DUCT AIR SYSTEM. .

NOTE 1: ORIGINAL DRAWINGS INCLUDED HEREIN ARE FOR REFERENCE AND SHALL NOT SUBSTITUTE FOR FIELD VERIFICATION IN AREAS OF PROPOSED WORK.

PARTITION OF CHARACTER BOLL ATTOM OF CONTROL ASSESSMENT OF THE PROPERTY OF THE

1 DU

DUCT SECTION

SCALE: 3/8" = 1'

ORGNA!

PURPOSE FOR ORIGINAL DRAWING INCLUSION: TO SHOW APPROPRIATE LOCATION & CONFIGURATION OF ORIGINAL TRANSITE DUCT AIR SYSTEM.
NOTE 1: ORIGINAL DRAWINGS INCLUDED HEREIN ARE FOR REFERENCE AND SHALL NOT SUBSTITUTE FOR FIELD VERIFICATION IN AREAS OF
PROPOSED WORK.

NOTE 2: REPLACEMENT OF POOL PIPING IS INTENDED TO BE COMPLETED WITHOUT DISTURBING THE TRANSITE RETURN AIR DUCT. IF TRANSITE DUCT IS DISTURBED, CONTRACTOR SHALL NOTIFY HARFORD COUNTY SCHOOL SYSTEM TO DETERMINE IF CONTAINMENT OR MITIGATION MEASURES ARE REQUIRED.

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NORTH HARFORD MIDDLE SCHOOL POOL REPAIR

112 PYLESVILLE ROAD PYLESVILLE, MD


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ORIGINAL
MECHANICAL & PLUMBING
CONSTRUCTION DOCS


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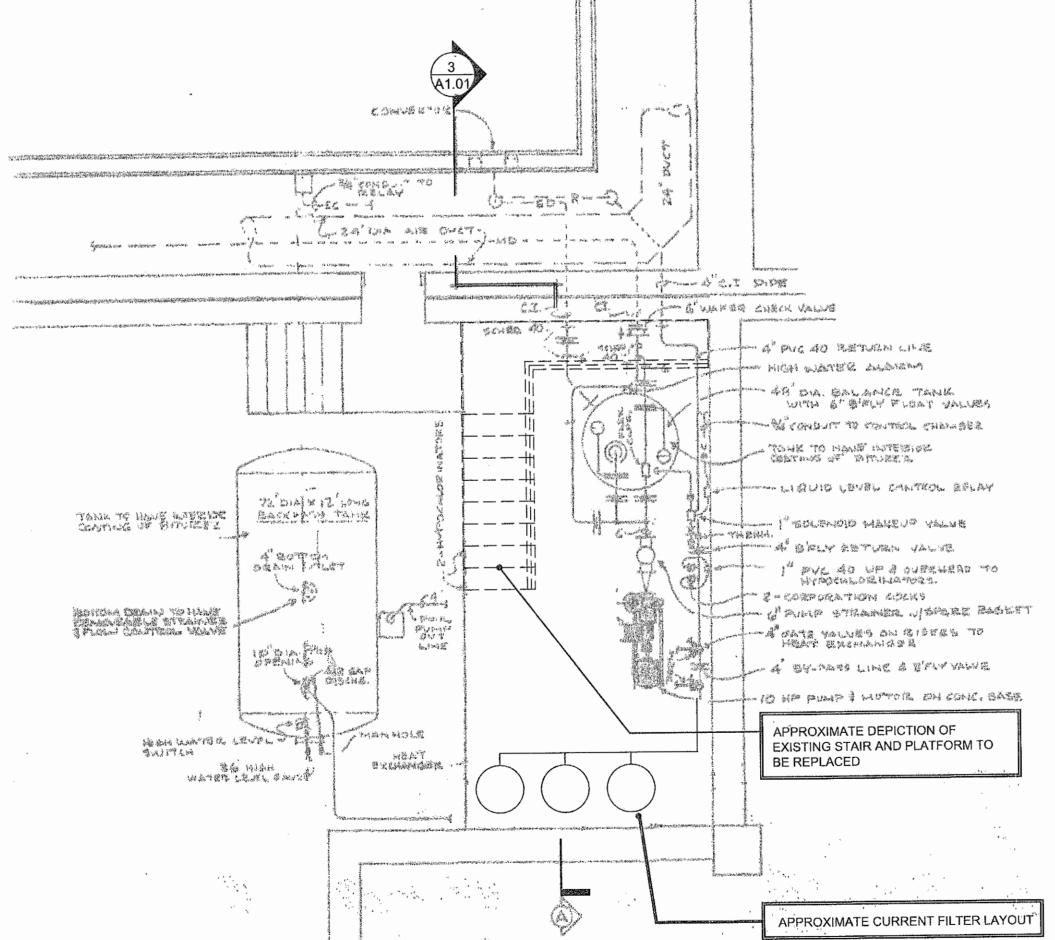
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ORIGINAL CONVERTER ISOMETRIC

SCALE: 1" = 1'

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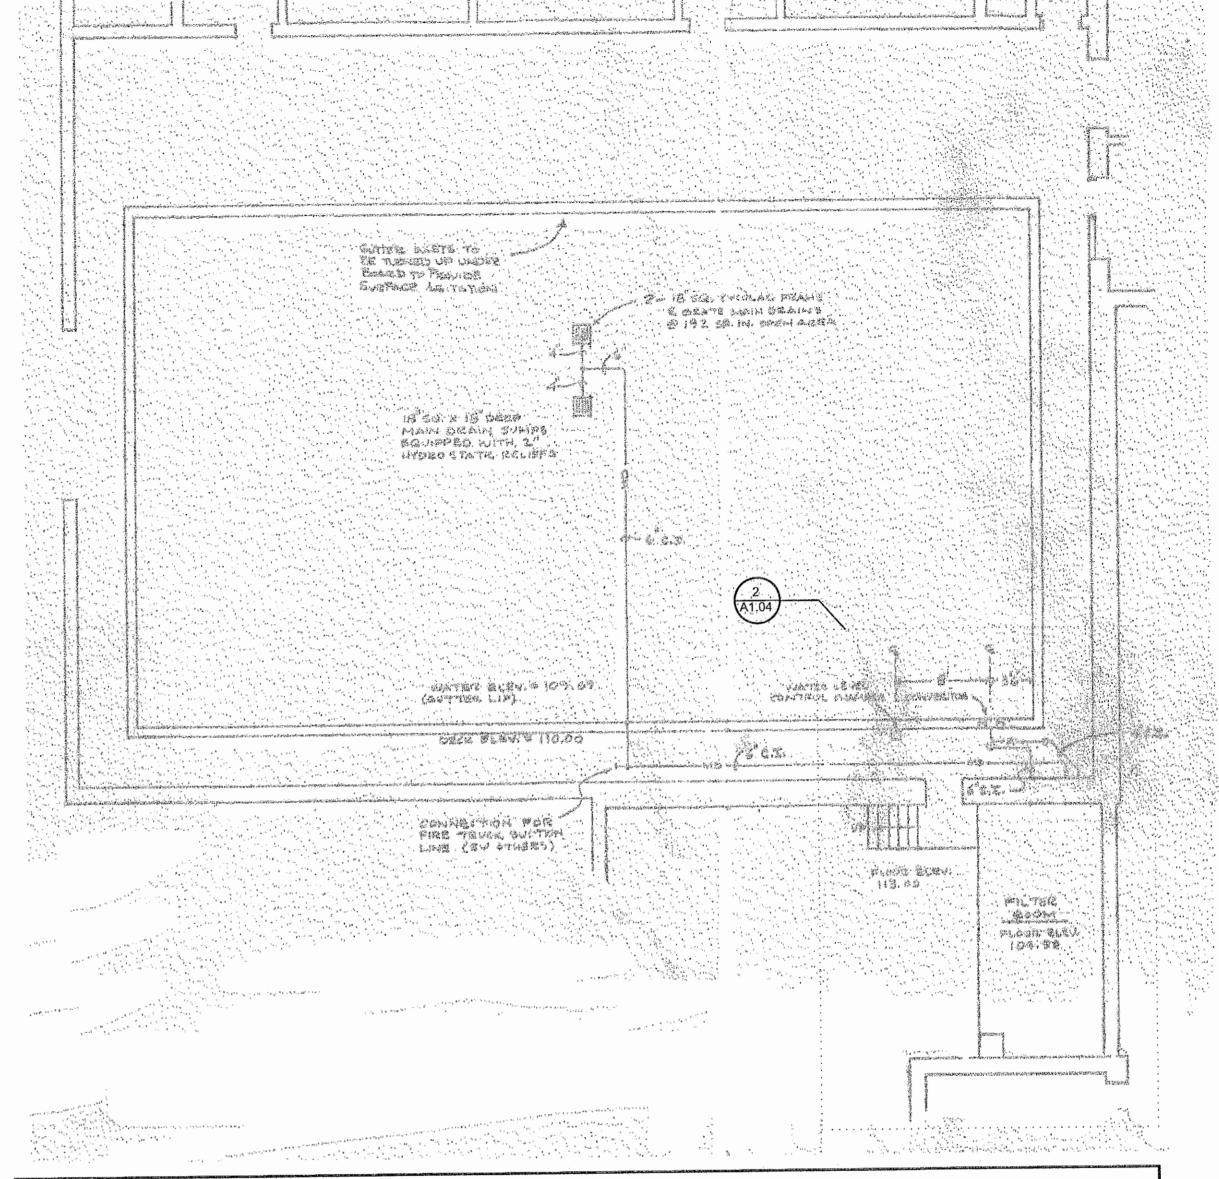


WORK.

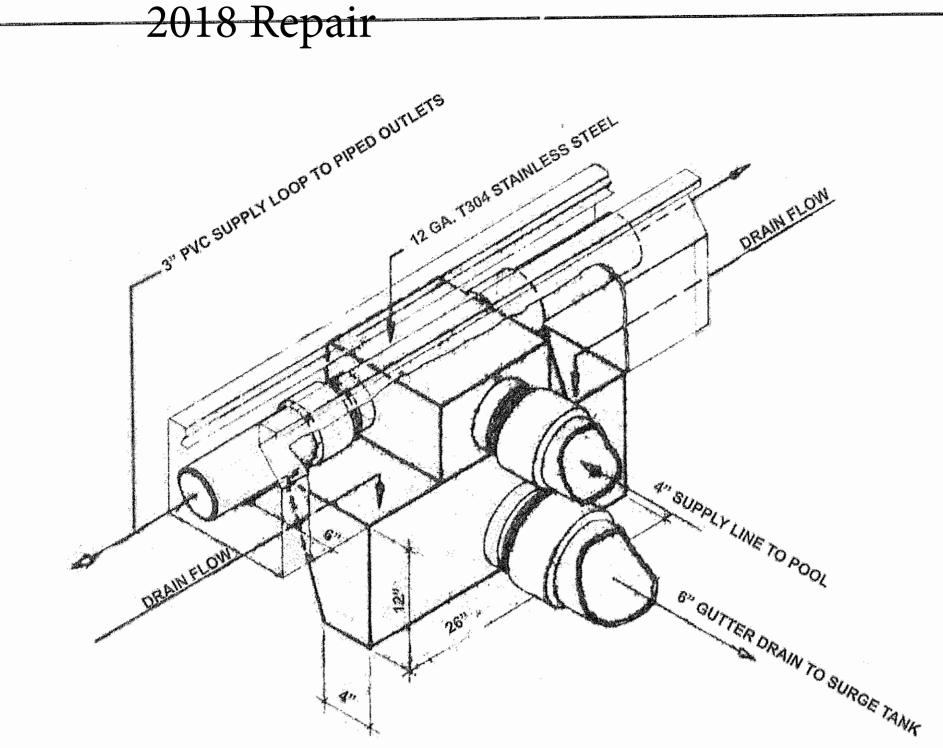2 EXISTING FILTER ROOM PLAN
SCALE: 1/4" = 1'

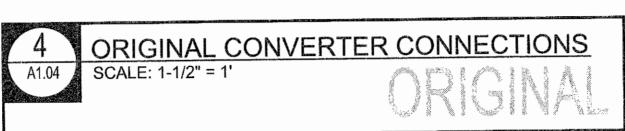PURPOSE FOR ORIGINAL DRAWING INCLUSION: TO SHOW ORIGINAL CONDITIONS AND RELATIONSHIPS.


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3 EXISTING POOL PIPING PLAN
A1.04 SCALE: 1/8" = 1'

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1 EXISTING MECHANICAL SECTION

SCALE: 1/4" = 1'

ORIGINAL

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NORTH HARFORD MIDDLE SCHOOL POOL REPAIR

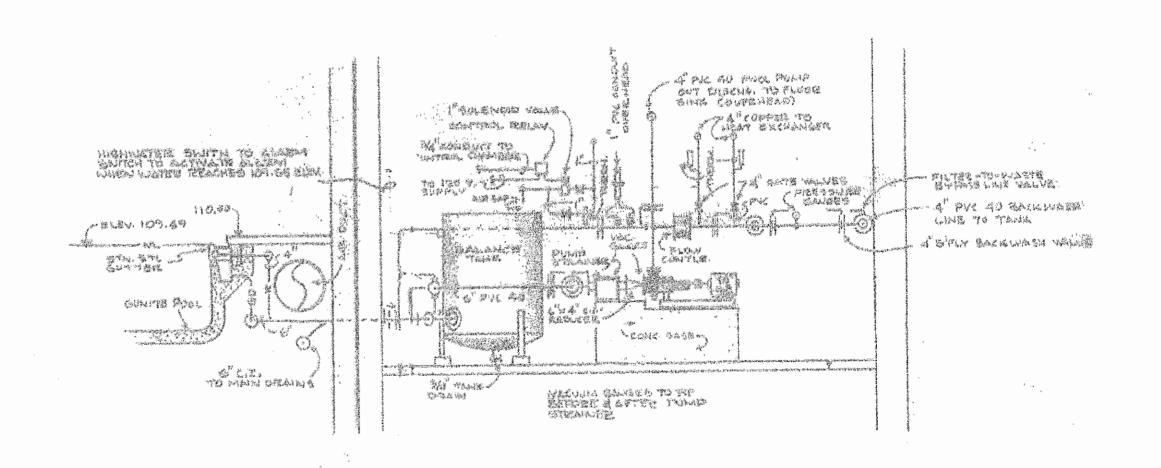112 PYLESVILLE ROAD PYLESVILLE, MD

FOR REFERENCE


ORIGINAL POOL MECHANICAL

PROJECT NO. 17013 DATE

2/5/18

SCALE
AS NOTED
SHEET NO.

SHEET TITLE

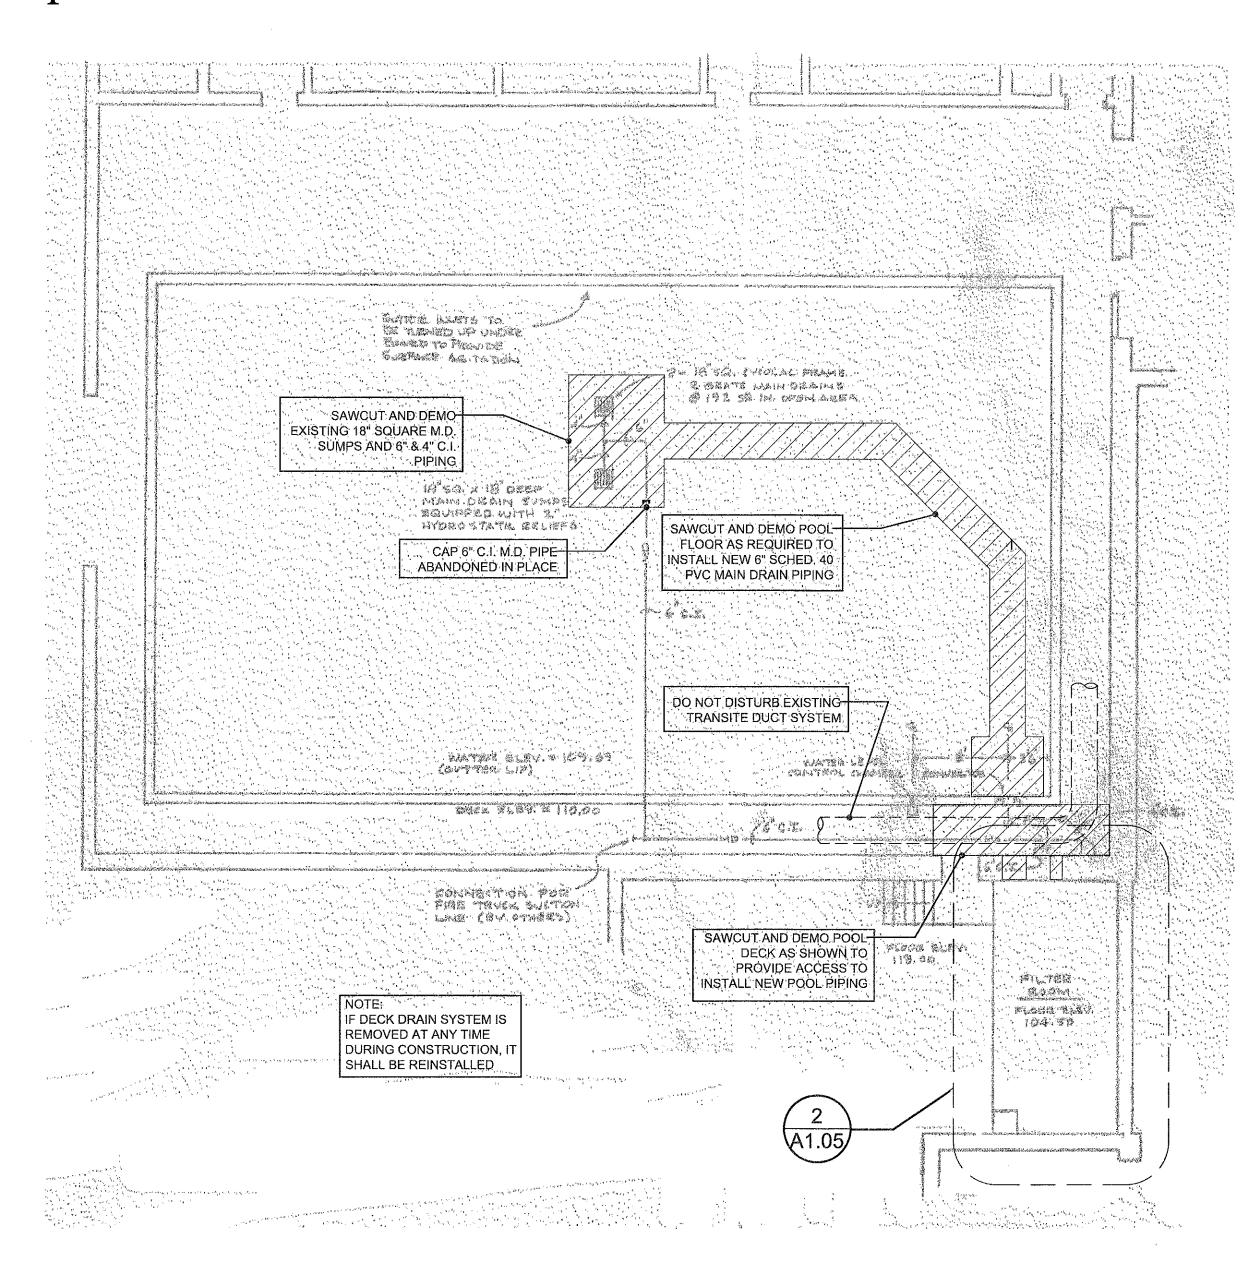




EXISTING POOL PIPING PLAN - DEMOLITION SCALE: 1/8" = 1'

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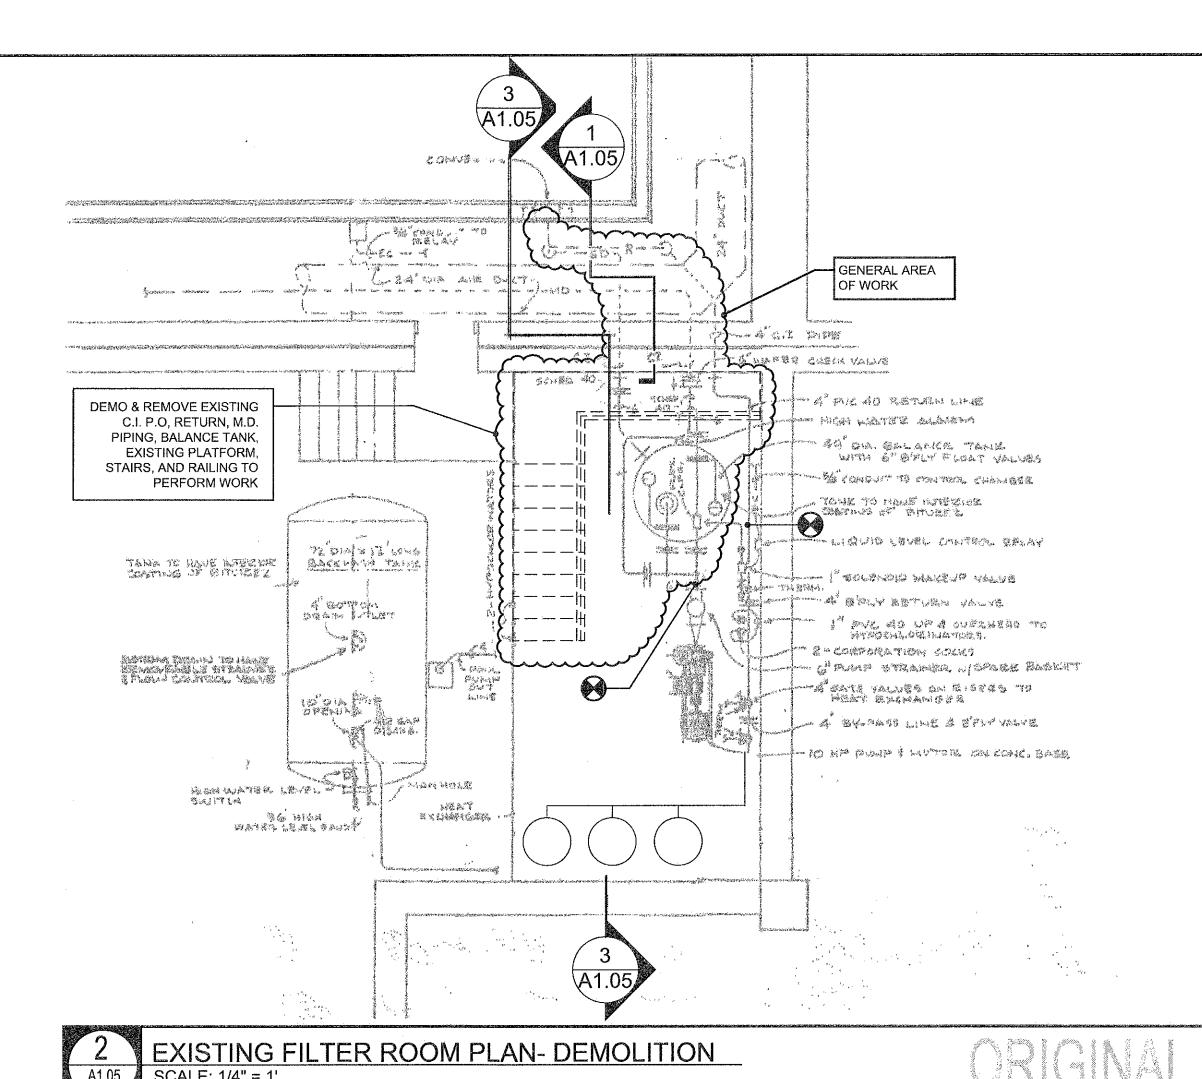


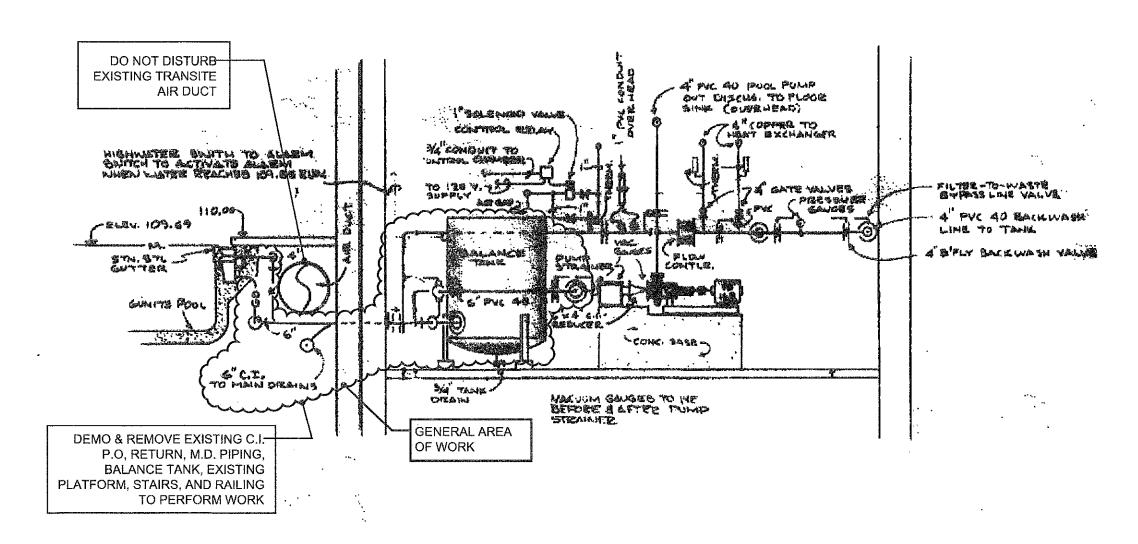

EXISTING MECHANICAL SECTION - DEMOLITION SCALE: 1/4" = 1'


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POOL REPAIR

112 PYLESVILLE ROAD PYLESVILLE, MD

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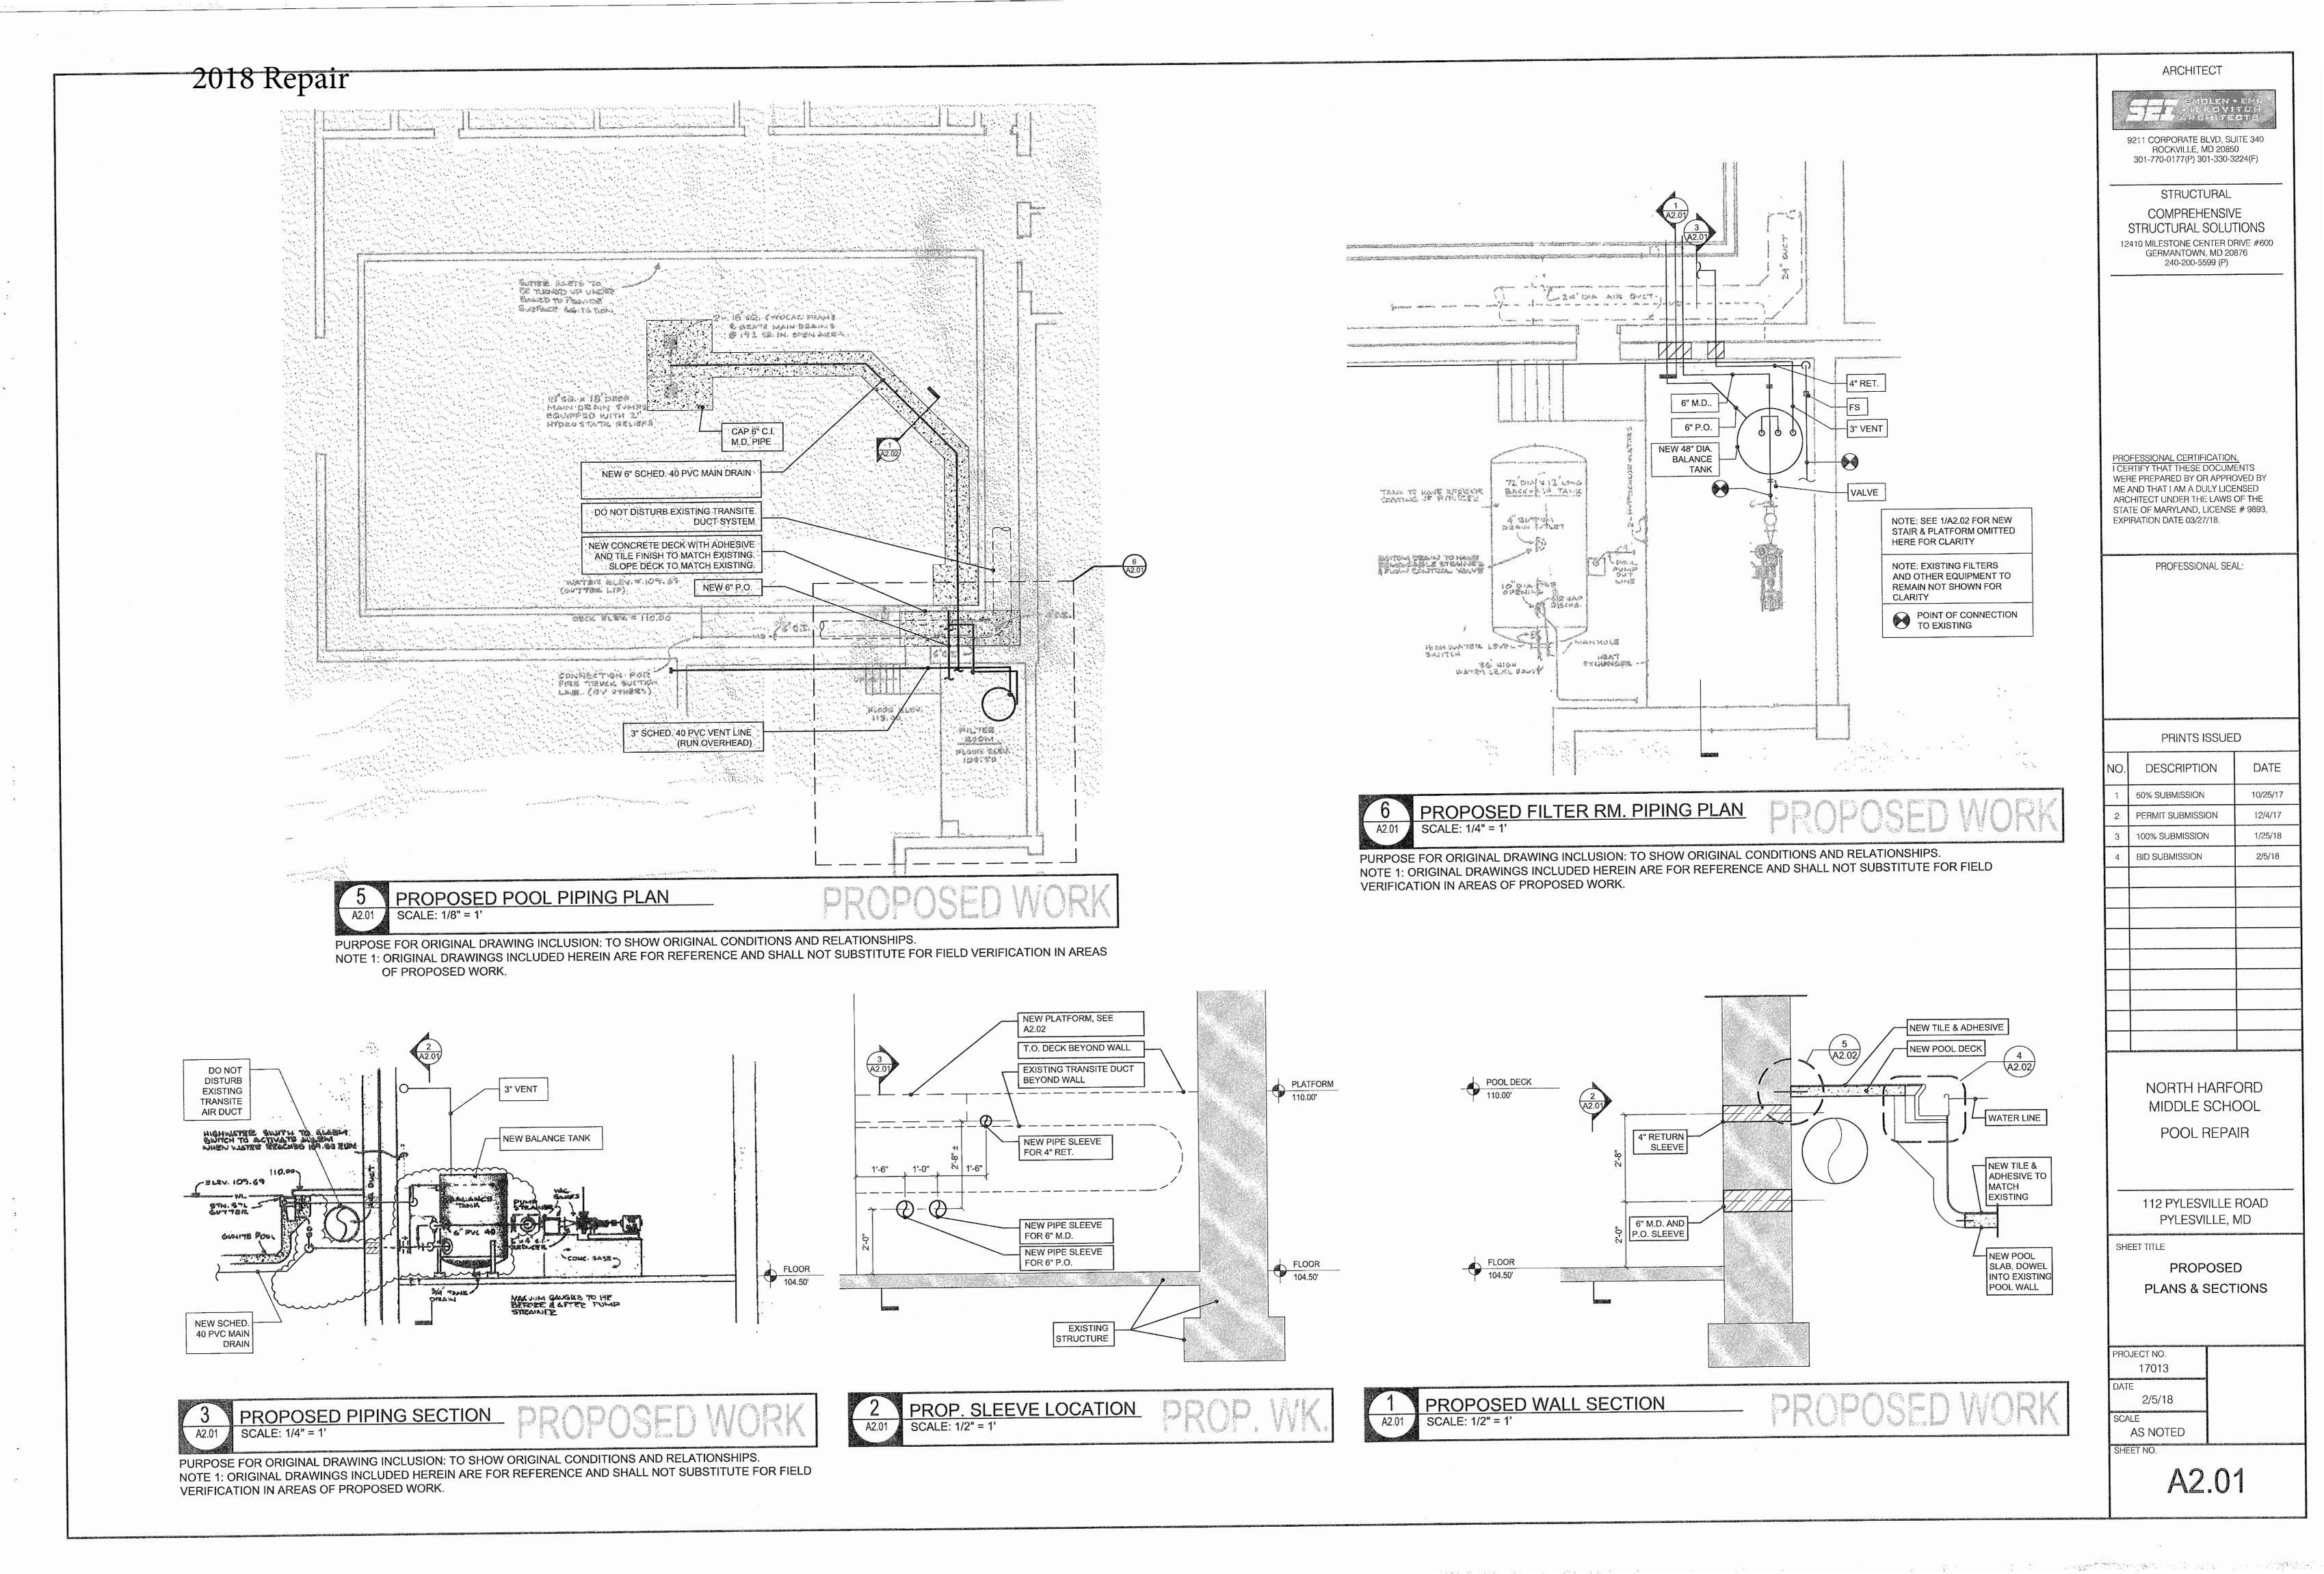
DEMOLITION PLAN


PROJECT NO. 17013 DATE 2/5/18

SCALE

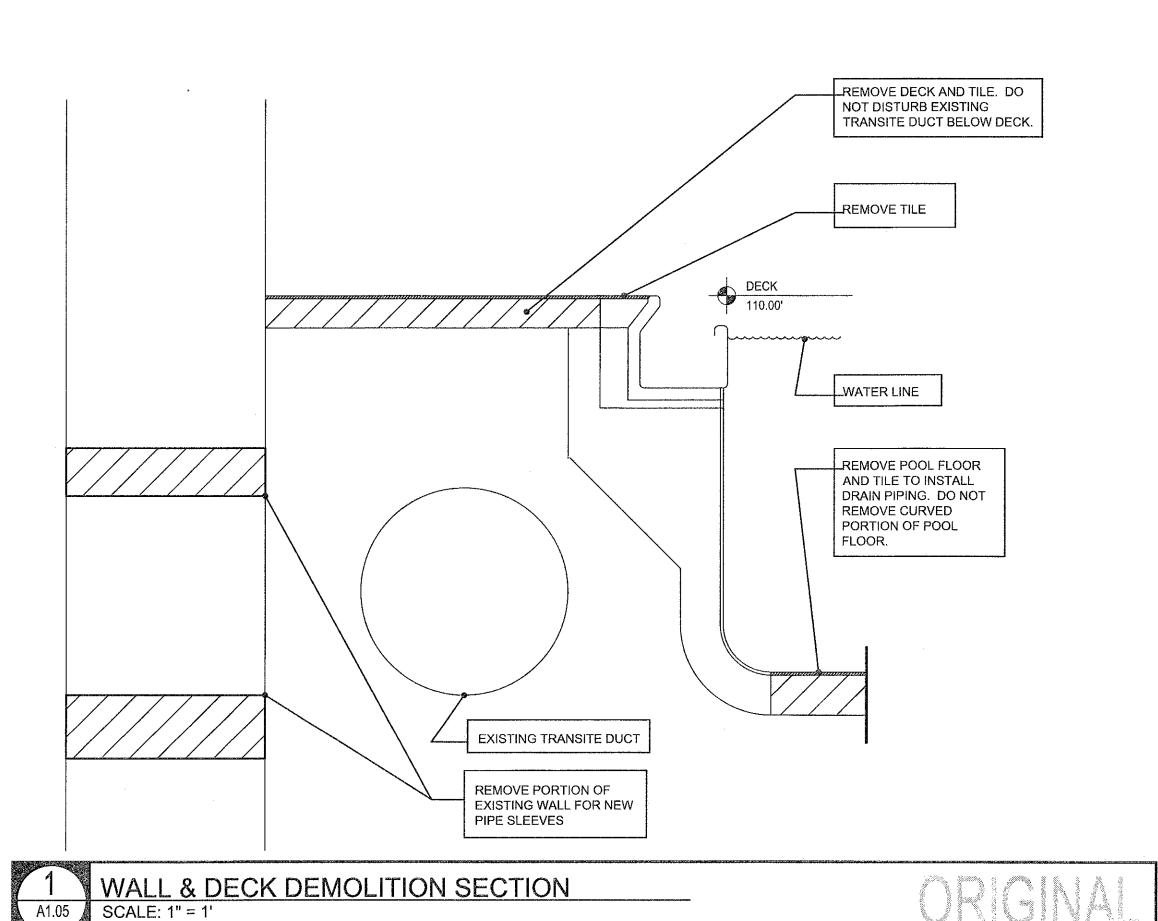AS NOTED

SHEET NO.



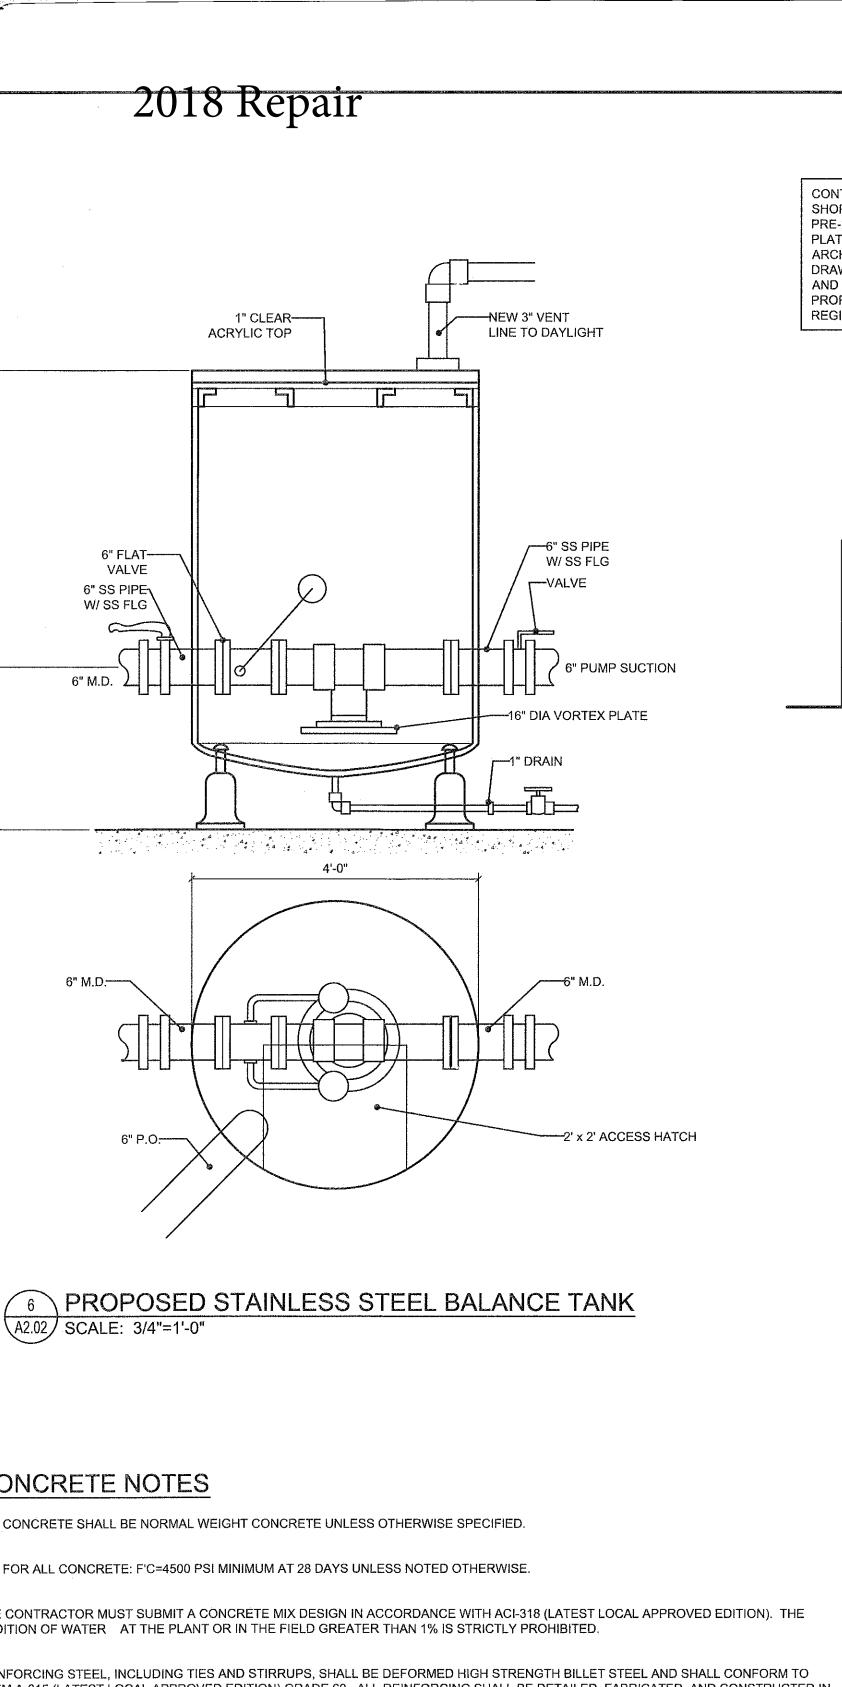

CONCRETE NOTES

ALL CONCRETE SHALL BE NORMAL WEIGHT CONCRETE UNLESS OTHERWISE SPECIFIED.

FOR ALL CONCRETE: F'C=4500 PSI MINIMUM AT 28 DAYS UNLESS NOTED OTHERWISE.

THE CONTRACTOR MUST SUBMIT A CONCRETE MIX DESIGN IN ACCORDANCE WITH ACI-318 (LATEST LOCAL APPROVED EDITION). THE ADDITION OF WATER AT THE PLANT OR IN THE FIELD GREATER THAN 1% IS STRICTLY PROHIBITED.

REINFORCING STEEL, INCLUDING TIES AND STIRRUPS, SHALL BE DEFORMED HIGH STRENGTH BILLET STEEL AND SHALL CONFORM TO ASTM A-615 (LATEST LOCAL APPROVED EDITION) GRADE 60. ALL REINFORCING SHALL BE DETAILED, FABRICATED, AND CONSTRUCTED IN ACCORDANCE WITH THE ACI "MANUAL OF STANDARD PRACTICE FOR DETAILING CONCRETE STRUCTURES" (ACI-315, LATEST LOCAL APPROVED EDITION).

ALL REINFORCING SPLICES SHALL BE CLASS "B" SPLICES IN ACCORDANCE WITH ACI-318 (LATEST LOCAL APPROVED EDITION) UNLESS OTHERWISE NOTED. UNLESS NOTED OTHERWISE, HORIZONTAL WALL REINFORCING SHALL BE BENT AROUND CORNERS AND EXTEND 1'-0" MINIMUM INTO ADJACENT CONSTRUCTION. PROVIDE 4'-0" LONG CORNER BARS TO MATCH HORIZONTAL REINFORCING.

UNLESS OTHERWISE SPECIFIED, PROVIDE THE FOLLOWING MINIMUM CONCRETE PROTECTION:

CAST AGAINST EARTH

EXPOSED TO EARTH OR WEATHER #5 AND SMALLER BARS


#6 AND LARGER BARS

NOT EXPOSED TO EARTH OR WEATHER

SLABS, WALLS, JOISTS

BEAMS, GIRDERS, COLUMNS 1-1/2" TO TIES, STIRRUPS, OR SPIRALS

ALL CONCRETE WORK SHALL CONFORM TO THE LATEST CODE APPROVED EDITIONS OF THE ACI AND ASTM SPECIFICATIONS.

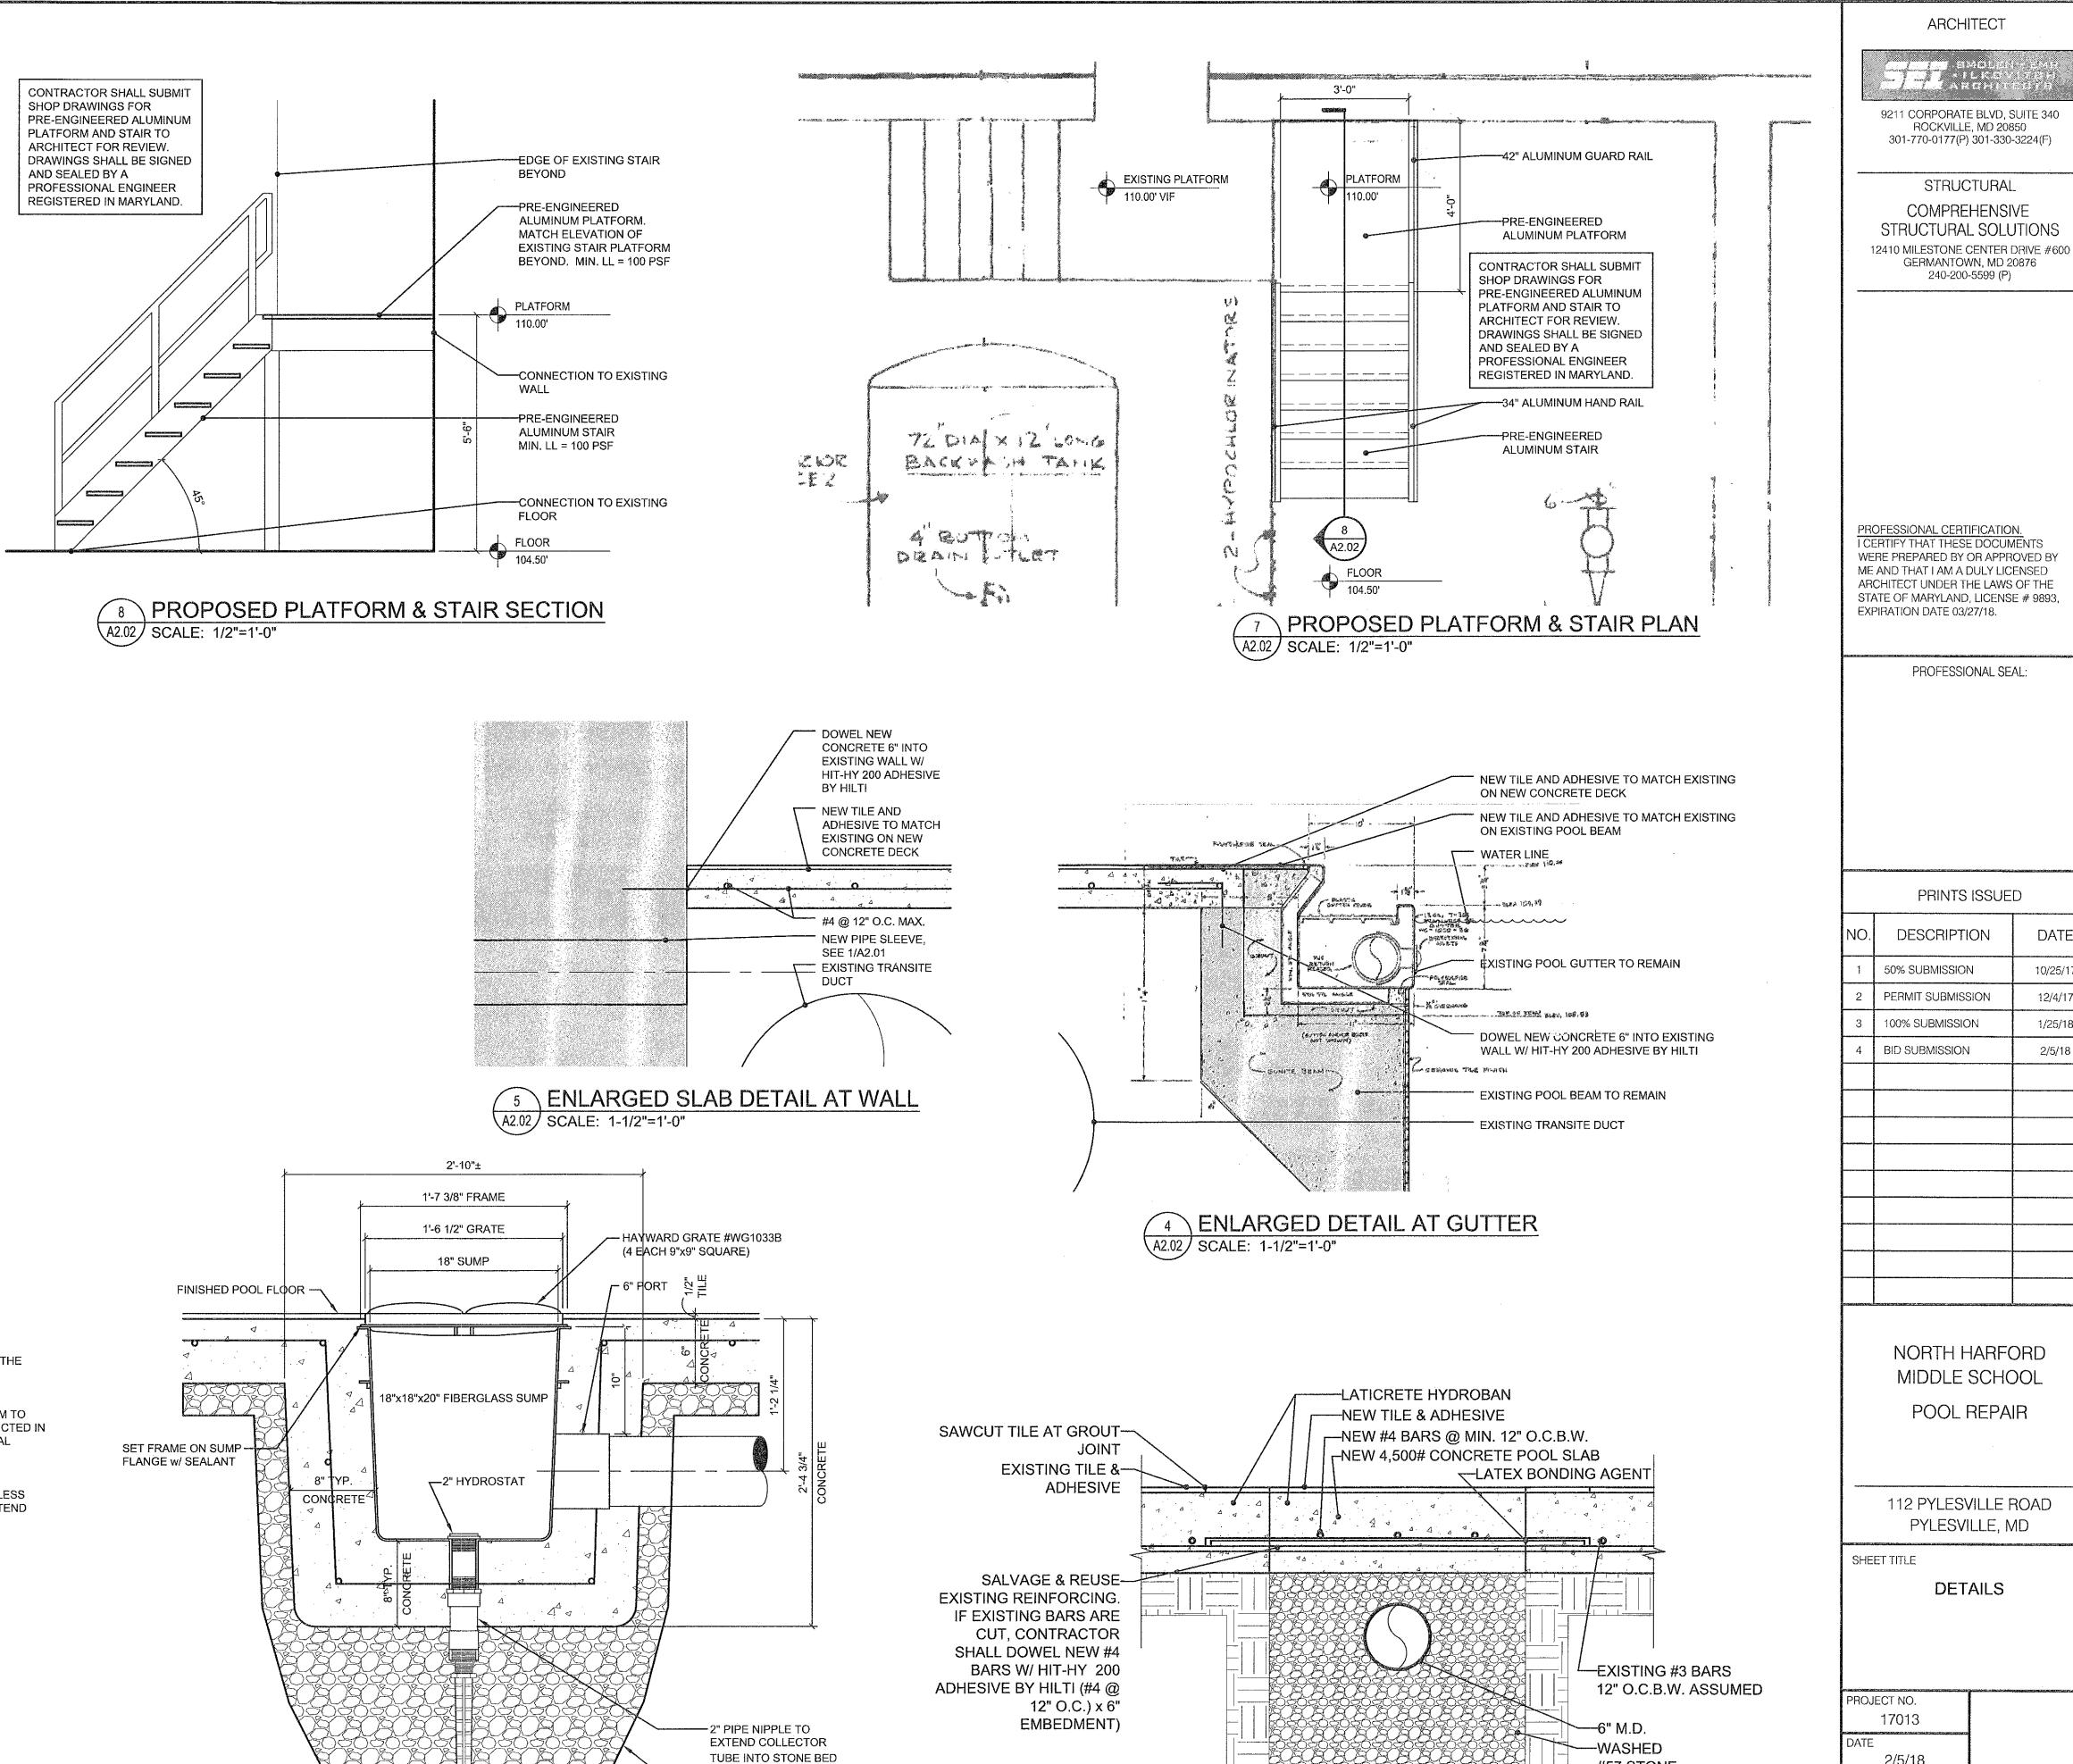

NOMINAL 16" GRAVEL @ HYDROSTAT COLLECTORS

ASA MODEL #FPK-50-818-6 (SUMP)

2 PROPOSED MAIN DRAIN DETAIL

A2.02 | SCALE: 1-1/2"=1'-0"

2/5/18

2/5/18

AS NOTED

A2.02

SHEET NO.

#57 STONE

24" ±

A2.02 | SCALE: 1-1/2"=1'-0"


PROPOSED MAIN DRAIN PIPING DETAIL

NORTH HARFORD MIDDLE SCHOOL POOL REPAIR

HARFORD COUNTY PUBLIC SCHOOLS

112 PYLESVILLE ROAD PYLESVILLE, MARYLAND 21132

BID SUBMISSION BID # HRM 18-1 FEBRUARY 5, 2018

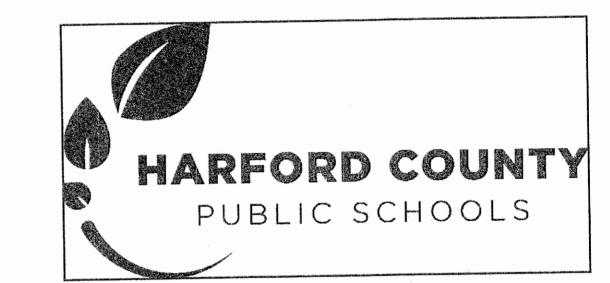

INDEX OF DRAWINGS

COVER SHEET

ARCHITECTURAL

A1.01 ORGINAL ARCHITECTURAL CONSTR. DOCS FOR REFERENCE:
OVERALL NATATORIUM LAYOUT

ORIGINAL MECHANICAL & PLUMBING CONSTRUCTION DOCS

FOR REFERENCE

A1.03 ORIGNIAL POOL PLANS & SECTIONS CONSTRUCTION DOCS

FOR REFERENCE

A1.04 ORIGINAL POOL MECHANICAL FOR REFERENCE

A1.05 DEMOLITION PLAN
A2.01 PROPOSED PLANS & SECTIONS

A2.02 DETAILS

GENERAL NOTES AND CONDITIONS

1. ALL WORK SHALL BE DONE IN ACCORDANCE WITH ALL APPLICABLE CODES, ORDINANCES, REGULATIONS AND REQUIREMENTS OF ALL AGENCIES HAVING JURISDICTION OVER THE PROJECT.

2. THE CONTRACTOR IS CAUTIONED THAT HIS OR HER WORK INCLUDES ALTERATIONS TO AN EXISTING FACILITY. THE GENERAL CONTRACTOR AND/OR SUBCONTRACTORS (HEREAFTER REFERRED TO AS "CONTRACTOR") SHALL VISIT THE SITE TO DETERMINE ACTUAL FIELD CONDITIONS, AND CHECK THE ACCURACY OF THE GIVEN. FAILURE TO DO SO WILL NOT RELIEVE THEM OF THE RESPONSIBILITY FOR CARRYING OUT ANY AND ALL WORK SHOWN, NOTED OR

 THE INTENT OF THESE DRAWINGS IS FOR THE CONTRACTOR TO PROVIDE ALL LABOR, MATERIAL, FINISHES, EQUIPMENT, INSTALLATION AND SERVICES NECESSARY FOR AND INCIDENTAL WITH THE WORK, TO PROVIDE THE OWNER WITH A "TURN KEY" COMPLETE PROJECT.

4. ACTUAL FIELD CONDITIONS MAY VARY FROM THOSE INDICATED. SHOULD ACTUAL CONDITIONS DIFFER MATERIALLY FROM THOSE ORDINARILY ENCOUNTERED AND GENERALLY RECOGNIZED AS INHERENT IN WORK OF THE CONTRACTOR PROVIDED FOR IN THE CONTRACT, THE CONTRACTOR SHALL PROMPTLY, BEFORE CONDITIONS ARE DISTURBED, NOTIFY THE ARCHITECT. FAILURE TO DO SO MAY WAIVE THE CONTRACTOR'S RIGHT TO RECEIVE ADDITIONAL TIME OR CONSIDERATION DUE TO SUCH CONDITIONS.

5. PRIOR TO INITIATING ANY PORTION OF THE WORK, THE CONTRACTOR SHALL VERIFY ALL DIMENSIONS INCLUDING CEILING HEIGHT AVAILABILITY AND COORDINATE ALL PORTIONS OF THE CONTRACT DOCUMENTS RELATING TO THAT PORTION OF THE WORK AND AFFECTING ADJOINING PORTIONS. IF DISCREPANCIES EXIST, THEY SHALL BE REPORTED TO THE ARCHITECT FOR CLARIFICATION AND/OR RESOLUTION BEFORE COMMENCING SUCH WORK.

6. THE CONTRACTOR SHALL PREPARE A CONSTRUCTION SCHEDULE. THE CONTRACTOR IS ALSO TO INDICATE EVENTS IN THE SCHEDULE THAT MAY CAUSE INTERRUPTIONS TO THE NORMAL DAILY ACTIVITIES OF THE BUILDING. THESE EVENTS ARE TO BE COORDINATED TO THE SATISFACTION OF THE BUILDING REPRESENTATIVES AND THE ARCHITECT.

'. DEFINITIONS: "PROVIDE" MEANS "FURNISH AND INSTALL". "VERIFY" MEANS "VERIFY IN THE FIELD AND COORDINATE DIMENSIONS AND DISCREPANCIES".

8. THESE NOTES AND OTHER NOTES ON THE DRAWINGS ARE DIRECTIONS FOR THE CONTRACTOR'S PERFORMANCE, UNLESS NOTED OTHERWISE (U.N.O.). FOR EXAMPLE, "INSTALL" MEANS "CONTRACTOR SHALL INSTALL", "RELOCATE" MEANS "CONTRACTOR SHALL RELOCATE", ETC.

DIMENSIONS SHOWN ARE TO FACE OF STUD, U.N.O. NUMBERED DIMENSIONS SHOWN ON THE DRAWINGS TAKE PRECEDENCE OVER SCALED DRAWINGS. DETAIL DRAWINGS TAKE PRECEDENCE OVER GENERAL DRAWINGS. IF CONFLICT EXISTS ON THE DRAWINGS, THEN THE MORE STRINGENT REQUIREMENT SHALL APPLY.

). SAMPLES AND SUBMITTALS MUST BE SUBMITTED BY THE CONTRACTOR TO THE ARCHITECT BEFORE THE PURCHASE OR FABRICATION OF ANY MATERIALS.

11. DIMENSIONS OF EXISTING OPENINGS SHALL BE VERIFIED PRIOR TO PREPARATION OF SHOP DRAWINGS. SHOP DRAWINGS SHALL INCLUDE A SCHEDULE OF ACTUAL OPENING DIMENSIONS AS VERIFIED IN FIELD.

DURING THE WORK, ANY CONDITION UNCOVERED THAT CAUSES CONFLICT WITH THE INTENDED DESIGN MUST BE IMMEDIATELY BROUGHT TO THE ATTENTION OF THE ARCHITECT.
 CONTRACTOR SHALL STAGE WORK IN SUCH A WAY AS TO ENSURE SAFE EMERGENCY EGRESS AT

ALL TIMES.

14. EXCEPT FOR PREFINISHED SURFACES, ALL ITEMS DISTURBED OR DAMAGED BY WORK SHALL BE

14. EXCEPT FOR PREFINISHED SURFACES, ALL TIEMS DISTORDED ON DAMINGED OF WORKERS AND REFINISHED TO MATCH SURROUNDING AREA OR FINISHED AS INDICATED.

15. REPAIRED AND NEW AREAS OF WALLS OR CEILINGS SHALL BE BLENDED AND FEATHERED INTO THE SURROUNDING AREA. THERE SHALL NOT BE ANY VISIBLE SEAMS OR CHANGE IN APPEARANCE

BETWEEN THE REPAIRED OR NEW AREA AND THE SURROUNDING AREA WHEN VIEWED FROM A DISTANCE OF 3 FEET.

16. ALL NEW AND EXISTING HOLES AND PENETRATIONS IN WALLS AND CEILING SURFACES SHALL BE PATCHED AND FIRE STOPPED.

THE FLOOR SPACE WILL BE UNOCCUPIED AT THE TIME OF WORK & SHALL BE SECURED AT THE END 31. (

18. BEFORE COMMENCING ANY DEMOLITION, THE CONTRACTOR MUST COORDINATE DEMOLITION WITH OTHER DISCIPLINES.

IF APPLICABLE, REMOVE OBVIOUS ABANDONED EXPOSED WIRING, CONDUITS, PIPING IN THE SPACE, WHICH IS NOT PART OF WORK. PRIOR TO REMOVAL, COORDINATE WITH THE OWNER THESE ITEMS THAT MAY BE PLANNED TO BE REUSED/READAPTED FOR OWNER OR TENANT FUTURE USE.
 LICENSED MECHANICAL, PLUMBING, & ELECTRICAL CONTRACTORS TO PULL SEPARATE TRADE

PERMITS FOR ALL NEW WORK AS REQUIRED BY THE LOCAL JURISDICTION.

21. PROVIDE SHOP DRAWINGS TO THE ARCHITECT FOR APPROVAL FOR PRE-ENGINEERED, CUSTOM, OR SPECIALTY WORK. THE OWNER RESERVES THE RIGHT TO WAIVE THIS REQUIREMENT.

22. CONTRACTOR TO GUARANTEE ALL WORK FOR A PERIOD OF TWO YEARS FROM THE DATE OF

23. THE ARCHITECT SHALL HAVE NO RESPONSIBILITY FOR THE DISCOVERY, PRESENCE, HANDLING,
REMOVAL OR DISPOSAL OF, OR EXPOSURE OF PERSONS TO HAZARDOUS MATERIALS IN ANY FORM
AT THE PROJECT SITE, INCLUDING BUT NOT LIMITED TO ASBESTOS, ASBESTOS PRODUCTS,
POLYCHLORINATED BIPHENYL (PCB) OR OTHER TOXIC SUBSTANCES. CONTRACTOR TO CONTACT
OWNER IF THESE ITEMS ARE APPARENT.

24. ANY ALTERATION TO THE STRUCTURE (I.E., CORE BUILDING CONCRETE FOR PLUMBING, ETC.)
SHALL BE COORDINATED AND APPROVED BY THE BUILDING OWNER'S REPRESENTATIVE.

25. IF THERE ARE OPERATIONS WHICH INVOLVE EXCESSIVE NOISE (I.E., SAW CUTTING CONCRETE, ETC.) IT SHALL BE COORDINATED WITH THE OWNER TO BE PERFORMED IN THE LEAST OBTRUSIVE HOURS.

26. VERIFY ALL EXISTING WIRING AND MATERIALS IN THE CEILING IS RATED FOR PLENUM. IF NOT, COORDINATE WITH THE BUILDING OWNER'S REPRESENTATIVE FOR THE REMOVAL OF WIRING OR MATERIALS NOT RATED FOR PLENUM USE, MAKING SURE THIS WILL NOT INTERRUPT OR DISCONTINUE SERVICES TO OTHER AREAS OF THE BUILDING.

27. WHENEVER EXISTING CEILINGS AND WALLS ARE INDICATED TO REMAIN WITHIN THE LIMITED AREA OF DISTURBANCE, THEY SHALL BE PREPARED FOR REFINISHING. ABANDONED ATTACHMENTS, FASTENERS, FIXTURES, ETC. SHALL BE TEMPORARILY REMOVED AND BE REINSTALLED AS REQUIRED AFTER FINISHING OPERATIONS ARE COMPLETE. SURFACE SHALL BE CLEANED FREE OF DUST, DIRT, LOOSE MATERIALS AND ANY OTHER MATERIALS WHICH MIGHT ADVERSELY AFFECT THE PROPER INSTALLATION OF NEW FINISHES. NEW AND EXISTING HOLES, CRACKS, ETC. SHALL BE PATCHED, FILLED AND SANDED FLUSH AND SMOOTH WITH ADJACENT SURFACES. LOOSE PAINT SHALL BE SCRAPED BACK TO SOLID MATERIAL AND EDGES SHALL BE FEATHERED TO BLEND WITH ADJACENT SURFACES. EXISTING PANELING, WALL COVERING, ETC. SHALL BE COMPLETELY REMOVED AND SURFACE PREPARED FOR NEW FINISH AS INDICATED ABOVE. INK MARKS, STAINS, SPECIAL PAINTS AND OTHER MATERIALS WHICH MIGHT BLEED THROUGH NEW FINISHES SHALL BE SEALED PRIOR TO APPLICATION OF FINISH.


28. ALL PREVIOUSLY PAINTED SURFACES INDICATED TO REMAIN WITHIN THE LIMITED AREA OF DISTURBANCE INCLUDING DOORS, FRAMES WINDOWS, TRIM, ETC. SHALL BE PREPARED AND REPAINTED. DOORS AND WINDOW SASH SHALL BE TEMPORARILY REMOVED AND REINSTALLED AFTER PAINT HAS CURED. HARDWARE AND FASTENERS TO REMAIN IN SERVICE SHALL BE TEMPORARILY REMOVED AND REINSTALLED AFTER PAINTING IS COMPLETE. ABANDONED HARDWARE AND FASTENERS SHALL BE REMOVED. HOLES SHALL BE FILLED AND SANDED SMOOTH EXCEPT MOUNTING HOLES FOR HARDWARE TO BE REINSTALLED. SURFACES SHALL BE CLEANED FREE OF DIRT, DUST, OIL AND OTHER MATERIALS WHICH WOULD ADVERSELY AFFECT INSTALLATION OF NEW FINISH. LOOSE PAINT AND RUST SHALL BE SANDED OR SCRAPED BACK TO SOLID MATERIAL AND EDGES FEATHERED TO BLEND. INK MARKS, STAINS, RUST SPECIAL PAINTS AND OTHER MATERIALS WHICH MIGHT BLEED THROUGH NEW PAINT SHALL BE SEALED PRIOR TO APPLICATION OF FINISH.

29. UNLESS OTHERWISE INDICATED ALL PIPING, CONDUIT, DUCTWORK AND SIMILAR SERVICES SHALL BE CONCEALED.

30. GENERAL NOTES, THOSE FOUND ON THIS SHEET, APPLY TO ALL DRAWINGS RELATED TO THIS PROJECT.

31. CONSTRUCTION NOTES SPECIFICALLY REFER TO ITEMS NOTED WITH NUMBER OR LETTER DESIGNATIONS ON THE RESPECTIVE DRAWING WHERE THE DESIGNATIONS ARE SHOWN.

LOCATION MAP

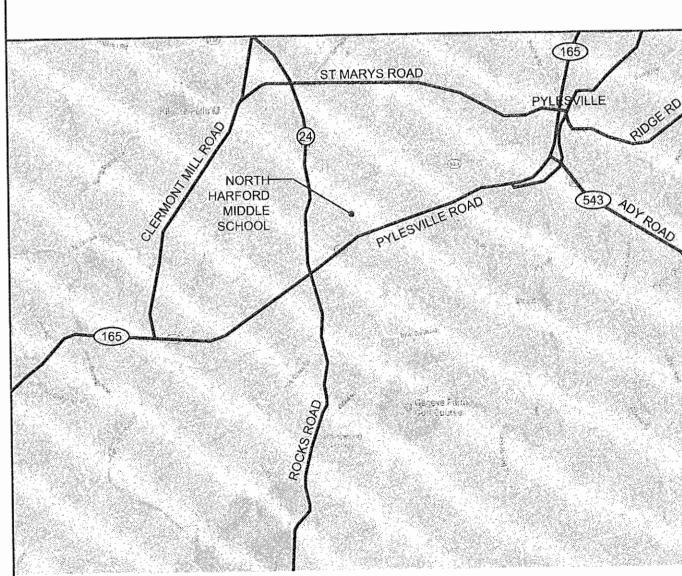

CERTIFICATION

THESE PLANS FOR THE POOL REPAIR AT NORTH HARFORD MIDDLE SCHOOL WERE PREPARED UNDER MY SUPERVISION AND, TO THE BEST OF MY KNOWLEDGE, INFORMATION AND BELIEF, COMPLY WITH THE REQUIREMENTS OF THE BUILDING CODE OF HARFORD COUNTY AND THE STATE OF MARYLAND FIRE PREVENTION CODE.

ARCHITECT, MARYLAND REGISTRATION NO. 9893 EXPIRATION DATE: 3/27/18 DATE

ARCHITECT

9211 CORPORATE BLVD, SUITE 340

STRUCTURAL

COMPREHENSIVE

STRUCTURAL SOLUTIONS

12410 MILESTONE CENTER DRIVE #6

GERMANTOWN, MD 20876

PROFESSIONAL CERTIFICATION.
I CERTIFY THAT THESE DOCUMENTS
WERE PREPARED BY OR APPROVED BY
ME AND THAT I AM A DULY LICENSED
ARCHITECT UNDER THE LAWS OF THE
STATE OF MARYLAND, LICENSE # 9893,
EXPIRATION DATE 03/27/18

PROFESSIONAL SEAL:

 PRINTS ISSUED

 NO.
 DESCRIPTION
 DATE

 1
 50% SUBMISSION
 10/25/17

 2
 PERMIT SUBMISSION
 12/4/17

 3
 100% SUBMISSION
 1/25/18

 4
 BID SUBMISSION
 2/5/18

NORTH HARFORD MIDDLE SCHOOL

POOL REPAIR

112 PYLESVILLE ROAD PYLESVILLE, MD

SHEET TITLE

COVER SHEET

PROJECT NO. 17013 DATE

17013

DATE
2/5/18

SCALE
AS NOTED

CS

NORTH HARFORD MIDDLE SCHOOL

POOL REPAIR - PHASE 2 & 3 HARFORD COUNTY PUBLIC SCHOOLS

> **SOLICITATION #: HM19-1** 112 PYLESVILLE ROAD PYLESVILLE, MARYLAND 21132

CONFORMING SET APRIL 25, 2019



ARCHITECT

ROCKVILLE, MD 20850

MEP ENGINEER

303 INTERNATIONAL CIRCLE SUITE 450 HUNT VALLEY, MD 21030

PROFESSIONAL SEAL

PRINTS ISSUED

INDEX OF DRAWINGS

COVER SHEET

EXISTING FLOOR PLAN & INTERIOR ELEVATIONS PROPOSED DECK DRAINS & TILE LAYOUT PROPOSED INTERIOR ELEVATIONS

EXISTING POOL & FILTER ROOM PLAN PROPOSED FLOOR PLAN & ENLARGED PLANS

PL-2.01 POOL DETAILS

PLUMBING

PLUMBING PLANS P-1.00

PLUMBING LEGEND & SPECIFICATIONS

ELECTRICAL

ELECTRICAL LEGEND, CONVENTIONS, AND ABBREVIATIONS

PROPOSED FLOOR PLAN - DEMO & POWER

SCOPE OF WORK

PHASE II: FILTERS AND PUMPS 1. REMOVAL OF EXISTING FILTER SYSTEM, PUMP, STRAINER, AND GAUGES

2. REMOVAL OF EXISTING FILTER PIPING AND VALVES

3. INSTALLATION OF NEW FILTER SYSTEM COMPONENTS 4. INSTALLATION OF NEW UV WATER TREATMENT SYSTEM

5. RE-INSTALLATION OF EXISTING CHEMICAL TREATMENT SYSTEM

6. REPLACEMENT OF DHU BOOSTER PUMP & RECONNECTION TO EXISTING HEATING SYSTEM 7. INSTALLATION OF NEW GAUGES, THERMOMETERS, AND FLOW METERS

8. INSTALLATION OF VFD FILTER MOTOR CONTROLLER 9. REWIRING OF ALL COMPONENTS

10. INSTALLATION OF COLOR CODING, VALVE TAGS, CHARTS, AND OPERATIONAL INSTRUCTIONS

11. TESTING AND BALANCING

PHASE III: ADD ALTERNATIVES 1, 2, OR 3 1. REMOVAL OF EXISTING DECK TILE AND EXISTING BENCH TILE

2. REMOVAL OF EXISTING SPOT DRAINS 3. REMOVAL OF EXISTING BASE BOARD

4. CUTTING OF EXISTING DECK SLAB FOR INSTALLATION OF NEW DECK LINEAR TRENCH DRAINS,

5. CHIPPING OF EXISTING DECK SLAB FOR NEW DECK SLOPES 6. INSTALLATION OF ADA COMPLIANT DECK SLOPES

∕7. INSTALĽÁTION OF CĚMENTITIOŮS OVERLAY ON DECKS AND MUDSET & TILE ON BENCHES∕

8. REINSTALLATION OF BASEBOARD

9. REFILLING OF POOL 10. SYSTEM MAINTENANCE UNTIL SCHOOL COMMENCEMENT

PHASE III ADD ALTERNATES

ADD ALTERNATE #1: NEW DECK DRAINS AND DECK TILE ADD ALTERNATE #2: NEW DECK DRAINS AND EPOXY COATED DECK ADD ALTERNATE #3: NEW DECK DRAINS AND FOAM RUBBER DECK TILE

ADD ALTERNATE #4: NEW GUTTER HDPE GRATE ADD ALTERNATE #5: PROVIDE FULLY FUNCTIONAL METAL GATE SYSTEM ON INTERIOR SIDE OF

NATATORIUM EXTERIOR DOUBLE DOORS.

GENERAL NOTES AND CONDITIONS

THE CONTRACTOR IS CAUTIONED THAT HIS OR HER WORK INCLUDES ALTERATIONS TO AI EXISTING FACILITY. THE GENERAL CONTRACTOR AND/OR SUBCONTRACTORS (HEREAFTER REFERRED TO AS "CONTRACTOR") SHALL VISIT THE SITE TO DETERMINE ACTUAL FIELD CONDITIONS, AND CHECK THE ACCURACY OF THE GIVEN. FAILURE TO DO SO WILL NOT RELIEVE THEM OF THE RESPONSIBILITY FOR CARRYING OUT ANY AND ALL WORK SHOWN, NOTED OR

3. THE INTENT OF THESE DRAWINGS IS FOR THE CONTRACTOR TO PROVIDE ALL LABOR, MATERIAL, FINISHES, EQUIPMENT, INSTALLATION AND SERVICES NECESSARY FOR AND INCIDENTAL WITH THE WORK, TO PROVIDE THE OWNER WITH A "TURN KEY" COMPLETE PROJECT.

. ACTUAL FIELD CONDITIONS MAY VARY FROM THOSE INDICATED. SHOULD ACTUAL CONDITIONS DIFFER MATERIALLY FROM THOSE ORDINARILY ENCOUNTERED AND GENERALLY RECOGNIZED AS SHALL PROMPTLY, BEFORE CONDITIONS ARE DISTURBED, NOTIFY THE ARCHITECT. FAILURE TO DO SO MAY WAIVE THE CONTRACTOR'S RIGHT TO RECEIVE ADDITIONAL TIME OR CONSIDERATION DUE TO SUCH CONDITIONS.

5. PRIOR TO INITIATING ANY PORTION OF THE WORK, THE CONTRACTOR SHALL VERIFY ALL DIMENSIONS INCLUDING CEILING HEIGHT AVAILABILITY AND COORDINATE ALL PORTIONS OF THE CONTRACT DOCUMENTS RELATING TO THAT PORTION OF THE WORK AND AFFECTING ADJOINING PORTIONS. IF DISCREPANCIES EXIST, THEY SHALL BE REPORTED TO THE ARCHITECT FOR CLARIFICATION AND/OR RESOLUTION BEFORE COMMENCING SUCH WORK.

6. THE CONTRACTOR SHALL PREPARE A CONSTRUCTION SCHEDULE. THE CONTRACTOR IS ALSO TO INDICATE EVENTS IN THE SCHEDULE THAT MAY CAUSE INTERRUPTIONS TO THE NORMAL DAILY ACTIVITIES OF THE BUILDING. THESE EVENTS ARE TO BE COORDINATED TO THE SATISFACTION OF THE BUILDING REPRESENTATIVES AND THE ARCHITECT.

'. DEFINITIONS: "PROVIDE" MEANS "FURNISH AND INSTALL". "VERIFY" MEANS "VERIFY IN THE FIELD AND COORDINATE DIMENSIONS AND DISCREPANCIES".

8. THESE NOTES AND OTHER NOTES ON THE DRAWINGS ARE DIRECTIONS FOR THE CONTRACTOR'S PERFORMANCE, UNLESS NOTED OTHERWISE (U.N.O.). FOR EXAMPLE, "INSTALL" MEANS "CONTRACTOR SHALL INSTALL", "RELOCATE" MEANS "CONTRACTOR SHALL RELOCATE", ETC.

DRAWINGS TAKE PRECEDENCE OVER SCALED DRAWINGS. DETAIL DRAWINGS TAKE PRECEDENCE OVER GENERAL DRAWINGS. IF CONFLICT EXISTS ON THE DRAWINGS, THEN THE MORE STRINGENT REQUIREMENT SHALL APPLY.

9. DIMENSIONS SHOWN ARE TO FINISH FACE, U.N.O. NUMBERED DIMENSIONS SHOWN ON THE

10. SAMPLES AND SUBMITTALS MUST BE SUBMITTED BY THE CONTRACTOR TO THE ARCHITECT BEFORE THE PURCHASE OR FABRICATION OF ANY MATERIALS.

1. DIMENSIONS OF EXISTING OPENINGS SHALL BE VERIFIED PRIOR TO PREPARATION OF SHOP DRAWINGS. SHOP DRAWINGS SHALL INCLUDE A SCHEDULE OF ACTUAL OPENING DIMENSIONS AS

12. DURING THE WORK, ANY CONDITION UNCOVERED THAT CAUSES CONFLICT WITH THE INTENDED DESIGN MUST BE IMMEDIATELY BROUGHT TO THE ATTENTION OF THE ARCHITECT.

13. CONTRACTOR SHALL STAGE WORK IN SUCH A WAY AS TO ENSURE SAFE EMERGENCY EGRESS AT 14. EXCEPT FOR PREFINISHED SURFACES, ALL ITEMS DISTURBED OR DAMAGED BY WORK SHALL BE

REFINISHED TO MATCH SURROUNDING AREA OR FINISHED AS INDICATED. 15. REPAIRED AND NEW AREAS OF WALLS OR CEILINGS SHALL BE BLENDED AND FEATHERED INTO THE 31. REMOVE AND REPLACE MARBLE THRESHOLDS, PROVIDE ADA COMPLIANCE. SURROUNDING AREA. THERE SHALL NOT BE ANY VISIBLE SEAMS OR CHANGE IN APPEARANCE BETWEEN THE REPAIRED OR NEW AREA AND THE SURROUNDING AREA WHEN VIEWED FROM A

16. ALL NEW AND EXISTING HOLES AND PENETRATIONS IN WALLS AND CEILING SURFACES SHALL BE PATCHED AND FIRE STOPPED.

17. THE FLOOR SPACE WILL BE UNOCCUPIED AT THE TIME OF WORK & SHALL BE SECURED AT THE END OF EACH WORK DAY.

19. IF APPLICABLE, REMOVE OBVIOUS ABANDONED EXPOSED WIRING, CONDUITS, PIPING IN THE SPACE, WHICH IS NOT PART OF WORK. PRIOR TO REMOVAL, COORDINATE WITH THE OWNER THESE ITEMS THAT MAY BE PLANNED TO BE REUSED/READAPTED FOR OWNER OR TENANT FUTURE USE.

20. LICENSED MECHANICAL, PLUMBING, & ELECTRICAL CONTRACTORS TO PULL SEPARATE TRADE PERMITS FOR ALL NEW WORK AS REQUIRED BY THE LOCAL JURISDICTION.

21. PROVIDE SHOP DRAWINGS TO THE ARCHITECT FOR APPROVAL FOR PRE-ENGINEERED, CUSTOM, OR SPECIALTY WORK. THE OWNER RESERVES THE RIGHT TO WAIVE THIS REQUIREMENT.

22. CONTRACTOR TO GUARANTEE ALL WORK FOR A PERIOD OF TWO YEARS FROM THE DATE OF

INHERENT IN WORK OF THE CONTRACTOR PROVIDED FOR IN THE CONTRACT, THE CONTRACTOR 23. THE ARCHITECT SHALL HAVE NO RESPONSIBILITY FOR THE DISCOVERY, PRESENCE, HANDLING, REMOVAL OR DISPOSAL OF, OR EXPOSURE OF PERSONS TO HAZARDOUS MATERIALS IN ANY FORM AT THE PROJECT SITE, INCLUDING BUT NOT LIMITED TO ASBESTOS, ASBESTOS PRODUCTS, POLYCHLORINATED BIPHENYL (PCB) OR OTHER TOXIC SUBSTANCES. CONTRACTOR TO CONTACT OWNER IF THESE ITEMS ARE APPARENT.

> 24. ANY ALTERATION TO THE STRUCTURE (I.E., CORE BUILDING CONCRETE FOR PLUMBING, ETC.) SHALL BE COORDINATED AND APPROVED BY THE ARCHITECT.

25. IF THERE ARE OPERATIONS WHICH INVOLVE EXCESSIVE NOISE (I.E., SAW CUTTING CONCRETE, ETC.) IT SHALL BE COORDINATED WITH THE OWNER TO BE PERFORMED IN THE LEAST OBTRUSIVE

26. WHENEVER EXISTING CEILINGS AND WALLS ARE INDICATED TO REMAIN WITHIN THE LIMITED AREA OF DISTURBANCE, THEY SHALL BE PREPARED FOR REFINISHING. ABANDONED ATTACHMENTS, FASTENERS, FIXTURES, ETC. SHALL BE TEMPORARILY REMOVED AND BE REINSTALLED AS REQUIRED AFTER FINISHING OPERATIONS ARE COMPLETE. SURFACE SHALL BE CLEANED FREE OF DUST, DIRT, LOOSE MATERIALS AND ANY OTHER MATERIALS WHICH MIGHT ADVERSELY AFFECT THE PROPER INSTALLATION OF NEW FINISHES. NEW AND EXISTING HOLES, CRACKS, ETC. SHALL BE PATCHED, FILLED AND SANDED FLUSH AND SMOOTH WITH ADJACENT SURFACES. LOOSE PAINT SHALL BE SCRAPED BACK TO SOLID MATERIAL AND EDGES SHALL BE FEATHERED TO BLEND WITH ADJACENT SURFACES. EXISTING PANELING, WALL COVERING, ETC. SHALL BE COMPLETELY REMOVED AND SURFACE PREPARED FOR NEW FINISH AS INDICATED ABOVE. INK MARKS, STAINS, SPECIAL PAINTS AND OTHER MATERIALS WHICH MIGHT BLEED THROUGH NEW FINISHES SHALL BE SEALED PRIOR TO APPLICATION OF FINISH.


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LOCATION MAP



THESE PLANS FOR THE POOL REPAIR PHASES 2 & 3 AT NORTH HARFORD

MIDDLE SCHOOL WERE PREPARED UNDER MY SUPERVISION AND, TO THE

BEST OF MY KNOWLEDGE, INFORMATION AND BELIEF, COMPLY WITH THE

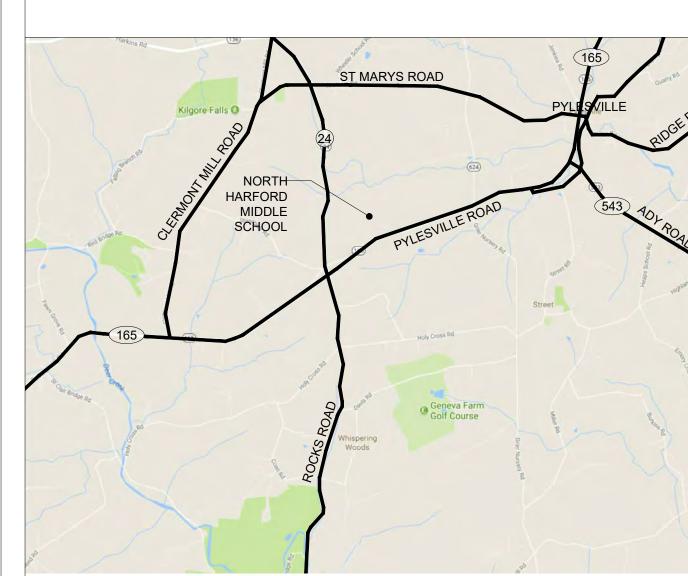REQUIREMENTS OF THE BUILDING CODE OF HARFORD COUNTY AND THE

DATE

STATE OF MARYLAND FIRE PREVENTION CODE.

ARCHITECT, MARYLAND REGISTRATION NO. 16066

CERTIFICATION

EXPIRATION DATE: 01/06/20

DESCRIPTION 95% CDs 12/5/18 **BID SET** 12/19/18 **ADDENDUM #1** | 1/24/19 **ADDENDUM #2** | 2/13/19 **PERMIT SET** | 3/27/19 **CONFORM. SET** 4/25/19

NORTH HARFORD MIDDLE SCHOOL **POOL REPAIRS PHASES 2 & 3**

112 PYLESVILLE ROAD PYLESVILLE, MD 21132 HARFORD COUNTY PUBLIC SCHOOLS

SHEET TITLE

SHEET NO.

COVER SHEET

PROJECT NO. **APR 25 2019 AS NOTED**

2018 Repair **ARCHITECT** SMOLEN • EMR
• ILKOVITCH
ARCHITECTS WINDOWS-9211 CORPORATE BLVD., SUITE 340 ROCKVILLE, MD 20850 PAINTED CMU-301-770-0177 -CEILING COVE OPEN OPEN -SPECTATOR SEATING BEYOND -PAINTED STEEL COL, TYP. MEP ENGINEER CONTINUOUS LIGHTNING--PAINTED CMU -CONTINUOUS LIGHTING ALBAN ENGINEERING 303 INTERNATIONAL CIRCLE -4"X4" CERAMIC TILE SUITE 450 HUNT VALLEY, MD 21030 4x4 CERAMIC TILE-OPEN TO BOYS LOCKER ROOM OPEN TO GIRLS LOCKER ROOM-410.842.6411 -RETURN AIR GRILLES, TYP. STOREFRONT SYSTEM-GRAB RAILS, TYP.-DRINKING FOUNTAIN-CERAMIC TILE BENCH,-RETURN AIR GRILLE-SEE DETAILS 6 & 7/A-1 BASEBOARD ON-CERAMIC TILE C.T. FINISH Commence of the second CONTRACTOR OF THE PROPERTY OF THE PARTY OF T C.T. FINISH [∠]AIR DUCT ∠AIR DUCT [∠]AIR DUCT ∠SUMP & DRAIN EXISTING EAST ELEVATION EXISTING NORTH ELEVATION PROFESSIONAL CERTIFICATION.
I CERTIFY THAT THESE DOCUMENTS A-1 | SCALE: 1/8" = 1'-0" A-1 | SCALE: 1/8" = 1'-0" WERE PREPARED BY OR APPROVED BY ME AND THAT I AM A DULY LICENSED ARCHITECT UNDER THE LAWS OF THE STATE OF MARYLAND, LICENSE # 16066, EXPIRATION DATE 01/06/20. PROFESSIONAL SEAL: PAINTED CMU -PAINTED STEEL COL, TYP. —PAINTED CMU CONTINUOUS LIGHTNING-CONTINUOUS LIGHTING -4"X4" CERAMIC TILE -METAL COVER PLATE, TYP. 4x4 CERAMIC TILE--RETURN AIR GRILLES STOREFRONT SYSTEM-BASEBOARD ON CERAMIC TILE RETURN AIR GRILLE-BASEBOARD ON-CERAMIC TILE C.T. FINISH _C.T. FINISH^{_} PRINTS ISSUED AIR DUCT^{\(\)} ^LAIR DUCT DESCRIPTION 3 EXISTING WEST ELEVATION 50% CDs A-1 | SCALE: 1/8" = 1'-0" EXISTING SOUTH ELEVATION 12/5/18 **GENERAL NOTES:** A-1 SCALE: 1/8" = 1'-0"**BID SET** 12/19/18 **ADDENDUM #1** 1/24/19 1. GENERAL CONTRACTOR TO VERIFY ALL EXISTING CONDITIONS AND DIMENSIONS. A-1 ADDENDUM #2 | 2/13/19 MECHANICAL ROOM STAIRS SHOWER GIRLS LOCKER ROOM BOYS LOCKER ROOM SHOWER 2. CERAMIC TILE WALL PATTERN OMITTED **PERMIT SET** 3/27/19 FOR CLARITY. 3. ELECTRICAL, PLUMBING, CONFORM. SET 4/25/19 BENCH BENCH COMMUNICATIONS, POOL EQUIPMENT, & B_{n.} CERn. APPROX LOC OF EXISTING SIGNAGE DEVICES ON WALL ARE EXISTING TRANSITE DUCT BELOW DECK STORAGE ROOM TO REMAIN AND ARE OMITTED FOR 4"X4" CERAMIC TILE CLARITY. COVE TILE @ REAR OF BENCH 1"X1" CERAMIC TILE 4. GENERAL CONTRACTOR TO SEAL OFF BULLNOSE @ APPROX LOC OF-APPROX LOC OF DEMO DECK AREA FOR INSTALLATION AREAS NOT PART OF SCOPE OF AREA TO ALL EDGES EXISTING DECK DRAINS EXISTING DRAIN LINE OF NEW TRENCH DRAINS TYP. MITIGATE DUST CONVEYANCE & CONTROL SPREAD. ENSURE EGRESS IS MAINTAINED. RETURN AIR GRILLE WHERE OCCURS BASEBOARD ON CERAMIC TILE NORTH HARFORD REMOVE GRAB RAILS-COACH'S OFFICE MIDDLE SCHOOL **POOL REPAIRS PHASES 2 & 3** AREA OF SCOPE OF WORK LIMITED TO-EXISTING TILED BENCH ELEVATION WITHIN NATATORIUM (DASHED LINE) & COMPONENTS WITHIN FILTER & TANK ROOM. A-1 | SCALE: 1" = 1'-0" 112 PYLESVILLE ROAD PYLESVILLE, MD 21132 HARFORD COUNTY PUBLIC SCHOOLS 4"X4" CERAMIC TILE **NATATORIUM** COVE TILE 1"X1" CERAMIC TILE SHEET TITLE 2 ½" CONC SLAB 6 A-1 3"X3"X¹₄" ANGLE EXISTING FLOOR PLAN & 12"X36" RETURN AIR GRATE WITH BACK UP LOUVER INTERIOR ELEVATIONS DECK AIR PLENUM C.T. FINISH FRAMING SYSTEM 5 A-1 STAINLESS STEEL DUCT PROJECT NO. CONNECTION TO MAIN TRANSITE 17013.0100 DUCT **APR 25 2019** EXISTING TILED BENCH SECTION

A-1 \int SCALE: 1" = 1'-0"

EXISTING FLOOR PLAN

A-1 | SCALE: 1/8" = 1'-0"

NOTE: EXTENT OF SLAB DEMOLITION SHOWN FOR ILLUSTRATIVE


PURPOSES ONLY. GC TO VERIFY FIELD CONDITIONS.


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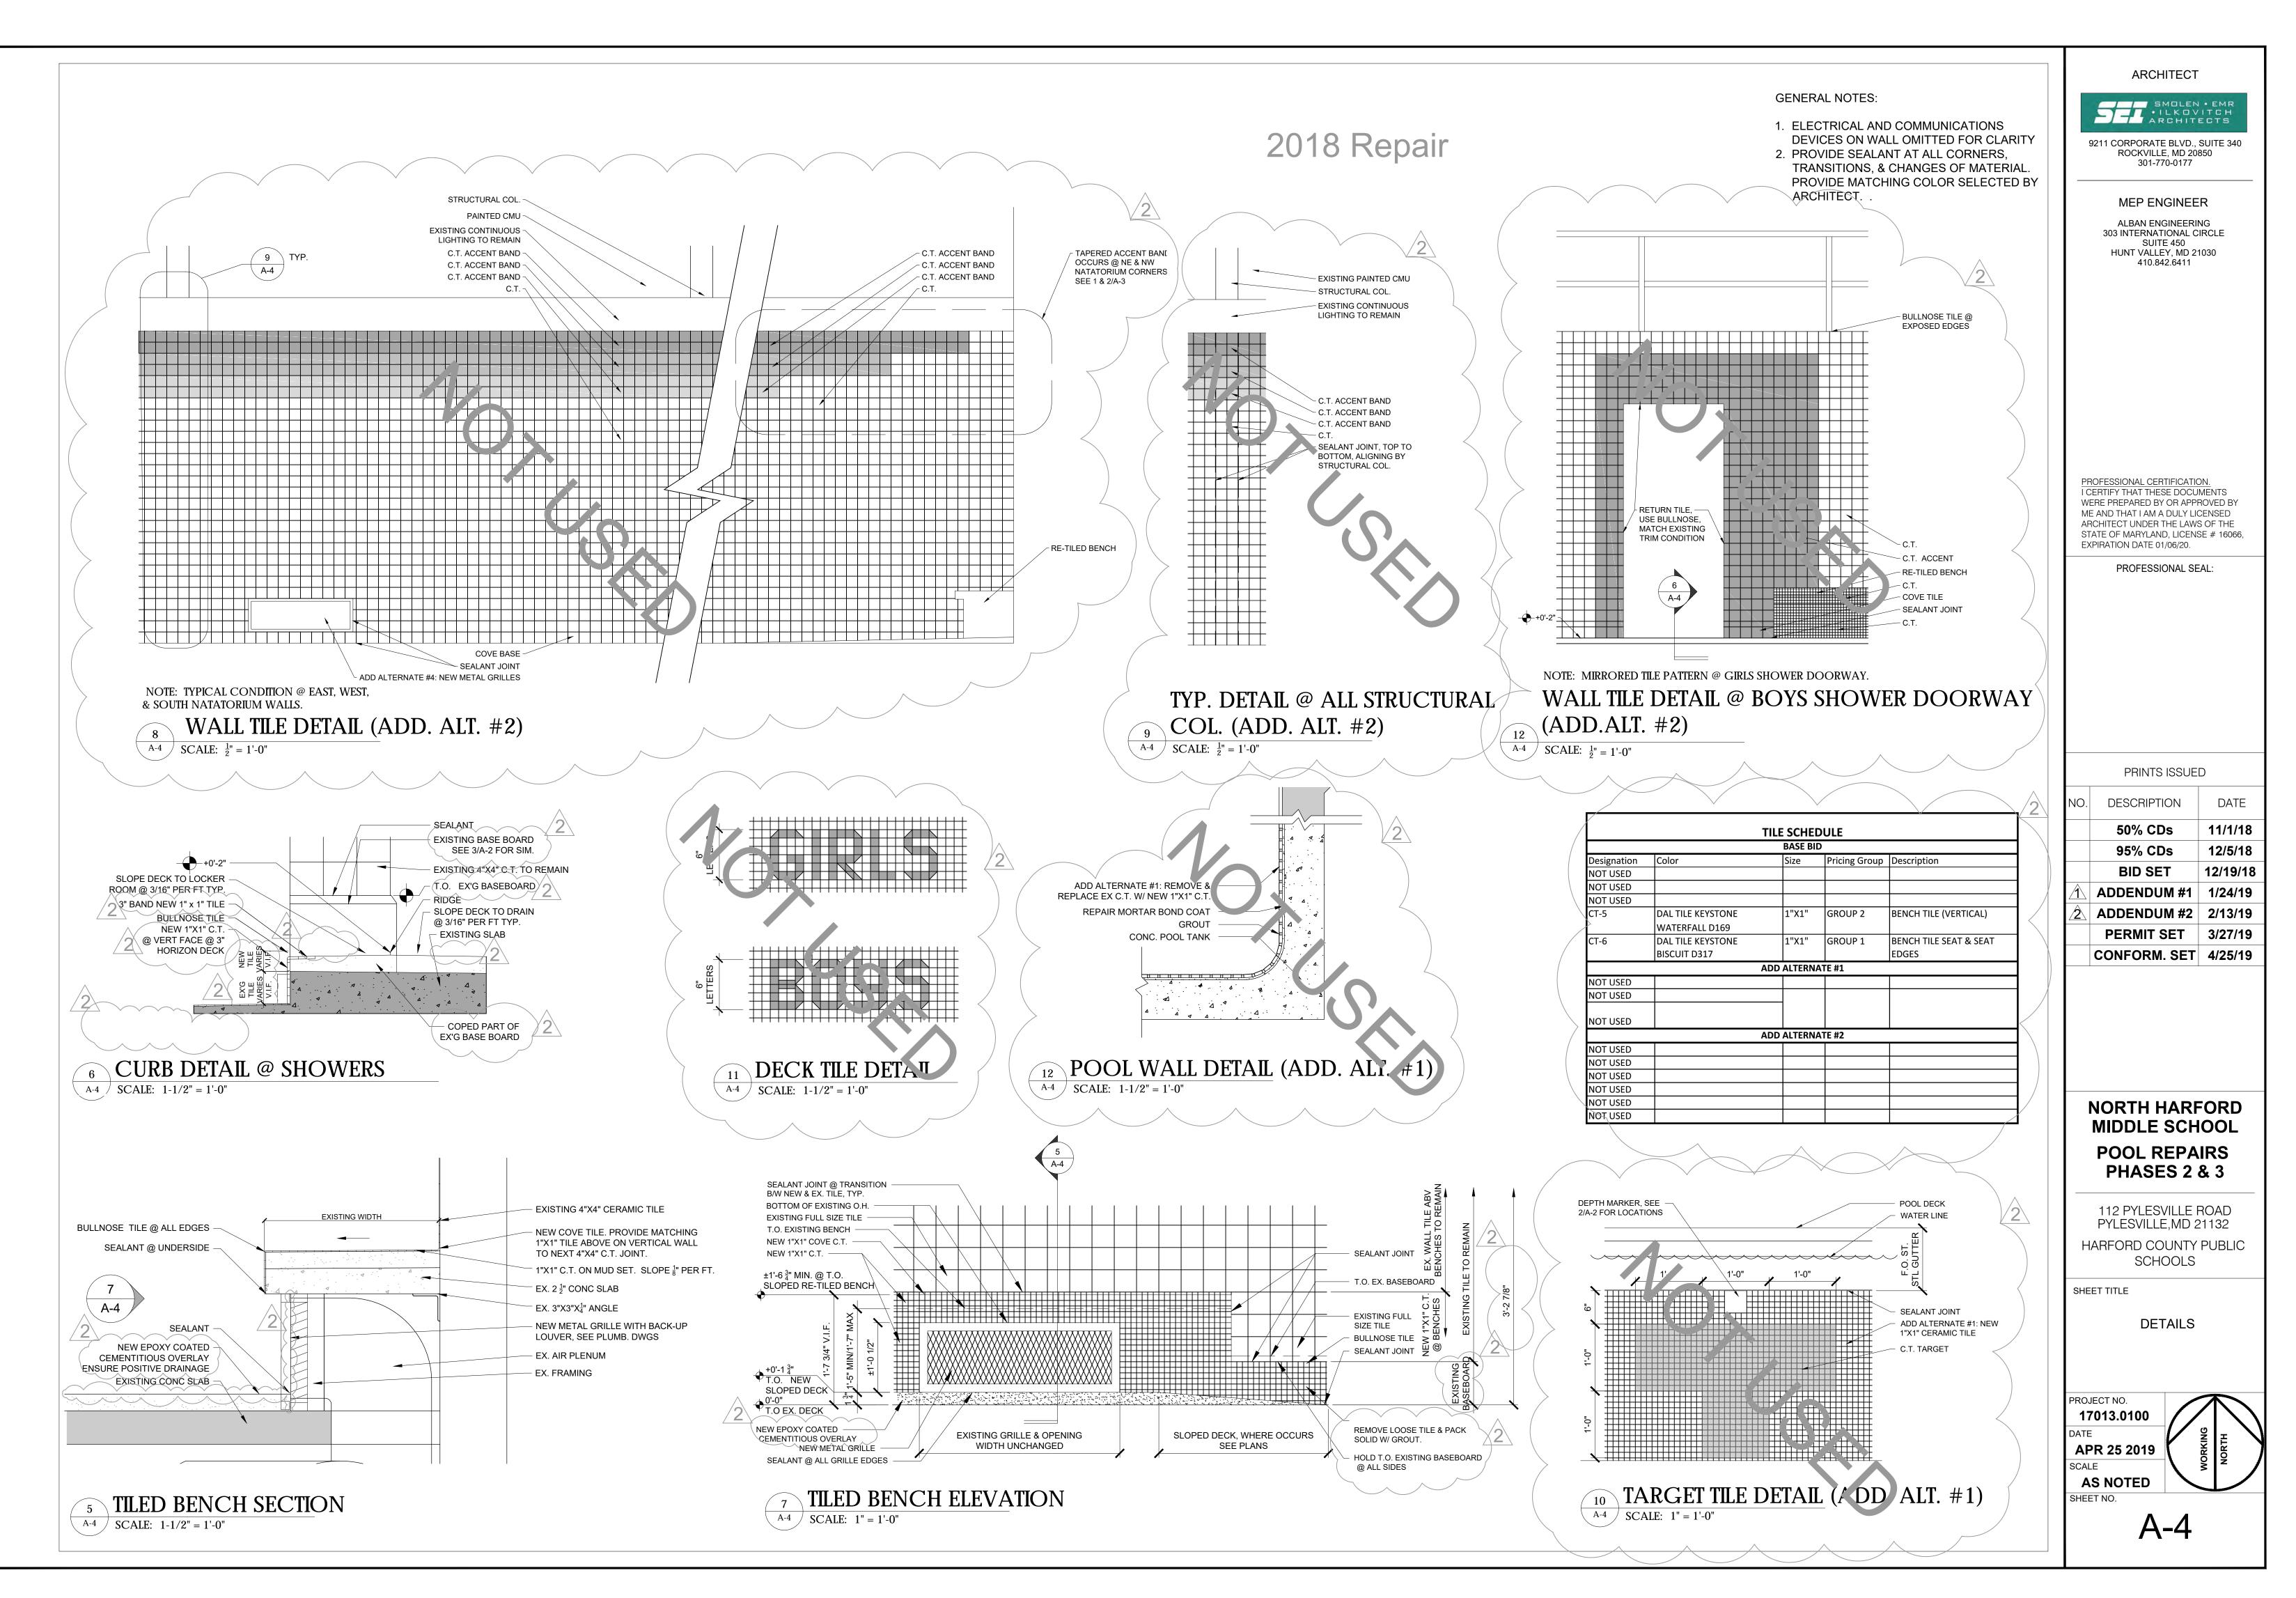
A-1


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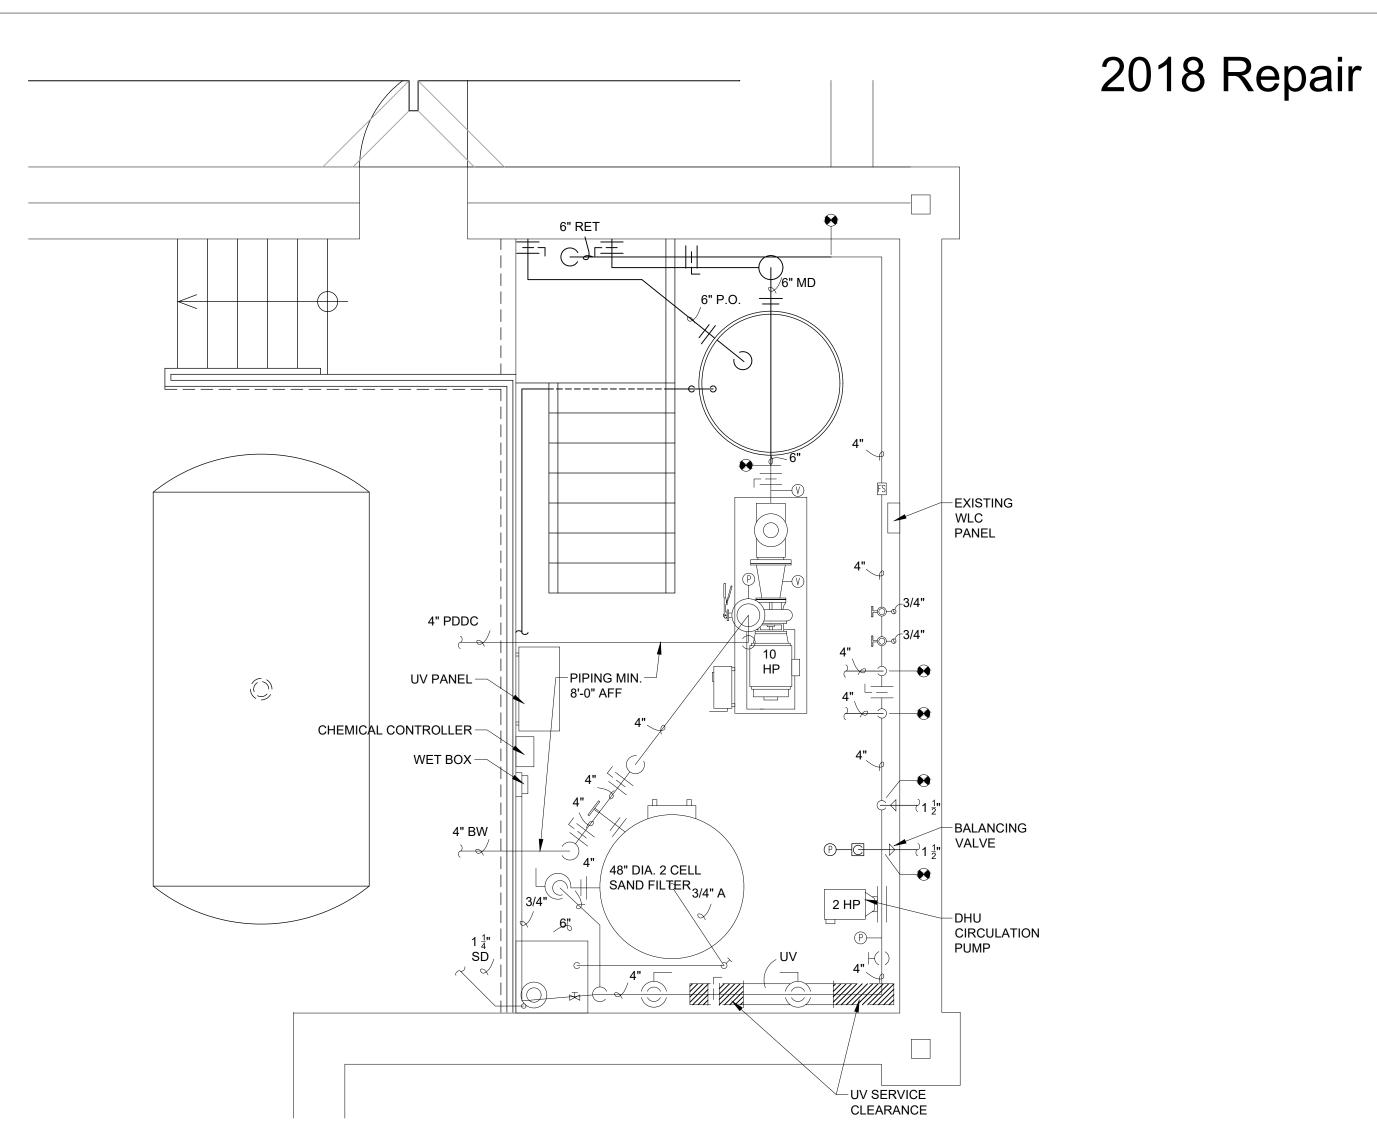
KEY PLAN





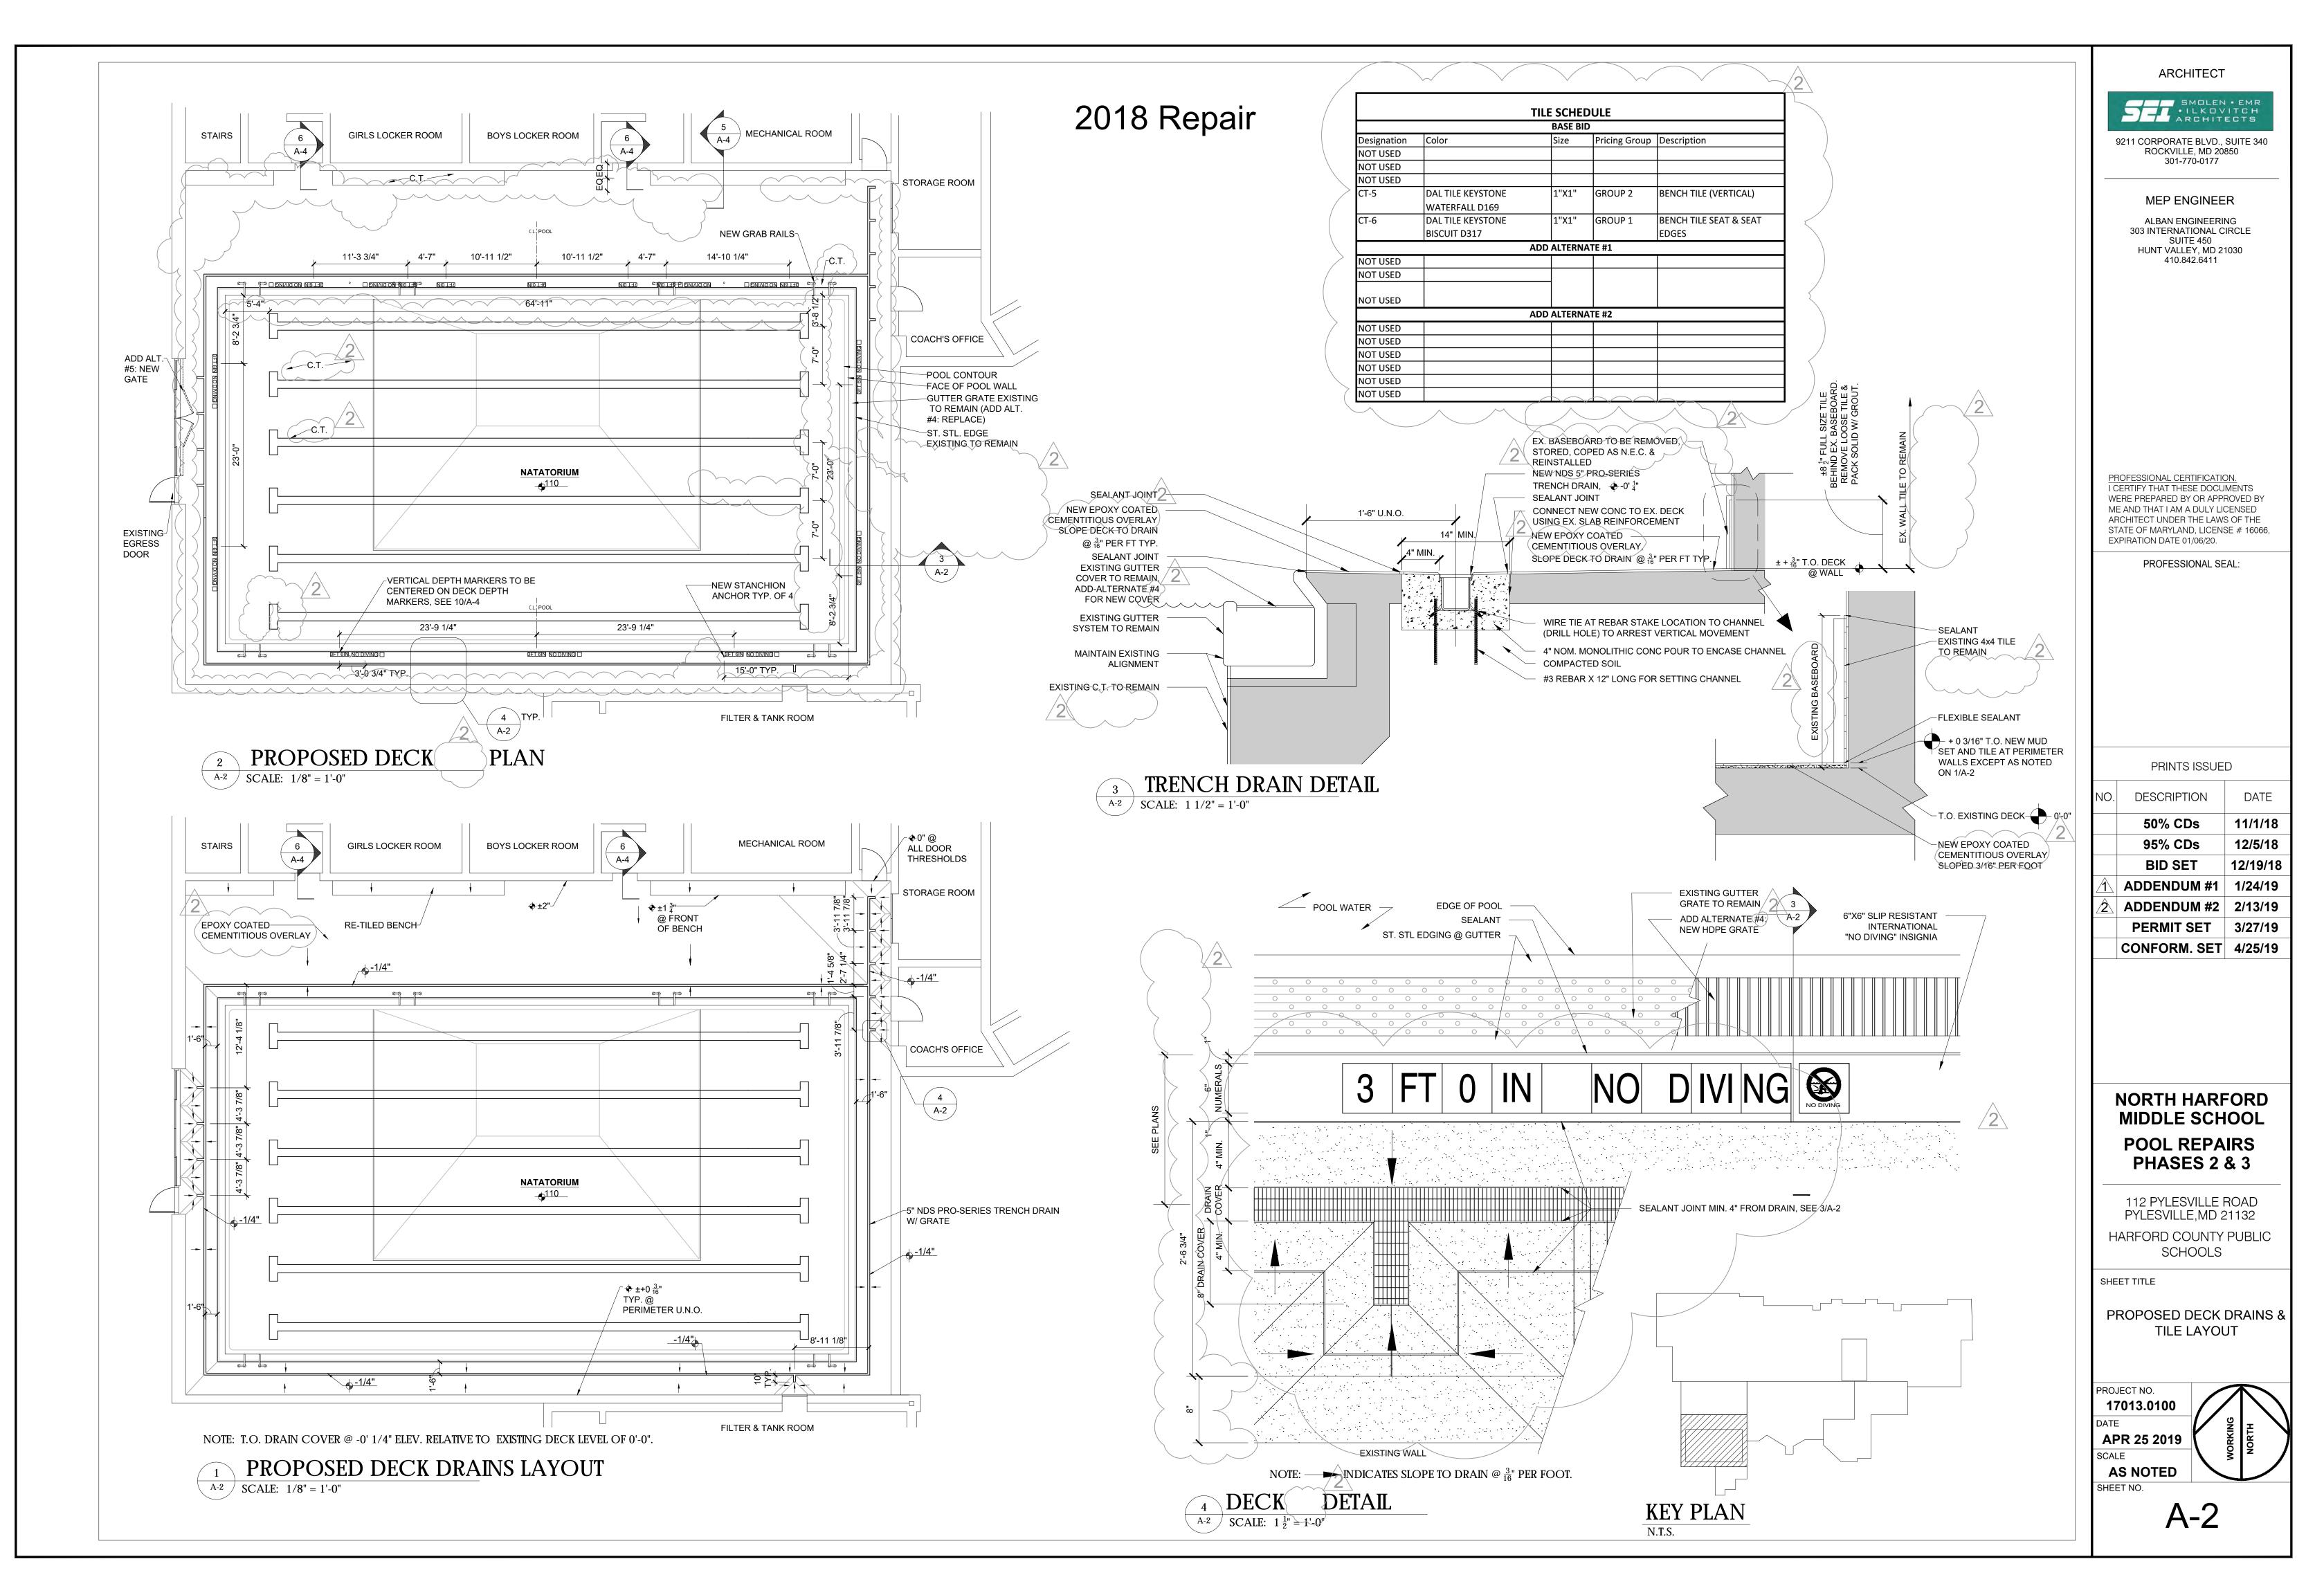

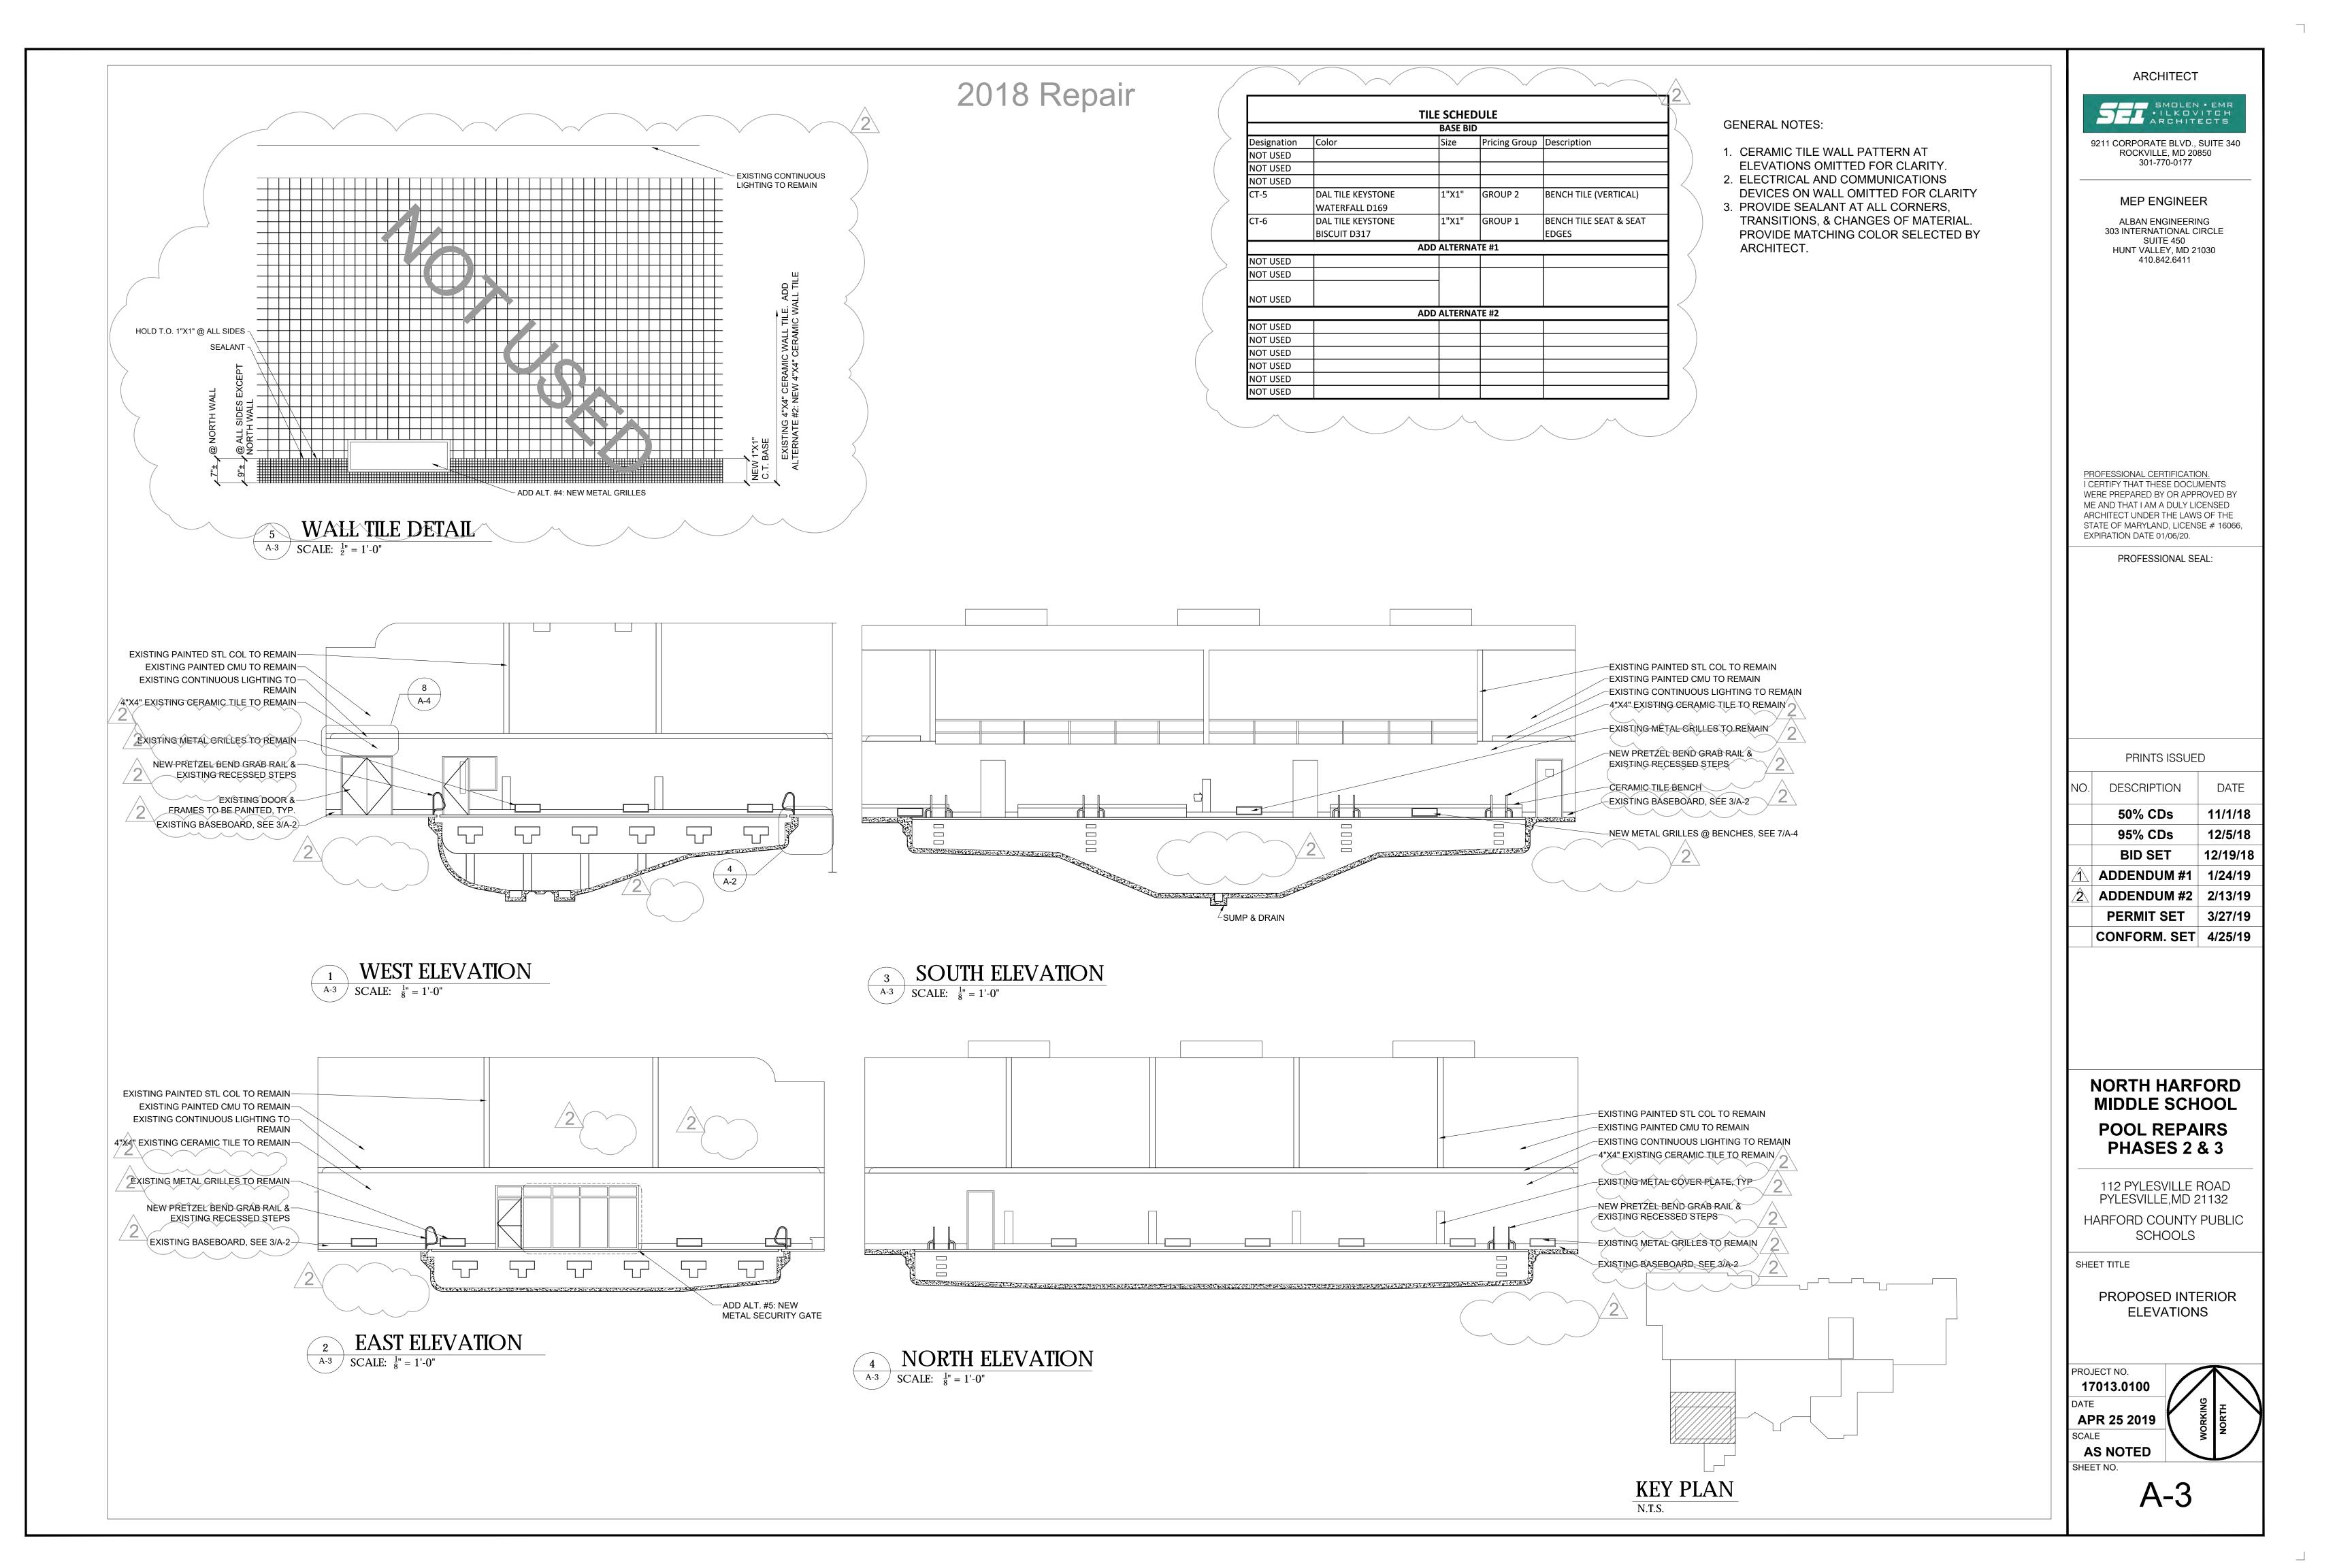

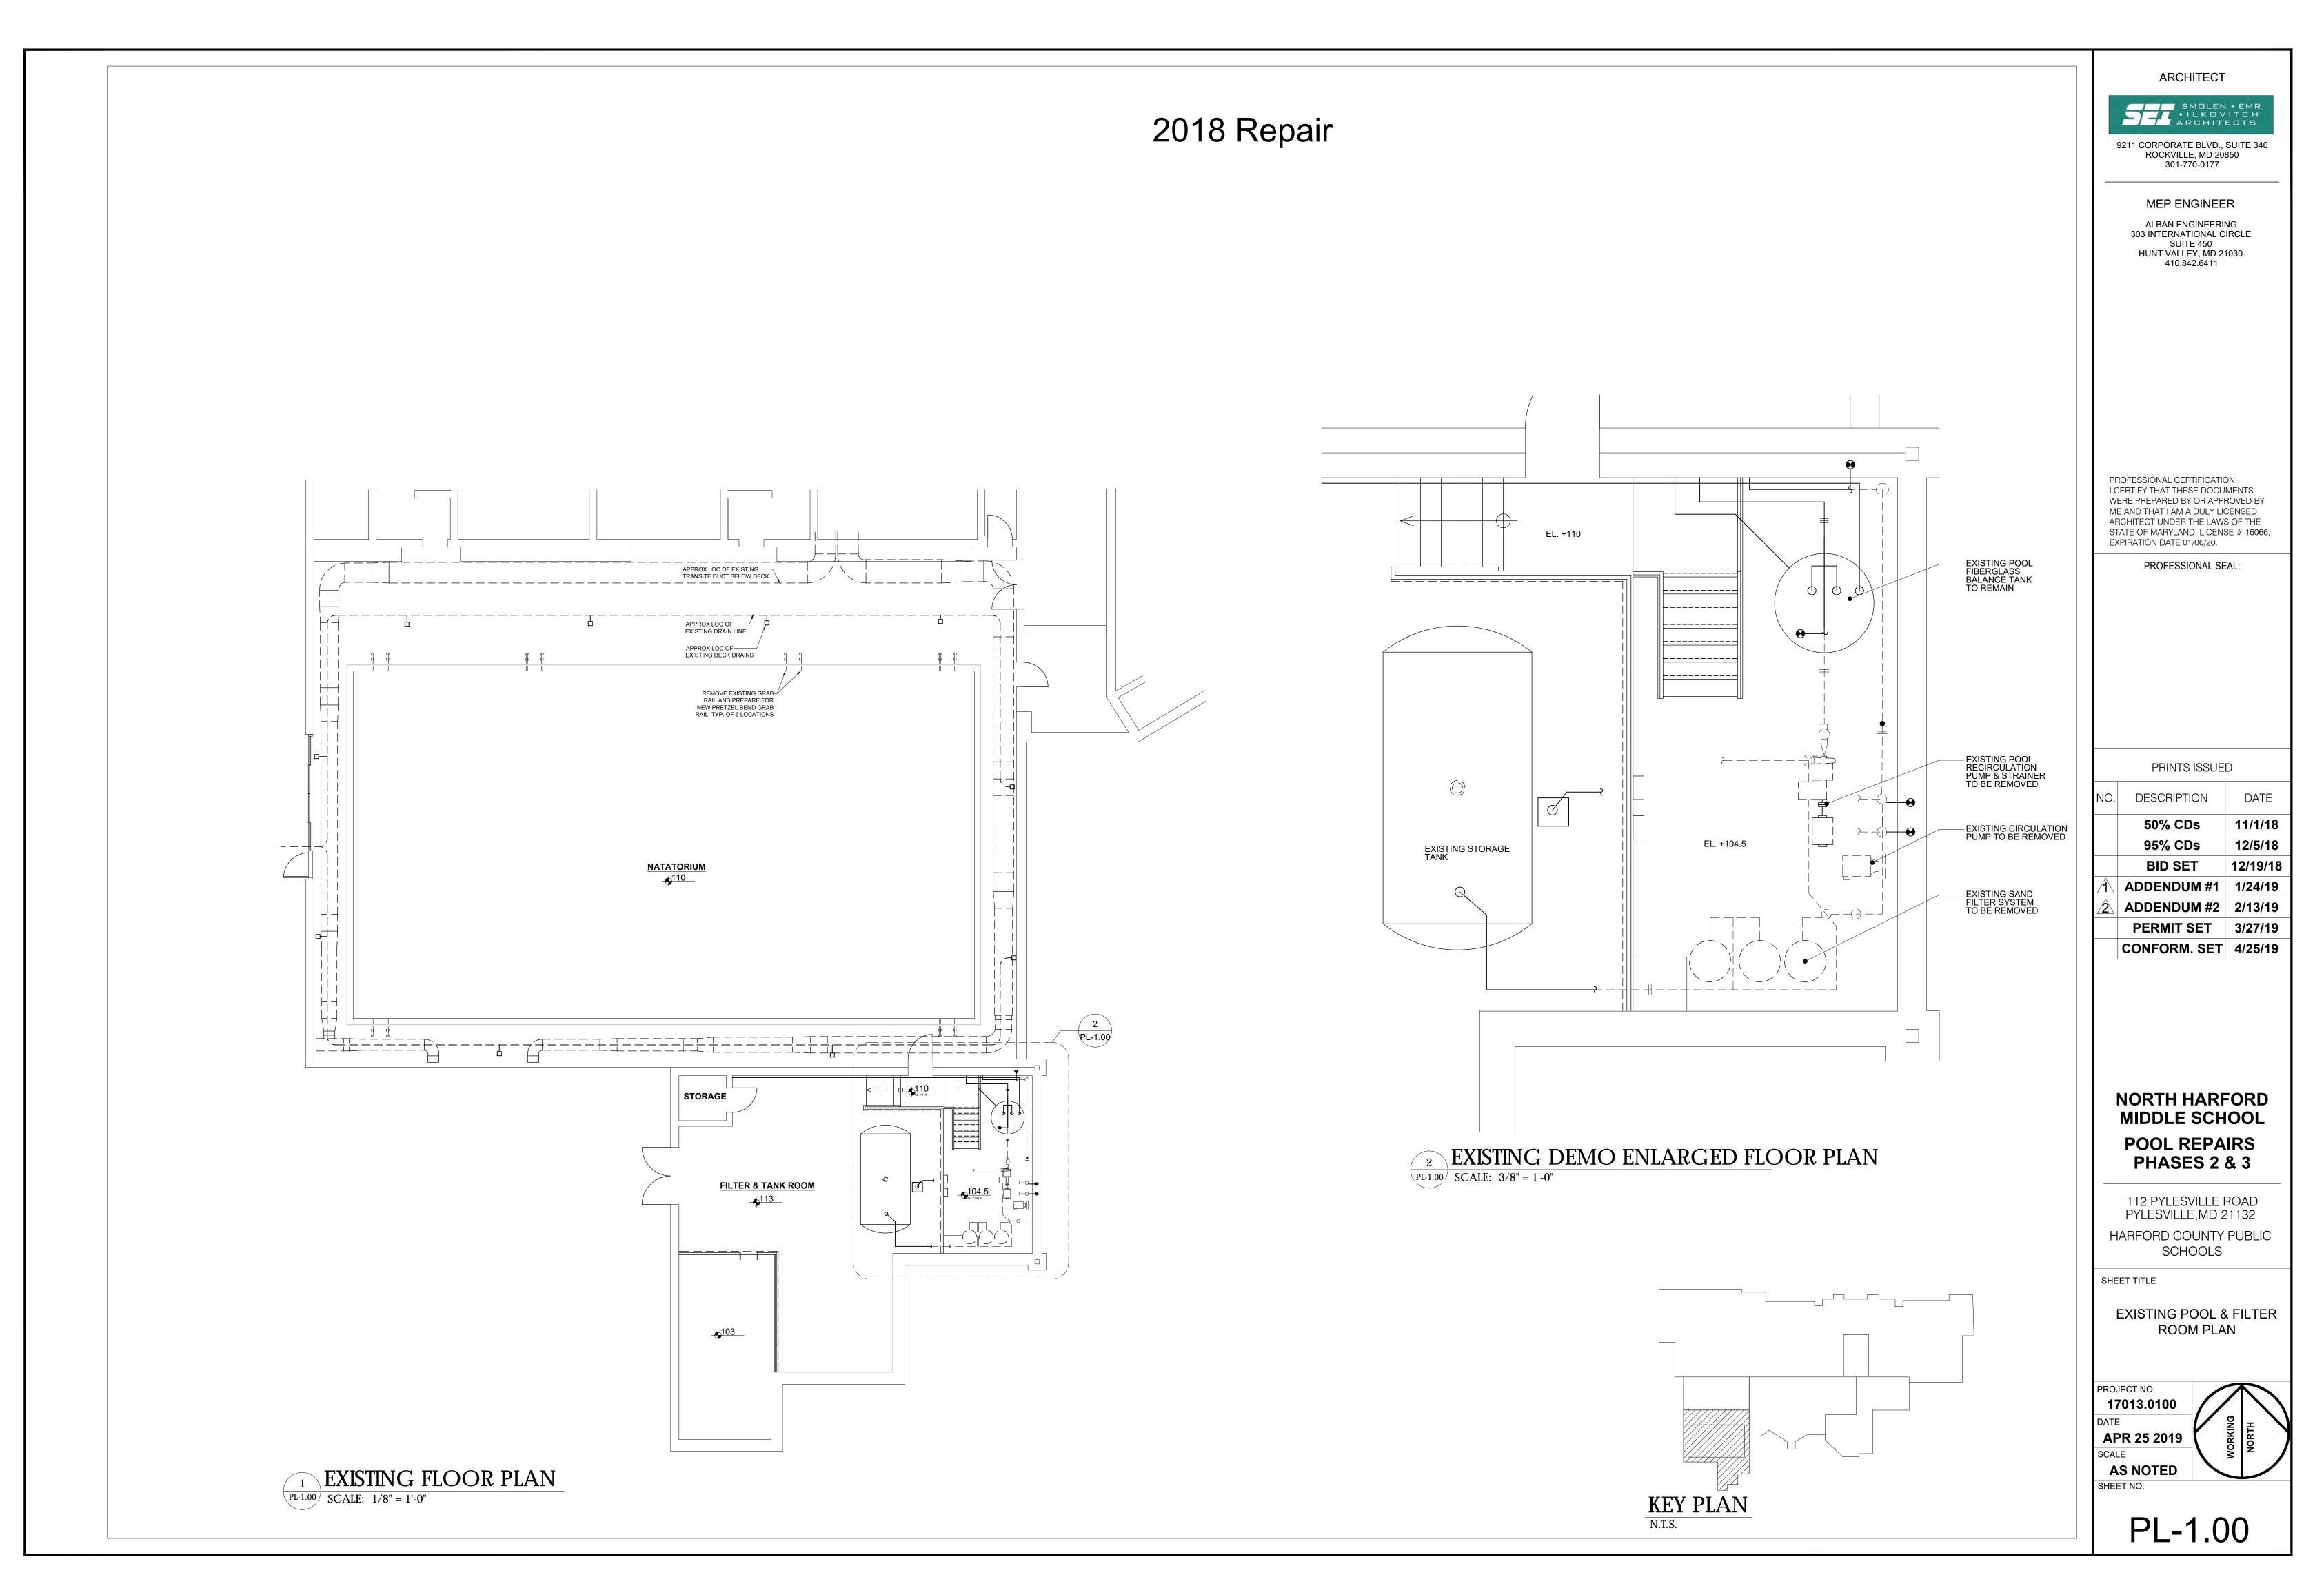


ENLARGED FLOOR PLAN

BALANCE TANK

<u>N</u>	EW :	MECHANICAL EQUIPMENT LIST
	NO	RTH HARFORD MIDDLE SCHOOL - PHASE II
FILTERS	1	PADDOCK #67-25-2C STAINLESS STEEL TWO CELL VERTICAL SAND FITLER, 12.57 SQ. FT FILTER MEDIA PER CELL, TOTAL 25.14 SQ. FT. FILTER MEDIA PER TANK, MAX. FILTER RATE 502 GPM PER FILTER, DESIGN FILTER RATE 305 GPM PER FILTER AT 12.1 GALLONS PER SQ. FT. FILTER AREA, BACKWASH RATE AT 188.55 GPM PER FILTER CELL, TOTAL BACK WASH FOR BOTH CELLS 1,886 GALLONS.
PUMP	1	PACO 2595-7, C.I. END SUCTION, BRONZE FITTED, 1775 RPM, 10 HP, 208 VOLTS, 305 GPM @75' TDH, MAXIMUM 9.26 NPSH REQUIRED
VFD FOR FILTER PUMP	1	H2FLOW CONTROLS - VFD FOR 208 VOLT, 10 HP PUMP
STRAINER	1	MERMADE F.G. 6" x 3" ECCENTRIC, WITH ONE SPARE BASKET
REDUCER	1	SCH. 80 2.5" X 4"CONCENTRIC WITH FLANGES
FLOW SENSOR	1	SIGNET 8" SENSOR 2551 WITH TRANSMITTER 8550
FLOW METER	1	BLUE-WHITE 4" #F30400P (FOR BACKWASH)
GUAGE PANEL	1	PADDOCK POOL EQUIPMENT COMPANY ALUMINUM PANEL WITH TWO GUAGES
GAUGES - PRESSURE	3	ASHCROFT 4" ST. STL. PRESSURE, LIQUID FILLED
GAUGES - COMPOUND	2	ASHCROFT 4" ST. STL. COMPOUND, LIQUID FILLED
THERMOMETERS	5	ASHCROFT 3" THERMOMETER #2A606-9
CHLORINE FEEDER	1	REUSE EXISTING FEEDER
ACID PUMP	1	REUSE EXISTING FEEDER
ACID SYSTEM	1	(1) 55 GAL ACID VAT WITH LID AND QUICK DISCONNECT ACID VENTING KIT VENTED TO EXTERIOR OF BUILDING
U.V. SYSTEM		HANOVIA MODEL UV SWIM I-200+ PROVIDING A 60mj AVERAGE DOSE @ 413 GPM (VOLTAGE TO BE CONFIRMED)
CHECK VALVE	1	TITAN CV 41-DI 4" CHECK VALVE (PUMP DISCHARGE)
DHU CIRCULATION PUMP	1	TBD
DHU CIRCUIT SETTER	1	TBD
SUMP PUMP GRATING	1	12" SQ. DURADECK I-4000 1" THICK
SIGHT GLASS	1	SR SMITH 1.5" SIGHT GLASS
EXIS	TIN	G MECHANICAL EQUIPMENT LIST
	NO	RTH HARFORD MIDDLE SCHOOL - PHASE II
CHEMICAL CONTROLLER		REUSE EXISTING CONTROLLER
WATER LEVEL CONTROLLER	1	REUSE EXISTING - AQUATICONTROL #ELC-810-DS-ST, DUAL SENSORS (HIGH LEVEL & AUTO FILL) FOR SURGE TANK APPLICATION
SOLENOID VALVE - AUTO FILL	1	REUSE EXISTING - GRANZOW #W6000 (SERIES W, NORMALLY CLOSED), 1" SLOW-CLOSING, NBR SEAL, 24V-AC - FURNISH LOOSE

1 EXISTING TO REMAIN

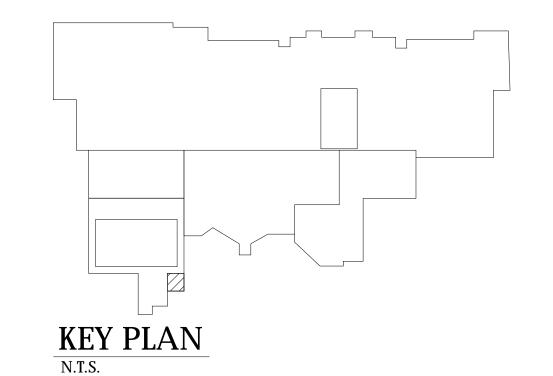

POOL SYMBOLS LEGEND: (NOT ALL USED)

MD - MAIN DRAIN

RT - RETURN VAC - VACUUM

PO - PERIMETER OVERFLOW FW - FRESH WATER

<u>FITTINGS</u>

V VACUUM GAUGE


P PRESSURE GAUGE TEMPERATURE GAUGE

FS)— FLOW SWITCH


S- SIGHT GLASS

FM> FLOWMETER - PLAN VIEW FLOWMETER - ELEVATION VIEW

POINT OF CONNECTION

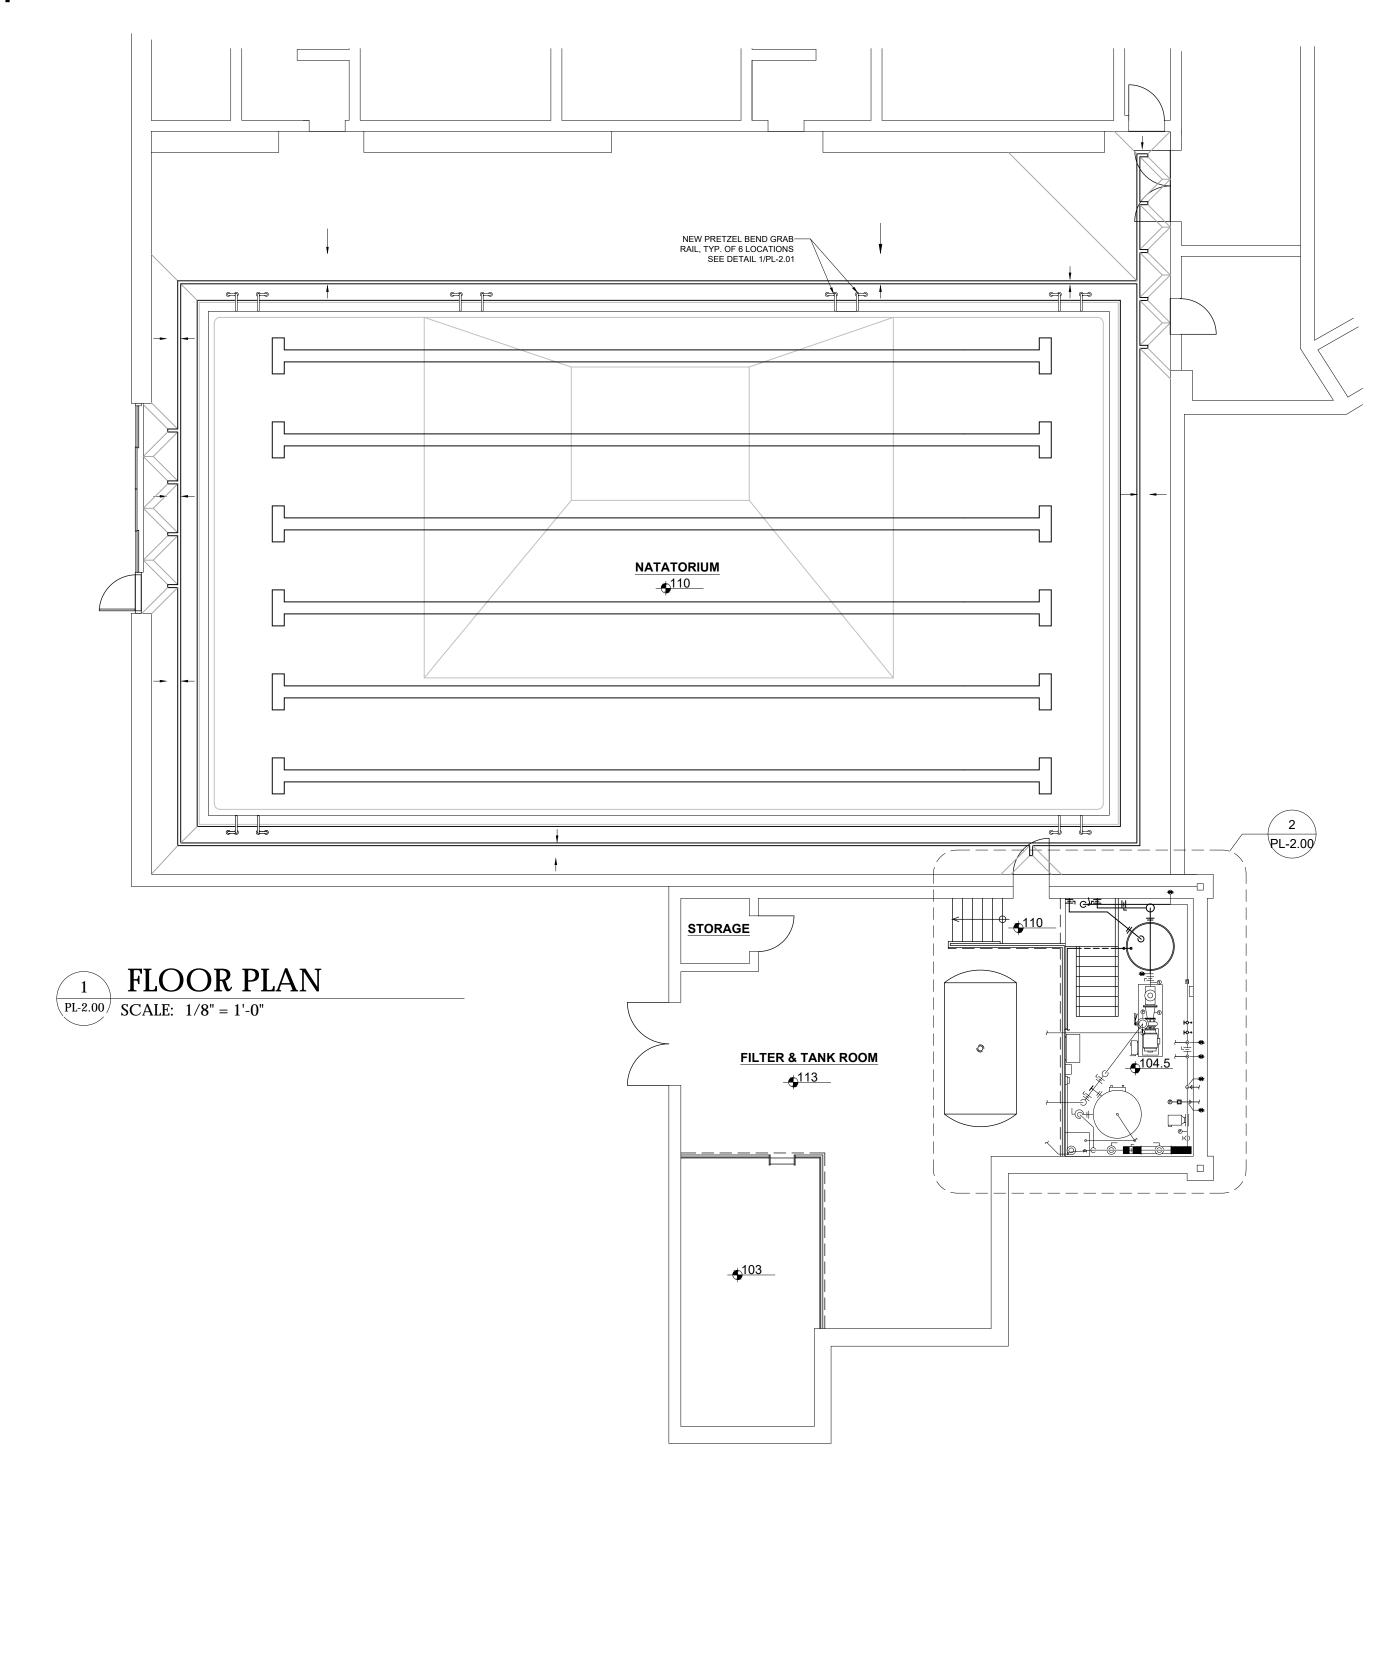

D	ESIGN DATA	
DIMENSIONS	42' X 75'-1"	
DEPTHS	3'-6" TO 4'-6" TO 9'-0" MAX	
PERIMETER	234 FT	
WATER SURFACE AREA		
DEEP	855 SF	
SHALLOW	2,289 SF	
TOTAL WATER SURFACE AREA	3,144 SF	
CAPACITY	109,339 GALLONS	
FILTER RATE	304 GPM	
TURNOVER TIME	6 HR	
MAXIMUM BATHER LOAD	251 BATHERS	

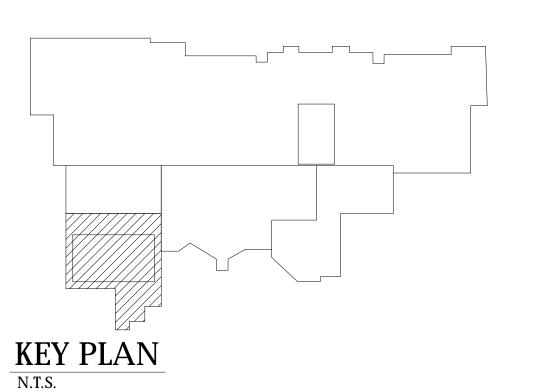

ARCHITECT

SMOLEN • EMR
• ILKOVITCH
ARCHITECTS

9211 CORPORATE BLVD., SUITE 340 ROCKVILLE, MD 20850 301-770-0177

MEP ENGINEER

ALBAN ENGINEERING 303 INTERNATIONAL CIRCLE SUITE 450 HUNT VALLEY, MD 21030 410.842.6411

PROFESSIONAL CERTIFICATION.
I CERTIFY THAT THESE DOCUMENTS WERE PREPARED BY OR APPROVED BY ME AND THAT I AM A DULY LICENSED ARCHITECT UNDER THE LAWS OF THE STATE OF MARYLAND, LICENSE # 16066, EXPIRATION DATE 01/06/20.

PROFESSIONAL SEAL:

PRINTS ISSUED

DESCRIPTION 50% CDs 12/5/18 **BID SET**

ADDENDUM #1 1/24/19 ADDENDUM #2 | 2/13/19 **PERMIT SET** 3/27/19

CONFORM. SET 4/25/19

NORTH HARFORD MIDDLE SCHOOL **POOL REPAIRS PHASES 2 & 3**

112 PYLESVILLE ROAD PYLESVILLE,MD 21132 HARFORD COUNTY PUBLIC SCHOOLS


SHEET TITLE

PROPOSED FLOOR PLAN & **ENLARGED PLANS**


17013.0100 APR 25 2019 **AS NOTED**

PL-2.00


2018 Repair

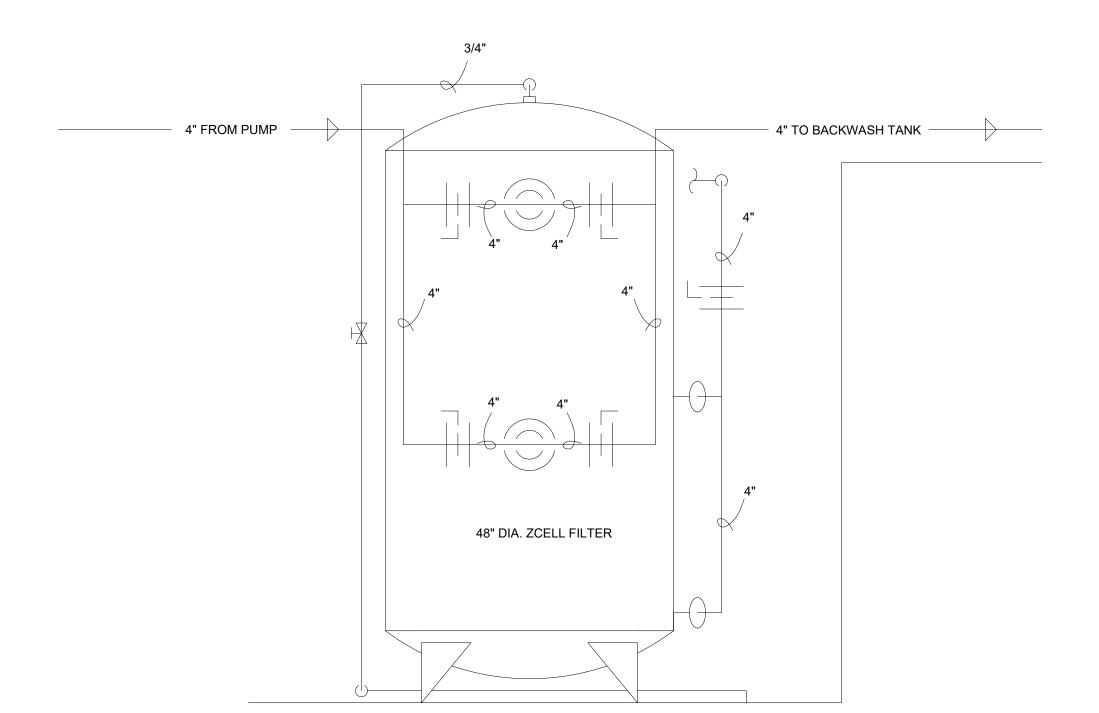


3 POOL FILTER ELEVATION
SCALE: 3/4" = 1'-0"

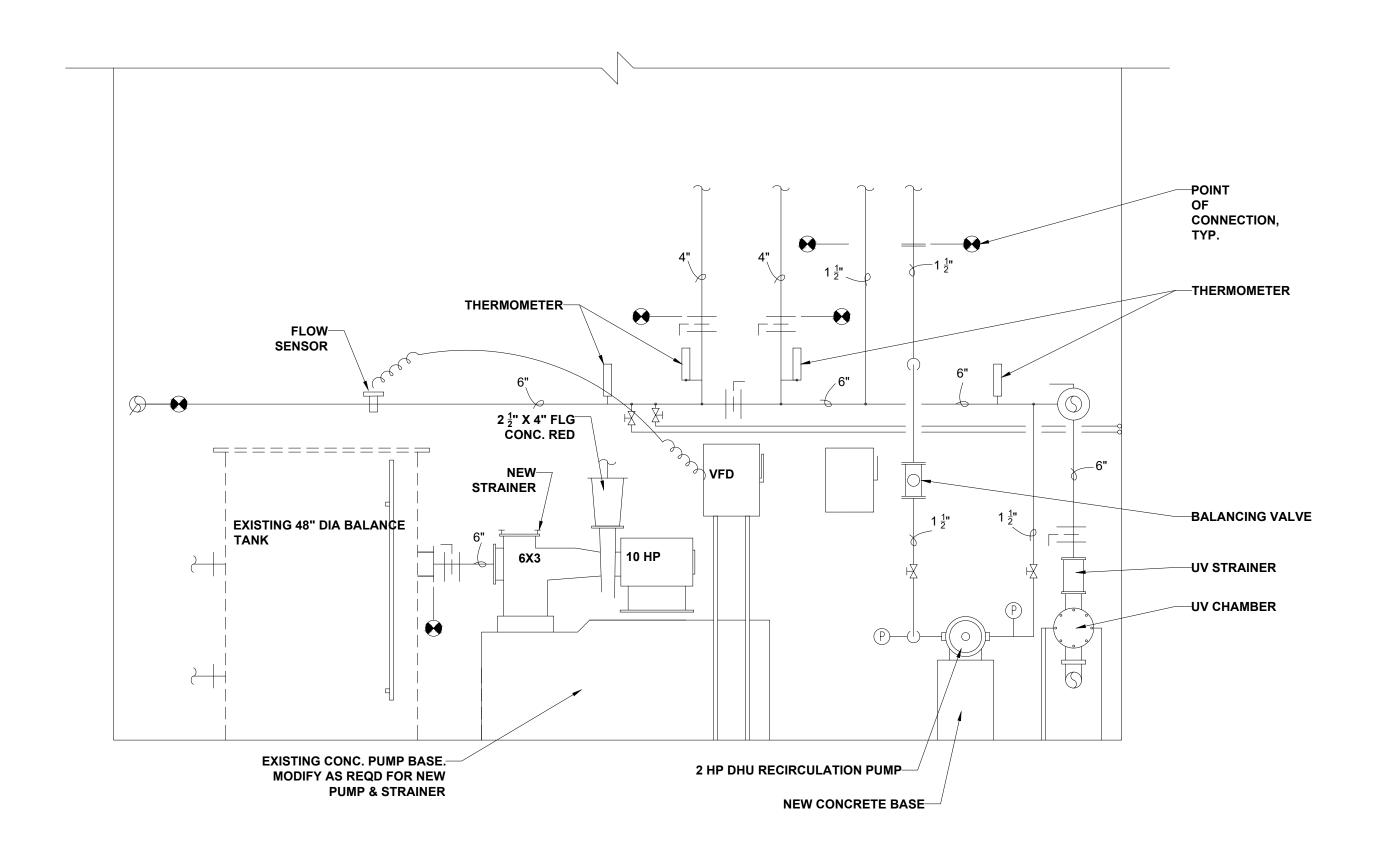


PL-2.01 SCALE: 1/2" = 1'-0"

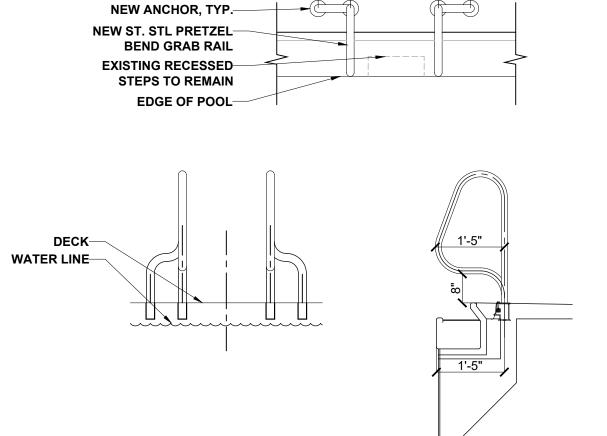

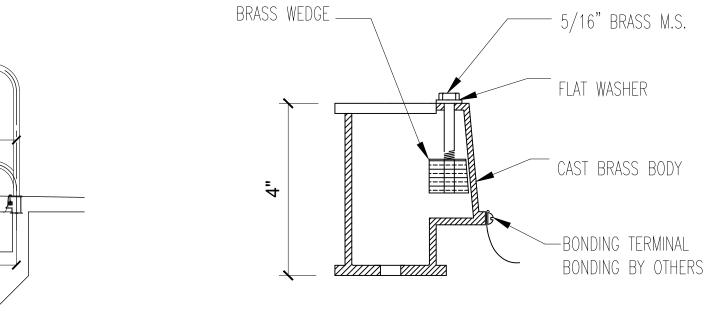


WEDGE ANCHOR DETAIL FOR HANDRAILS

SCALE: 1-1/2" = 1'-0"

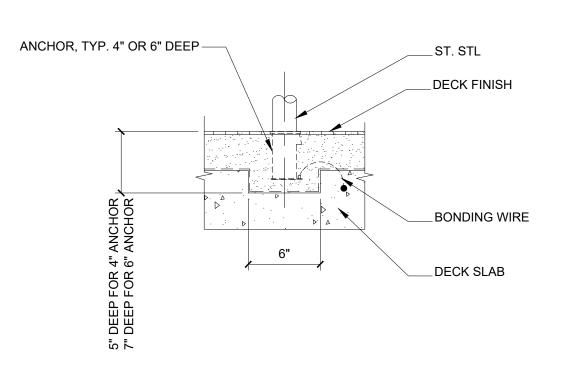

TYP. DECK ANCHOR DETAIL

SCALE: 1- 1/2" = 1'-0"

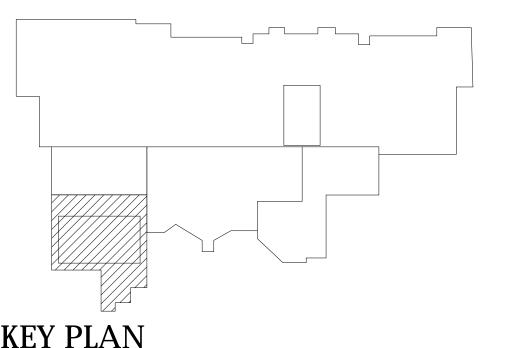

ARCHITECT

9211 CORPORATE BLVD., SUITE 340

ROCKVILLE, MD 20850 301-770-0177

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SHEET TITLE

POOL DETAILS

17013.0100 APR 25 2019


AS NOTED SHEET NO.

PL-2.01

PRETZEL BEND GRAB RAIL DETAIL

SCALE: 1/2" = 1'-0"

KEY PLAN

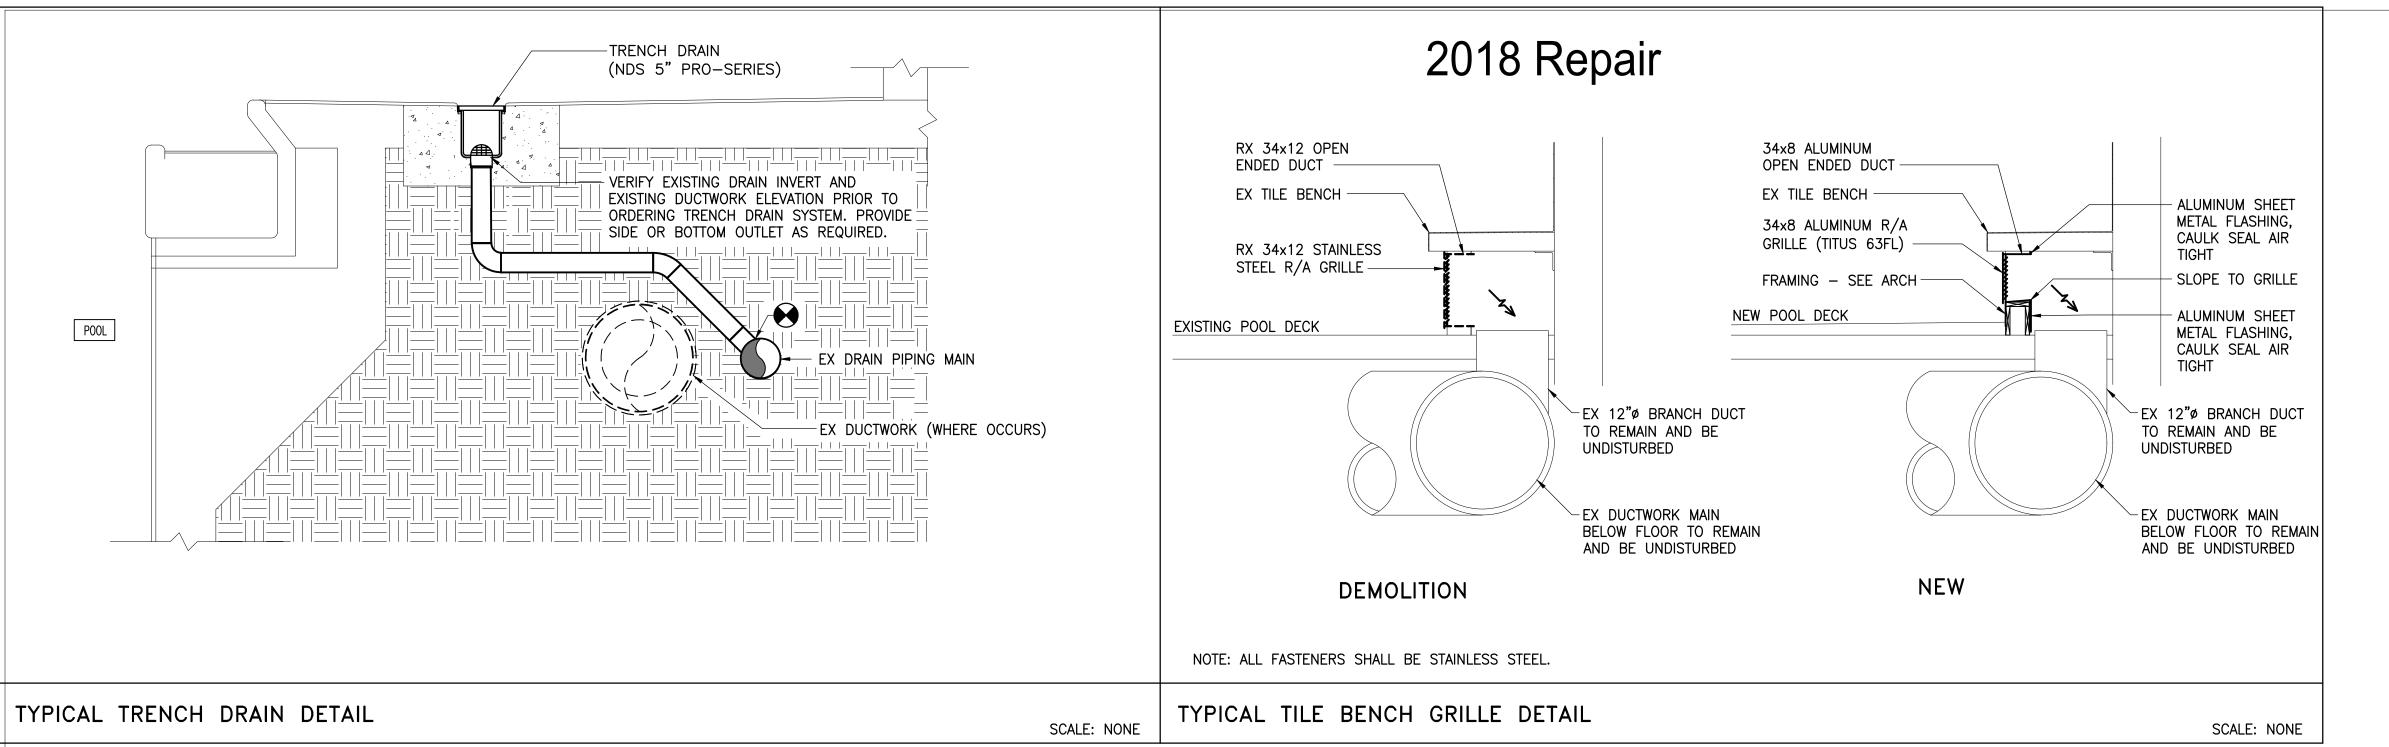

- 1) EXISTING DUCTWORK BELOW FLOOR TO REMAIN.
- EXISTING DRAIN PIPING BELOW FLOOR.
- 3 REMOVE EXISTING FLOOR DRAIN.
- TRENCH DRAIN:
 5" WIDE MODULAR POLYPROPYLENE TRENCH DRAIN W/ ADA POLYPROPYLENE LIGHT DUTY GRATE. INSTALL PER MANUFACTURERS RECOMMENDATIONS. VERIFY EXISTING PIPING INVERT AND EXISTING DUCTWORK ELEVATION PRIOR TO ORDERING TRENCH DRAIN SYSTEM. PROVIDE SIDE OR BOTTOM OUTLET AS REQUIRED. (BASED ON NDS MODEL 5" PRO-SERIES CHANNEL DRAIN)
- CONNECT TRENCH DRAIN TO EXISTING DRAIN PIPING BELOW FLOOR. EXISTING DUCTWORK BELOW FLOOR TO REMAIN UNDISTURBED. FIELD VERIFY EXACT LOCATION OF EXISTING DRAIN PIPING PRIOR TO INSTALLATION. REFER TO TYPICAL TRENCH DRAIN DETAIL FOR ADDITIONAL INFORMATION.
- REMOVE EXISTING 34x12 STAINLESS STEEL R/A GRILLE AND ALL ASSOCIATED APPURTENANCES. REFER TO TYPICAL TILE BENCH GRILLE DETAIL FOR ADDITIONAL INFORMATION.
- PROVIDE 34x8 ALUMINUM R/A GRILLE (TITUS 63FL). EXTEND 34x8 ALUMINUM SHEET METAL DUCTWORK INTO TILE BENCH PLENUM SPACE AND UTILIZE SHEET METAL AS FLASHING AGAINST GRILLE FRAME WORK. CAULK SEAL ALL JOINTS AND SEAMS AIR TIGHT. ALL FASTENERS SHALL BE STAINLESS STEEL. REFER TO TYPICAL TILE BENCH GRILLE DETAIL FOR ADDITIONAL INFORMATION.
- ADD ALTERNATE #4: REMOVE EXISTING 34x12 STAINLESS STEEL R/A GRILLE. EXISTING DUCTWORK TO REMAIN.
- ADD ALTERNATE #4: PROVIDE 34x12 ALUMINUM R/A GRILLE (TITUS 63FL). CONNECT TO EXISTING DUCTWORK.

DRAWING NOTES:

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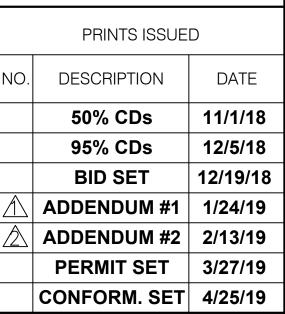
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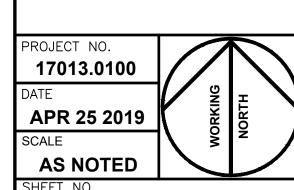


NORTH HARFORD MIDDLE SCHOOL **POOL REPAIRS PHASES 2 & 3**


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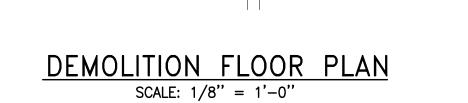
SCHOOLS

SHEET TITLE PLUMBING PLANS



P-1.00



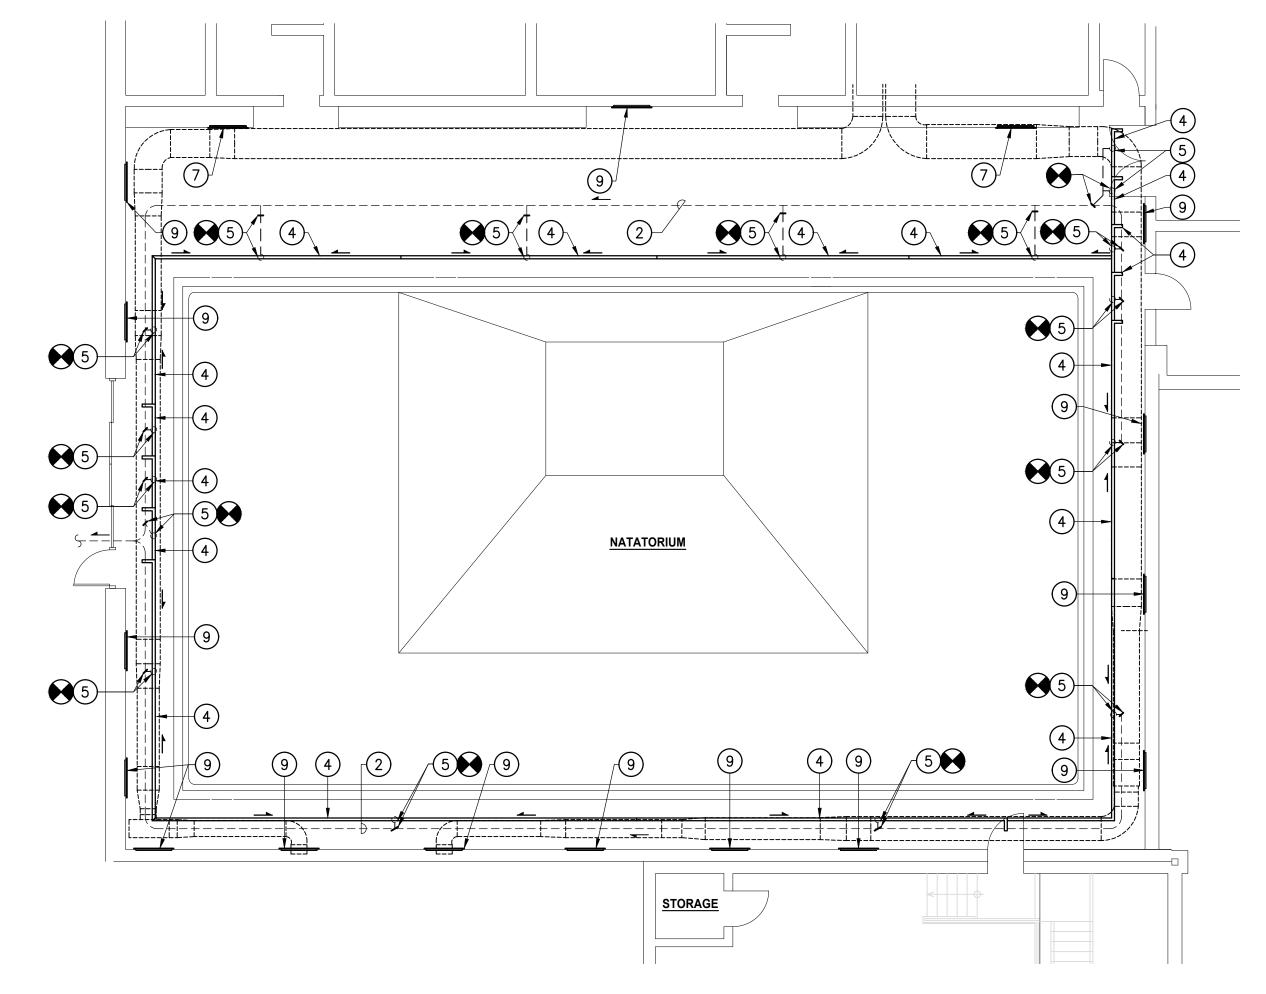

\(3)

8 3

PROPOSED FLOOR PLAN SCALE: 1/8'' = 1'-0''

SCALE: 1/8" = 1'-0"

GENERAL MECHANICAL REQUIREMENTS

RELATED DOCUMENTS:

1.01 SUMMARY:

- A. ALL WORK UNDER THIS DIVISION IS SUBJECT TO THE GENERAL CONDITIONS AND SPECIAL REQUIREMENTS FOR THE ENTIRE CONTRACT.
- B. PROVIDE ALL LABOR, MATERIALS, EQUIPMENT, AND SERVICES NECESSARY FOR AND INCIDENTAL TO THE COMPLETE INSTALLATION AND OPERATION OF ALL MECHANICAL WORK.
- C. UNLESS OTHERWISE SPECIFIED, ALL SUBMISSIONS SHALL BE MADE TO, AND ACCEPTANCES AND APPROVALS MADE BY THE ARCHITECT AND THE ENGINEER.
- D. CONTRACT DRAWINGS ARE GENERALLY DIAGRAMMATIC AND ALL OFFSETS, FITTINGS, TRANSITIONS AND ACCESSORIES ARE NOT NECESSARILY SHOWN. FURNISH AND INSTALL ALL SUCH ITEMS AS MAY BE REQUIRED TO FIT THE WORK TO THE CONDITIONS ENCOUNTERED. ARRANGE PIPING, DUCTWORK, EQUIPMENT, AND OTHER WORK GENERALLY AS SHOWN ON THE CONTRACT DRAWINGS, PROVIDING PROPER CLEARANCE AND ACCESS.
- E. CONFORM TO THE REQUIREMENTS OF ALL RULES, REGULATIONS AND CODES OF LOCAL, STATE AND FEDERAL AUTHORITIES HAVING JURISDICTION.
- F. COORDINATE THE WORK UNDER THIS DIVISION WITH THE WORK OF ALL OTHER CONSTRUCTION TRADES.
- G. BE RESPONSIBLE FOR ALL CONSTRUCTION MEANS, METHODS, TECHNIQUES, PROCEDURES, AND PHASING SEQUENCES USED IN THE WORK. FURNISH ALL TOOLS, EQUIPMENT AND MATERIALS NECESSARY TO PROPERLY PERFORM THE WORK IN FIRST CLASS, SUBSTANTIAL, AND WORKMANLIKE MANNER, IN ACCORDANCE WITH THE FULL INTENT AND MEANING OF THE CONTRACT DOCUMENTS.

1.02 PERMITS AND FEES:

A. OBTAIN ALL PERMITS AND PAY TAXES, FEES AND OTHER COSTS IN CONNECTION WITH THE WORK. FILE NECESSARY PLANS, PREPARE DOCUMENTS, GIVE PROPER NOTICES AND OBTAIN NECESSARY APPROVALS. DELIVER INSPECTION AND APPROVAL CERTIFICATES TO OWNER PRIOR TO FINAL ACCEPTANCE OF THE WORK.

1.03 EXAMINATION OF SITE:

A. EXAMINE THE SITE, DETERMINE ALL CONDITIONS AND CIRCUMSTANCES UNDER WHICH THE WORK MUST BE DONE, AND MAKE ALL NECESSARY ALLOWANCES FOR SAME. NO ADDITIONAL COST TO THE OWNER WILL BE PERMITTED FOR CONTRACTOR'S FAILURE TO DO SO.

1.04 CONTRACTOR QUALIFICATION:

A. ANY CONTRACTOR OR SUBCONTRACTOR PERFORMING WORK UNDER DIVISION 15 SHALL BE FULLY QUALIFIED AND ACCEPTABLE TO THE ENGINEER.

1.05 MATERIALS AND EQUIPMENT:

A. MATERIALS AND EQUIPMENT INSTALLED AS A PERMANENT PART OF THE PROJECT SHALL BE NEW, UNLESS OTHERWISE INDICATED OR SPECIFIED, AND OF THE SPECIFIED TYPE AND QUALITY. WHERE MATERIAL OR EQUIPMENT IS IDENTIFIED BY PROPRIETARY NAME, MODEL NUMBER AND/OR MANUFACTURER, FURNISH NAMED ITEM

1.06 FIRE SAFE MATERIALS:

A. UNLESS OTHERWISE INDICATED, MATERIALS AND EQUIPMENT SHALL CONFORM TO UL, NFPA OR ASTM STANDARDS FOR FIRE SAFETY WITH SMOKE AND FIRE HAZARD RATING NOT EXCEEDING FLAME SPREAD OF 2.04 GRILLES: 25 AND SMOKE DEVELOPED OF 50.

1.07 REFERENCED STANDARDS, CODES AND SPECIFICATIONS:

A. ALL APPLICABLE SPECIFICATIONS, CODES AND STANDARDS ARE INCLUDED AS PART OF THIS SPECIFICATION, LATEST EDITION.

1.08 SUBMITTALS, REVIEW AND ACCEPTANCE:

A. EQUIPMENT, MATERIALS, INSTALLATION, WORKMANSHIP AND ARRANGEMENT OF WORK ARE SUBJECT TO REVIEW AND ACCEPTANCE. NO SUBSTITUTION WILL BE PERMITTED AFTER ACCEPTANCE OF EQUIPMENT OR MATERIALS EXCEPT WHERE SUCH SUBSTITUTION IS CONSIDERED BY THE ENGINEER TO BE IN BEST INTEREST OF OWNER.

1.09 SHOP DRAWINGS:

A. PREPARE AND SUBMIT SHOP DRAWINGS FOR ALL SPECIALLY FABRICATED ITEMS, MODIFICATIONS TO STANDARD ITEMS, SPECIALLY DESIGNED SYSTEMS WHERE DETAILED DESIGN IS NOT SHOWN ON THE CONTRACT DRAWINGS. OR WHERE THE PROPOSED INSTALLATION DIFFERS FROM THAT SHOWN ON CONTRACT DRAWINGS.

1.10 SUPERVISION AND COORDINATION:

- A. PROVIDE COMPLETE SUPERVISION, DIRECTION, SCHEDULING, AND COORDINATION OF ALL WORK UNDER THE CONTRACT. INCLUDING THAT OF SUBCONTRACTORS.
- B. COORDINATE ROUGH-IN OF ALL WORK AND INSTALLATION OF SLEEVES, ANCHORS, AND SUPPORTS FOR PIPING. AND OTHER WORK PERFORMED UNDER THIS DIVISION.

1.11 CUTTING AND PATCHING:

- A. ACCOMPLISH ALL CUTTING AND PATCHING NECESSARY FOR THE INSTALLATION OF WORK UNDER THIS DIVISION. DAMAGE RESULTING FROM THIS WORK TO OTHER WORK ALREADY IN PLACE, SHALL BE REPAIRED AT CONTRACTOR'S EXPENSE. WHERE CUTTING IS REQUIRED, PERFORM WORK IN NEAT AND WORKMANLIKE MANNER. USE MECHANICS SKILLED IN THE PARTICULAR TRADES REQUIRED.
- B. CUT RIGID MATERIALS USING TOOLS WHICH WILL PROVIDE A SMOOTH AND EVEN SURFACE; E.G., MASONRY SAW OR CORE DRILL. PAINT EXTERIOR SLEEVES AND ESCUTCHEONS TO MATCH EXISTING COLOR.

1.12 CONNECTIONS AND ALTERATIONS TO EXISTING WORK:

- A. WHEN WORK UNDER THIS DIVISION CONNECTS TO EXISTING EQUIPMENT, PIPING, ETC., CONTRACTOR SHALL PERFORM ALL NECESSARY ALTERATIONS, CUTTINGS, FITTINGS, ETC., OF EXISTING WORK AS MAY BE NECESSARY TO MAKE SATISFACTORY CONNECTIONS BETWEEN NEW AND EXISTING WORK, AND TO LEAVE COMPLETED WORK IN A FINISHED AND WORKMANLIKE CONDITION.
- B. THE CONTRACTOR SHALL BE RESPONSIBLE FOR PROTECTING ALL SCHOOL PROPERTY WHERE WORK IS BEING PERFORMED. THE CONTRACTOR SHALL KEEP CLEAN AND MAINTAIN EACH AREA FOR USE AFTER WORK IN THAT AREA IS COMPLETE.

1.13 DEMOLITION

- A. EXISTING PIPING, EQUIPMENT, DUCTWORK, MATERIALS, ETC., NOT REQUIRED FOR RE-USE OR RE-INSTALLATION IN THIS PROJECT, SHALL BE REMOVED
- B. DELIVER TO THE OWNER, ON THE PREMISES WHERE DIRECTED, EXISTING EQUIPMENT AND MATERIALS WHICH ARE REMOVED AND WHICH ARE DESIRED BY THE OWNER OR ARE INDICATED TO REMAIN THE PROPERTY OF THE OWNER.
- C. ALL OTHER MATERIALS AND EQUIPMENT WHICH ARE REMOVED SHALL BECOME PROPERTY OF THE CONTRACTOR AND SHALL BE PROMPTLY REMOVED, BY HIM, FROM THE PREMISES, AND DISPOSED OF IN AN APPROVED MANNER.
- D. WHERE PIPING AND/OR DUCTWORK IS REMOVED, REMOVE ALL PIPE OR DUCTWORK HANGERS WHICH WERE SUPPORTING THE REMOVED PIPING OR DUCTWORK.

PRODUCTS:

2.01 PIPE MATERIALS

A. ALL MATERIALS, UNLESS OTHERWISE SPECIFIED, SHALL BE NEW AND OF THE BEST QUALITY OF THEIR RESPECTIVE KINDS, AND SHALL CONFORM TO THE REQUIREMENTS AND ORDINANCES OF LOCAL AND INSURANCE AUTHORITIES HAVING JURISDICTION.

1. DRAIN AND VENT PIPING:

SCHEDULE 40 SOLID WALL POLYVINYL CHLORIDE (PVC) PLASTIC PIPE (TYPE DWV), ASTM D 1784 WITH POLYVINYL CHLORIDE (PVC) FITTINGS, ASTM D 2665 WITH SOLVENT CEMENT JOINTS. JOINTS BETWEEN DIFFERENT MATERIALS SHALL BE MADE WITH A MECHANICAL JOINT OF THE COMPRESSION OR MECHANICAL SEALING TYPE. CONNECTORS OR ADAPTORS SHALL HAVE AN ELASTOMERIC SEAL ALL JOINTS SHALL BE INSTALLED IN ACCORDANCE WITH THE MANUFACTURER'S INSTRUCTION. BURIED PIPES SHALL BE INSTALLED IN ACCORDANCE WITH ASTM D 2321 AND ASTM F 1668. SOLVENT CEMENT JOINTS SHALL BE MADE IN A 2-STOP PROCESS WITH PRIMER CONFORMING TO ASTM F 656 AND SOLVENT CONFORMING TO ASTM D 2564. FOAM CORE PIPING IS PROHIBITED.

2.02 PIPE HANGERS, ROLLER SUPPORTS, ANCHORS, GUIDES, AND SADDLES:

ALL HANGERS FOR METALLIC PIPING SHALL BE ADJUSTABLE, WROUGHT CLEVIS TYPE, OR ADJUSTABLE MALLEABLE SPLIT RING SWIVEL TYPE, HAVING RODS WITH MACHINE THREADS. HANGERS SHALL BE GRINNELL COMPANY'S FIGURE 260 FOR PIPE 3/4" AND LARGER, AND FIGURE 65 FOR PIPE 1/2" AND SMALLER, OR APPROVED EQUAL. ADJUSTABLE PIPE STANCHION WITH U-BOLT SHALL BE GRINNELL COMPANY'S FIGURE 191. PIPE ROLLER SUPPORTS SHALL BE GRINNELL'S FIGURE 181 OR FIGURE 271. PROVIDE PIPE COVERING PROTECTION SADDLES FOR HOT TEMPERATURE SERVICE, PIPING SYSTEMS, SIMILAR TO GRINNELL, FIGURES 160-165. PROVIDE INSULATION PROTECTION SHIELDS FOR ALL PIPING SYSTEMS. EXTERIOR PIPE HANGERS SHALL BE GALVANIZED CONSTRUCTION. PROVIDE PIPE HANGER FLANGE, GRINNELL FIGURE 153, FOR PIPING LOCATED IN EXPOSED AREAS (EXCEPT FOR MECHANICAL EQUIPMENT ROOMS).

2.03 DUCTWORK:

- A. UNLESS OTHERWISE INDICATED OR SPECIFIED, FABRICATE DUCTWORK OF GALVANIZED SHEET STEEL, STAINLESS STEEL. OR ALUMINUM CONFORMING TO COMMERCIAL DESIGNATION 3003 TEMPER H14 AND DUCT SHEET. DUCT GAGES, JOINTING AND ENFORCEMENT SHALL CONFORM TO TABLES 4, 5, 6 AND 7, AS APPLICABLE, CHAPTER I OF THE LATEST ASHRAE GUIDE AND DATA BOOK. CONSTRUCTION DETAILS SHALL CONFORM TO SECTION I AND SECTION II, AS APPLICABLE, OF DUCT MANUAL AND SHEET METAL CONSTRUCTION FOR VENTILATION AND AIR CONDITIONING SYSTEMS AS PUBLISHED BY SHEET METAL AND AIR CONDITIONING CONTRACTORS' ASSOCIATION, INC.
- B. ERECT SHEET METAL DUCTWORK IN A FIRST-CLASS, WORKMANLIKE MANNER SECURED IN PLACE RIGIDLY AND PERMANENTLY. PROVIDE SUITABLE HANGERS, SECURELY ATTACHED TO BUILDING CONSTRUCTION WITH BOLTS, CLIPS OR INSERTS. HANGERS SHALL BE STRUCTURAL SHAPES, FLAT BARS, OR FORMED STRAP HANGERS; USE OF WIRE WILL NOT BE PERMITTED. HANGERS SHALL NOT PASS THROUGH OR BE INSIDE DUCT. SUPPORT VERTICAL DUCTS PASSING THROUGH FLOORS BY ANGLES RIVETED TO DUCT AND RESTING EITHER ON FLOOR OR ON BRACKETS SECURED TO BUILDING CONSTRUCTION. ALL SPACE AROUND DUCT WHERE THEY PASS THROUGH ANY WALLS, FLOORS, CEILINGS, OR ROOFS SHALL BE SEALED TIGHT WITH INCOMBUSTIBLE INERT MATERIAL. DO NOT ARRANGE DUCTS SO AS TO IMPAIR THE EFFECTIVENESS OF FIREPROOFING AROUND STRUCTURAL MEMBERS. PROVIDE SHEET METAL FLANGED COLLARS AROUND EXPOSED DUCTS PASSING THROUGH WALLS, FLOORS, OR CEILINGS IN FINISHED AREAS TO PROVIDE FINISHED APPEARANCE. SEAL ALL DUCT JOINTS AND SEAMS INCLUDING LOW PRESSURE SUPPLY AND RETURN, OUTSIDE AIR AND EXHAUST DUCTWORK WITH "HARDCAST" SEALING SYSTEM AS MANUFACTURED BY HARDCAST, INC., OR APPROVED EQUAL

- A. HEAVY DUTY REGISTER:
 - BASIS-OF-DESIGN PRODUCT: THE MANUFACTURER SHALL PROVIDE PUBLISHED PERFORMANCE DATA FOR THE GRILLE. THE GRILLE SHALL BE TESTED IN ACCORDANCE WITH 3.05 WALL AND FLOOR PENETRATION: ANSI/ASHRAE STANDARD 70-1991. SUBJECT TO COMPLIANCE WITH REQUIREMENTS. PROVIDE TITUS MODEL 63FL, ONE-HALF-INCH BAR SPACING AND 30 DEGREE DEFLECTION OR COMPARABLE PRODUCT BY ONE OF THE FOLLOWING:
 - a. METALLAIRE, INC. b. KRUEGER.
 - c. PRICE INDUSTRIES.

2. MATERIAL: MATERIAL SHALL BE ALUMINUM.

- 3. FINISH: THE FINISH SHALL BE #26 WHITE. THE FINISH SHALL BE AN ANODIC ACRYLIC PAINT, BAKED AT 315 DEG F FOR 30 MINUTES. THE PENCIL HARDNESS MUST BE HB TO H. THE PAINT MUST PASS A 100-HOUR ASTM D117 CORROSIVE ENVIRONMENTS SALT SPRAY TEST WITHOUT CREEPAGE, BLISTERING, OR DETERIORATION OF FILM. THE PAINT MUST PASS A 250 HOUR ASTM 0870 WATER IMMERSION TEST. THE PAINT MUST ALSO PASS THE ASTM D-2794 REVERSE IMPACT CRACKING TEST WITH AS 50-INCH POUND FORCE APPLIED.
- 4. FACE ARRANGEMENT: AS SHOWN ON THE DEVICE SCHEDULE.
- 5. DEFLECTION BARS: THE FIXED DEFLECTION BARS SHALL BE PARALLEL TO THE LONG OR SHORT DIMENSION (PARALLEL WITH THE FLOOR) OF THE GRILLE OR REGISTER. BARS SHALL BE ALUMINUM. BARS SHALL BE REINFORCED BY PERPENDICULAR, ALUMINUM SUPPORT BARS SPACED ON SIX-INCH MAXIMUM CENTERS.
- 6. FRAME: ONE AND ONE-QUARTER-INCH BORDER WIDTH ON ALL SIDES AND A MINIMUM BORDER GAUGE THICKNESS OF 16. CORNERS SHALL BE WELDED WITH FULL PENETRATION RESISTANCE WELDS WITH A REINFORCING PATCH FOR EXTRA STRENGTH.
- 7. MOUNTING FRAME: REFER TO ARCHITECTURAL DRAWINGS FOR FINISH TYPE.

EXECUTION:

3.01 PIPING, GENERAL:

- A. ALL PIPES SHALL BE CUT ACCURATELY TO MEASUREMENTS ESTABLISHED AT THE BUILDING, AND SHALL BE WORKED INTO PLACE WITHOUT SPRINGING OR FORCING, PROPERLY CLEARING ALL WINDOWS, DOORS AND OTHER OPENINGS. EXCESSIVE CUTTING OR OTHER WEAKENING OF THE BUILDING STRUCTURE TO FACILITATE PIPING INSTALLATION WILL NOT BE PERMITTED. ALL PIPES SHALL BE SO INSTALLED AS TO PERMIT FREE EXPANSION AND CONTRACTION WITHOUT CAUSING DAMAGE. ALL HORIZONTAL MAINS SHALL PITCH DOWN IN THE DIRECTION OF FLOW WITH A GRADE OF NOT LESS THAN 1" IN 40'-0". ALL OPEN ENDS OF PIPE LINES, EQUIPMENT, ETC., SHALL BE PROPERLY CAPPED OR PLUGGED DURING INSTALLATION TO KEEP DIRT OR OTHER FOREIGN MATERIAL OUT OF THE SYSTEM. ALL PIPES SHALL BE RUN PARALLEL WITH THE LINES OF THE BUILDING AND AS CLOSE TO WALLS, COLUMNS AND CEILINGS AS MAY BE PRACTICAL, WITH PROPER PITCH. ALL PIPING SHALL BE ARRANGED SO AS NOT TO INTERFERE WITH REMOVAL OF OTHER EQUIPMENT ON DEVICES NOT TO BLOCK ACCESS TO DOORS, WINDOWS, MANHOLES, OR OTHER ACCESS OPENINGS. FLANGES OR UNIONS, AS APPLICABLE FOR THE TYPE OF PIPING SPECIFIED, SHALL BE PROVIDED IN THE PIPING AT CONNECTIONS TO ALL ITEMS OF EQUIPMENT COILS, ETC., AND INSTALLED SO THAT THERE WILL BE NO INTERFERENCE WITH THE INSTALLATION OF THE EQUIPMENT, DUCTS, ETC. ALL VALVES AND SPECIALTIES SHALL BE PLACED TO PERMIT EASY OPERATION AND ACCESS AND ALL VALVES SHALL BE REGULATED, PACKED AND GLANDS ADJUSTED AT THE COMPLETION OF THE WORK BEFORE FINAL ACCEPTANCE. ALL PIPING SHALL BE INSTALLED SO AS TO AVOID AIR OR LIQUID POCKETS THROUGHOUT THE WORK. ENDS OF PIPE SHALL BE REAMED SO AS TO REMOVE ALL BURRS.
- B. ALL PIPING SHALL BE RUN TO PROVIDE A MINIMUM CLEARANCE OF 1/2" BETWEEN FINISHED COVERING ON SUCH PIPING AND ALL ADJACENT WORK. ALL VALVES, STRAINERS, CAPS, AND OTHER FITTINGS SHALL BE READILY ACCESSIBLE. ROUGH-IN AND FINAL CONNECTIONS ARE REQUIRED TO ALL EQUIPMENT PROVIDED UNDER THIS CONTRACT.

3.02 HANGERS, SUPPORTS, ANCHORS, GUIDES:

- A. GENERAL: ALL HANGERS SHALL BE OF AN APPROVED TYPE ARRANGED TO MAINTAIN THE REQUIRED GRADING AND PITCHING OF LINES TO PREVENT VIBRATION AND TO PROVIDE FOR EXPANSION AND CONTRACTION. PROVIDE INSULATION PROTECTION SHIELDS FOR INSULATED PIPING WITHOUT SADDLES. SHIELD SHALL BE GRINNELL'S FIGURE 167, OR AS APPROVED EQUAL.
- B. SPACING: REGARDLESS OF SPACING, HANGERS SHALL BE PROVIDED AT OR NEAR ALL CHANGES IN DIRECTION, BOTH VERTICAL AND HORIZONTAL, FOR ALL PIPING.
- C. RACKS AND BRACKETS: ALL HORIZONTAL PIPING ON VERTICAL WALLS SHALL BE PROPERLY SUPPORTED BY SUITABLE RACKS SECURELY ANCHORED INTO THE WALL CONSTRUCTION. WHERE NOT PRACTICAL TO OBTAIN CEILING ANCHORAGE, ALL PIPING NEAR WALLS SHALL BE SUPPORTED BY APPROVED BRACKETS SECURELY ANCHORED INTO THE WALL CONSTRUCTION. WASHER PLATES (FIG. 60, 60L) AND OTHER MISCELLANEOUS ATTACHMENTS, FASTENERS, ETC., SHALL BE GRINNELL OR AS APPROVED EQUAL. ALL EXTERIOR HANGER AND BRACKET SYSTEMS IN THEIR ENTIRETY SHALL BE GALVANIZED.

3.03 CLEANING, PAINTING AND FINISHES:

A. PROVIDE PROTECTIVE FINISHES ON ALL MATERIALS AND EQUIPMENT. USE COATED OR CORROSION-RESISTANT MATERIALS, HARDWARE AND FITTINGS THROUGHOUT THE WORK. PAINT BARE, UNTREATED FERROUS SURFACES WITH RUST-INHIBITING PAINT. CLEAN SURFACES PRIOR TO APPLICATION OF INSULATION, ADHESIVES, COATINGS, PAINT, OR OTHER FINISHES.

3.04 PROTECTION OF WORK:

A. PROTECT WORK, MATERIAL AND EQUIPMENT FROM WEATHER AND CONSTRUCTION OPERATIONS BEFORE AND AFTER INSTALLATION. PROPERLY STORE AND HANDLE ALL MATERIALS AND EQUIPMENT

A. ALL PENETRATIONS OF PARTITIONS, CEILINGS, AND FLOORS BY PIPING OR CONDUIT UNDER THIS DIVISION SHALL BE SEALED AND CAULKED AIRTIGHT FOR SOUND AND AIR TRANSFER CONTROL AND/OR FIRE STOPPED FOR FIRE WALLS AND FLOORS.

LEGEND

SYMBOLS SYMBOL DEFINITION DRAIN PIPING - DRAIN PIPING BELOW FLOOR RETURN AIR DUCT UP, DOWN RETURN AIR GRILLLE & DUCT —O | PIPE UP PIPE UP & DOWN —— PIPE DOWN FLOOR DRAIN FLOOR DRAIN WITH TRAP PRIMER FLOOR SINK EXISTING TO REMAIN -- REMOVE EXISTING DEMOLITION ENDS HERE CONNECT TO EXISTING HERE

NOTE: NOT ALL SYMBOLS MAY BE USED.

ABBREV.	DEFINITION
AFF	ABOVE FINISHED FLOOR
APPROX	APPROXIMATE
CO	CLEANOUT
CONN	CONNECT
CW	COLD WATER
CX	CONNECT TO EXISTING
DIA	DIAMETER
DISH	DISCHARGE
DN	PIPE DOWN
DWG	DRAWING
ELEV	ELEVATION
EX	EXISTING
FS	FLOW SWITCH
FT	FEET
IN	INCHES
I.E.	INVERT ELEVATION
RX	REMOVE EXISTING
SAN, S	SANITARY
SW	STORM WATER
TD	TRENCH DRAIN
UP	PIPE UP
UP&DN	PIPE UP & DN

NOT ALL ABBREVIATIONS MAY BE USED.

ARCHITECT



MEP ENGINEER

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NORTH HARFORD MIDDLE SCHOOL **POOL REPAIRS PHASES 2 & 3**

112 PYLESVILLE ROAD PYLESVILLE.MD 21132 HARFORD COUNTY PUBLIC

SCHOOLS

SHEET TITLE

PLUMBING LEGEND & SPECIFICATIONS

17013.0100 **APR 25 2019 AS NOTED**

2018 Repair

		L FR1 I80/277V,3ø,4W		(EATON	۷)							OUNTING			TANK R	ООМ	
		ERE BUS		100	A M	СВ				100% RAT							00 A.I.C.
CONN			BR	EAKER		CIRCL	JIT WIR	ING			BR	EAKER		CIRCU	JIT WIR	ING	CONN
KVA	CKT	DESCRIPTION		AMPS	NO	SIZE	GND	С	СКТ	DESCRIPTION	Р	AMPS	NO	SIZE	GND	С	KVA
	1	BOOSTER PUMP	3	20	Ε>	COND	UIT & W	/IRING	2	EX CIRCUIT	3	20	Ε>	C COND	UIT & W	IRING	
	3	-	-	ı	-	-	-	-	4	-	-	-	-	-	-	1	
	5	-	-	-	-	-	-	-	6	-	-	-	-	-	-	-	
	7	WELL PUMP (SPARE)	3	15	ΕX	COND	UIT & W	IRING	8	WELL PUMP CNTL CIR.	3	15	Ε>	COND	UIT & W	IRING	
	9	-	-	-	-	-	-	-	10	-	-	-	-	-	-	-	
	11	-	-	-	-	-	-	-	12	-	-	-	-	-	-	-	
	13	SAND FILTER (OFF)	3	15	E	COND	UIT & N	IRING	14	SPACE	1	-					
	15	-	-	-	-	-	-	-	16	SPACE	1	-					
	17	-		-	-	-	-	-	18	SPACE	1	-					
	19	SPACE	1	-					20	SPACE	1	-					
	21	SPACE	1	-					22	SPACE	1	-					
	23	SPACE	1	-					24	SPACE	1	-					
	25	SPACE	1	-					26	SPACE	1	-					
	27	SPACE	1	ı					28	SPACE	1	-					
	29	SPACE	1	•					30	SPACE	1	-					
	31	SPACE	1	-					32	SPACE	1	-					
	33	SPACE	1	ı					34	SPACE	1	-					
	35	SPACE	1						36	SPACE	1	_					
	37	SPACE	1	ı					38	SPACE	1	-					
	39	SPACE	1	ı					40	SPACE	1	-					
	41	SPACE	1	-					42	SPACE	1	-					
TOTAL	CON	NECTED LOAD		0.0	KVA					KVA PER PHASE:	A	0.0	В	0.0	С	0.0)

EX. PANEL FR1 (MODIFIED) (EATON) OLTAGE: 480/277V,3ø,4W											CATION				ООМ		
100 AMPERE BUS 100 A MCB							100% RAT	ED N	UTRAL	BUS			10,0	0,000 A.I.C			
CONN			BREAKER CIRCUIT WIRING								BR	EAKER		CIRCU	JIT WIR	ING	CON
KVA	CKT	DESCRIPTION	Р	AMPS	NO	SIZE	GND	С	СКТ	DESCRIPTION	Р	AMPS	NO	SIZE	GND	С	KVA
	1	BOOSTER PUMP	3	20	E	(COND	UIT & W	IRING	2	EX. CIRCUIT	3	20	E	COND	UIT & W	IRING	
-	3	2" 1" 1" 1" 1" 1" 1" 1" 1" 1" 1" 1" 1" 1"	T le	122	₩.	- 30	4	2.1	4	2	1 52	15.11	l-o-	- 2	361	4	
	5	-		1.7	, , , ,	- 5	1.5	-	6	-		T			15	-	
= = 1	7	WELL PUMP (SPARE)	3	15	E	(COND	UIT & W	IRING	8	WELL PUMP CNTL CIR.	3	15	E	COND	UIT & W	IRING	
	9	-	10-0	7		- e	1		10	-	-	= 9 +	-		(4)	4	
	11	*	+	-	13-32	-	2.1		12	-	4	11.6			100	×	e r
	13	SAND FILTER (OFF)	3	15	E	COND	UIT & W	IRING	14	PUMP (2HP)	3	15	3	12	12	3/4	0.9
	15				1140	1.	0.00	10-11	16		14	- 1 · 1	12/		0.0		0.9
	17				14		112	-	18			-	-		(49)		0.9
	19	SPACE	1	1.5					20	SPACE	1						
	21	SPACE	1	1.2					22	SPACE	1		1-1				
	23	SPACE	1	12-			10-1		24	SPACE	1	164					
	25	SPACE	1	-					26	SPACE	1	4					
	27	SPACE	1	-					28	SPACE	1		(E)				
	29	SPACE	1	-					30	SPACE	1						
	31	SPACE	1	- 1					32	SPACE	1	~ ~ T	III.				
==	33	SPACE	1	127.1	= 1				34	SPACE	1	12					1
	35	SPACE	1					1	36	SPACE	1	779-21	1=1				
	37	SPACE	1	-					38	SPACE	1	-					
	39	SPACE	1	130					40	SPACE	1	2					
	41	SPACE	1	138				1	42	SPACE	1	1 3 1					

		L FR2 208/120V,3ø,4W		(EATON	1)							OUNTING			.V VIK 🗅		
		ERE BUS		100	A M	СВ				100% RATE					ANN		00 A.I.C.
CONN			BRI	EAKER		CIRCU	IIT WIR	ING			BR	EAKER		CIRCL	JIT WIR	ING	CONN
KVA	CKT	DESCRIPTION	Р	AMPS	NO	SIZE	GND	С	СКТ	DESCRIPTION	Р	AMPS	NO	SIZE	GND	С	KVA
	1	PIT SUMP PUMP	1	20	ΕX	CONDI	UIT & W	/IRING	2	CHEM FEED PUMPS	1	20	Ε>	(. COND	UIT & W	/IRING	
	3	RECPT	1	20	E	COND	UIT & W	/IRING	4	RECPT TREATMENT	1	20	Ε>	COND	UIT & W	/IRING	
	5	UNIT HEATERS	1	20	ΕX	COND	UIT & W	IRING	6	EXHAUST FAN	1	20	Ε>	COND	UIT & W	/IRING	
	7	CLOSET LIGHTS	1	15	ΕX	K COND	UIT & W	IRING	8	EX. CIRCUIT	1	20	Ε>	K. COND	UIT & W	/IRING	
	9	PIT GFI	1	20	ΕX	K COND	UIT & W	IRING	10	SPACE	1	-					
	11	SPACE	1	ı					12	SPACE	1	-					
	13	SPACE	1	-					14	SPACE	1	-					
	15	SPACE	1	-					16	SPACE	1	-					
	17	SPACE	1	ı					18	SPACE	1	-					
	19	SPACE	1	-					20	SPACE	1	-					
	21	SPACE	1	-					22	SPACE	1	-					
	23	SPACE	1	-					24	SPACE	1	-					
	25	SPACE	1	-					26	SPACE	1	-					
	27	SPACE	1	-					28	SPACE	1	-					
	29	SPACE	1	-					30	SPACE	1	-					
	31	SPACE	1	-					32	SPACE	1	-					
	33	SPACE	1	-					34	SPACE	1	-					
	35	SPACE	1	-					36	SPACE	1	-					
	37	SPACE	1	-					38	SPACE	1	-					
	39	SPACE	1	-					40	SPACE	1	-					
	41	SPACE	1	-					42	SPACE	1	-					
TOTAL	CON	NECTED LOAD		0.0	KVA					KVA PER PHASE:	Α	0.0	В	0.0	С	0.0	_)

GENERAL NOTES:

- 1. THE ELECTRICAL CONTRACTOR SHALL FAMILIARIZE HIMSELF WITH THE DRAWINGS OF ALL OTHER TRADES ON THE PROJECT. ELECTRICAL OR SYSTEMS CONNECTIONS INDICATED ON ARCHITECTURAL, MECHANICAL, CIVIL, STRUCTURAL, KITCHEN AND ALL OTHER DRAWINGS WHICH ARE PART OF THIS PROJECT, SHALL BE CONSIDERED A PART OF THIS CONTRACT AND SHALL BE PROVIDED BY THE ELECTRICAL CONTRACTOR AT NO EXTRA COST TO THE OWNER.
- 2. THE ELECTRICAL DRAWINGS ARE DIAGRAMMATIC IN NATURE AND AS SUCH SHALL NOT BE SCALED. REFER TO THE ARCHITECTURAL DRAWINGS FOR EXACT LOCATIONS OF DEVICES AND EQUIPMENT AND DIMENSIONAL INFORMATION PRIOR TO ROUGH-IN. COORDINATE LOCATIONS OF MECHANICAL EQUIPMENT WITH MECHANICAL CONTRACTOR PRIOR TO ROUGH-IN OF SERVICE EQUIPMENT AND WIRING.
- 3. THE CONTRACTOR SHALL BE RESPONSIBLE FOR DETERMINING THE EXACT ROUTING OF WIRING AND CONDUITS AND SHALL BE RESPONSIBLE FOR SIZING ALL BRANCH CIRCUIT WIRING TO LIMIT VOLTAGE DROP TO 3%. CONTRACTOR SHALL SIZE CONDUIT TO ACCOMMODATE WIRING PER NEC. 20 AMPERE CIRCUITS SHALL BE SIZED AS FOLLOWS:

	<i>(</i>	20 AMPERE	CIRCUIT	S
120 V	OLT	277 V	OLT	MINIMUM CONDUIT SIZE
WIRING LENGTH	WIRE SIZE	WIRING LENGTH	WIRE SIZE	CONDOIT SIZE
0' - 60'	#12	0' - 130'	#12	3/4"
60' - 100'	#10	130' - 210'	#10	3/4"
100' - 150'	#8	210' - 340'	#8	3/4"
150' - 240'	#6	340' - 540'	#6	3/4"
OVER 240'	#4	OVER 540'	#4	1"

- BRANCH CIRCUITS IN PANELBOARDS WITH 200% RATED NEUTRAL BUS AND ALL DIMMED LIGHTING CIRCUITS & ECM MOTORS SHALL HAVE DEDICATED NEUTRAL CONDUCTORS.
- SPLICE BLOCKS AND REDUCING PINS AS REQUIRED TO TERMINATE WIRING AND MAKE FINAL CONNECTIONS. 5. ELECTRICAL BOXES IN FIRE RATED PARTITIONS SHALL NOT EXCEED 16 SQUARE INCHES IN AREA (IF 4"x4"), SHALL BE MADE OF STEEL, AND SHALL BE SUCH THAT THE CUMULATIVE AREA OF BOX "CUTOUTS" IN THE FIREWALL DOES NOT EXCEED 100 SQUARE INCHES PER 100 SQUARE FEET OF WALL AREA. ELECTRICAL BOXES ON OPPOSITE SIDES OF THE SAME FIREWALL SHALL BE SEPARATED BY A HORIZONTAL AND VERTICAL DISTANCE OF NOT LESS THAN 24 INCHES. THE ELECTRICAL CONTRACTOR SHALL MAKE MINOR ADJUSTMENTS, AS NECESSARY, TO ELECTRICAL BOX LOCATIONS TO ENSURE COMPLIANCE WITH THIS REQUIREMENT SINCE BOX LOCATIONS AREA TYPICALLY NOT DIMENSIONED ON THE DRAWINGS. CONSULT ARCHITECT IF CLARIFICATION IS REQUIRED.

4. WIRING AND CONDUIT SIZES INDICATED IN PANEL SCHEDULES ARE MINIMUM ONLY. CONTRACTOR SHALL

BE RESPONSIBLE FOR DETERMINING EXACT WIRING AND CONDUIT SIZES. CONTRACTOR SHALL PROVIDE

6. ALL CONDUIT SHALL BE CONCEALED IN WALLS, FLOORS, ABOVE CEILING OR THROUGH MILLWORK. AT TIMES CONDUIT ROUTING IS SHOWN FOR CLARITY AND IN NO WAY PROVIDES THE CONTRACTOR ABILITY TO NOT PROVIDE CONCEALED CONDUIT AT ANY POINT OTHER POINT NOT SHOWN IN THE BUILDING. REFER TO SPECIFICATIONS FOR CONDUIT & WIRING REQUIREMENTS BASED ON APPLICATION.

DEMOLITION NOTES:

(EATON)

*D CURVE TYPE CB

EX. PANEL FR2 (MODIFIED)

VOLTAGE: 208/120V,3ø,4W

3 RECPT

9 PIT GFI

11 SPACE

13 SPACE

15 SPACE

17 SPACE

19 SPACE

21 SPACE

23 SPACE

25 SPACE

27 SPACE

29 SPACE

31 SPACE

33 SPACE

35 SPACE

37 SPACE

39 SPACE

41 SPACE

100 AMPERE BUS

CONN

KVA CKT

- 1. DEMOLITION DRAWING IS DIAGRAMMATIC IN NATURE. NO ATTEMPT HAS BEEN MADE TO SHOW ALL EXISTING ELECTRICAL WORK IN AREAS INDICATED TO BE RENOVATED. ALL EXISTING ELECTRICAL WORK IS TO REMAIN UNLESS OTHERWISE NOTED. WHEN AN ITEM IS INDICATED TO BE REMOVED, REMOVE ALL ASSOCIATED ELECTRICAL WORK BACK TO POINT OF SOURCE.
- 2. WHERE WORK PASSES THROUGH THE RENOVATION AREA TO SERVE OTHER PORTIONS OF THE BUILDING OR WORK IN THE RENOVATION AREA INDICATED TO REMAIN, IT SHALL BE SUITABLY RELOCATED AND THE SYSTEMS RESTORED TO NORMAL. COORDINATE ANY OUTAGES WITH OWNER 7 DAYS IN ADVANCE.
- 3. WORK INDICATED TO REMAIN SHALL BE SUITABLY PROTECTED AGAINST DAMAGE.
- 4. COORDINATE ALL DEMOLITION AND CONSTRUCTION ACTIVITIES WITH THE OWNER TO MINIMIZE DISRUPTION OF THE NORMAL DAILY FUNCTIONING OF THE OWNERS OCCUPIED AREAS.

ELECTRICAL LEGEND:

(MOUNTING HEIGHTS ARE TO CENTERLINE OF DEVICE UON)

OUTLETS

- DOUBLE DUPLEX RECEPTACLE; 2P, 3W, 20A, 125V, NEMA 5-20R;
- DUPLEX RECEPTACLE; 2P, 3W, 20A, 125V, NEMA 5-20R; GROUND FAULT

- DUPLEX RECEPTACLE; 2P, 3W, 20A, 125V, NEMA 5-20R; WEATHERPROOF AND WEATHER RESISTANT, GROUNT FAULT INTERRUPTER; MOUNT AT 18"

- SINGLE POLE MANUAL MOTOR STARTING SWITCH WITH H.O.A. SWITCH. MOUNT AT 48" AFF IN NEMA 1 ENCLOSURE U.O.N.
- SAFETY DISCONNECT SWITCH FUSED, NON-FUSED IN NEMA 1 ENCLOSURE U.O.N. MOUNT AT 48" A.F.F. U.O.N. RATING AND FUSING
- COMBINATION TYPE MOTOR STARTER; FVNR WITH CONTROL XFMR, RED AND GREEN INDICATING LIGHTS, HOA SELECTOR SWITCH, DISCONNECT SWITCH IN NEMA 1 ENCLOSURE UON; MOUNT AT 5'-6" A.F.F. TO TOP

- BRANCH CIRCUIT CONDUIT AND WIRING CONCEALED IN CEILING OR WALL SPACE, OR SURFACE MOUNTED WHERE NO CEILING OR WALL SPACE EXISTS; REFER TO PANEL SCHEDULES FOR MINIMUM WIRE AND CONDUIT SIZES
- BRANCH CIRCUIT CONDUIT AND WIRING IN SLAB, UNDER FLOOR OR UNDERGROUND; REFER TO PANEL SCHEDULES FOR MINIMUM WIRE AND CONDUIT SIZES

AMPERE, AMPERES

AUTHORITY HAVING JURISDICTION

CIRCUIT BREAKER

CONDUIT

DRAWING

ETR EXISTING TO REMAIN

ELECTRIC WATER COOLER EWC

FLA FULL LOAD AMPERES

FSS FUSED SAFETY SWITCH

GFCI GROUND FAULT CURRENT INTERRUPTING

KCMIL THOUSAND CIRCULAR MILS

KILOWATT

MAIN CIRCUIT BREAKER

MLO MAIN LUGS ONLY

MOUNTING HEIGHT

MANUFACTURER'S ASSOCIATION

REMOVE EXISTING

WATTS, WIRE, WIRES

TRANSFORMER XFMR

U.O.N. UNLESS OTHERWISE NOTED

- DUPLEX RECEPTACLE; 2P, 3W, 20A, 125V, NEMA 5-20R; MOUNT AT 18" AFF U.O.N.; SUBSCRIPTS: USB - PROVIDE USB IN FACEPLATE
- MOUNT AT 18" AFF U.O.N.; SUBSCRIPTS: USB PROVIDE USB IN FACEPLATE
- INTERRUPTER MOUNT AT 18" AFF UON.
- SPECIAL RECEPTACLE; AS NOTED; MOUNT AT 18" AFF U.O.N.
- SLASH INDICATES DEVICE TO BE MOUNTED AT 42" AFF OR 6" ABOVE COUNTER U.O.N.
- AFF U.O.N.

POWER

- PANELBOARD SURFACE MOUNTED. MOUNT AT 5'-6" A.F.F. TO TOP TOP OF PANEL.
- MOTOR AS NOTED
- JUNCTION BOX AS NOTED
- VARIABLE SPEED DRIVE; MOUNT AT 48" A.F.F. U.O.N.

- HOMERUN TO PANELBOARD; REFER TO PANEL SCHEDULES FOR ____ MINIMUM WIRE AND CONDUIT SIZES

MISCELLANEOUS

REFERENCE TO DRAWING NOTE

ITEMS SHOWN DASHED/HEAVY ARE TO BE REMOVED

ITEMS SHOWN SOLID/LIGHT ARE EXISTING TO REMAIN

ABBREVIATIONS:

ABOVE FINISHED FLOOR

AMPERE INTERRUPTING CAPACITY

AMERICAN WIRE GAUGE

EXHAUST FAN

ΕX EXISTING

GROUND

HAND-OFF-AUTOMATIC H.O.A.

HORSEPOWER

KVA KILOVOLT-AMPERES

MCA MINIMUM CIRCUIT AMPERES

MCB

MTD MOUNTED

NEC NATIONAL ELECTRICAL CODE

NEMA NATIONAL ELECTRICAL

NONFUSED SAFETY SWITCH NUMBER

POLE, POLES

PHASE

TYP TYPICAL VOLT, VOLTS

WEATHERPROOF

100 A MCB 100% RATED NEUTRAL BUS BREAKER CIRCUIT WIRING BREAKER CIRCUIT WIRING P AMPS NO SIZE GND C P AMPS NO SIZE GND C DESCRIPTION DESCRIPTION 1 PIT SUMP PUMP 1 20 EX. CONDUIT & WIRING 2 CHEM FEED PUMPS 1 20 EX CONDUIT & WRING 1 20 EX. CONDUIT & WRING 4 RECPT TREATMENT EX CONDUIT & WRING 1 20 5 UNIT HEATERS 1 20 EX. CONDUIT & WRING 6 EXHAUST FAN 1 20 EX CONDUIT & WRING 7 CLOSET LIGHTS 1 15 EX. CONDUIT & WRING EX CONDUIT & WIRING 8 EX CIRCUIT 1 20 1 20 EX. CONDUIT & WIRING 10 UV PANEL 2 50* 2 6 10 1 3 - 1 - V - - - I 1 -1 - | 14 SPACE 16 SPACE 11 - 1 1 -18 SPACE 1 -20 SPACE 22 SPACE 24 SPACE 26 SPACE 28 SPACE 11 -30 SPACE 32 SPACE 1 - 1 1 -34 SPACE 1 -1 -36 SPACE 1 -38 SPACE 1 -1 - 1 40 SPACE 1 -42 SPACE TOTAL CONNECTED LOAD 2.0 KVA KVA PER PHASE A 0.0 B 1.0 C 1.0

MOUNTING: SURFACE

LOCATION: FILTER & TANK ROOM

ARCHITECT



MEP ENGINEER

ALBAN ENGINEERING 303 INTERNATIONAL CIRCLE SUITE 450 HUNT VALLEY, MD 21030 410.842.6411

PROFESSIONAL CERTIFICATION. I CERTIFY THAT THESE DOCUMENTS WERE PREPARED BY OR APPROVED BY ME AND THAT I AM A DULY LICENSED ARCHITECT UNDER THE LAWS OF THE STATE OF MARYLAND, LICENSE # 16066, EXPIRATION DATE 01/06/20.

PROFESSIONAL SEAL:

PRINTS ISSUED

DATE DESCRIPTION 50% CDs 11/1/18 12/5/18 95% CDs **BID SET** 12/19/18 ADDENDUM #1 1/24/19 ADDENDUM #2 | 2/13/19

PERMIT SET

| CONFORM. SET | 4/25/19

3/27/19

NORTH HARFORD MIDDLE SCHOOL **POOL REPAIRS**

PHASES 2 & 3

112 PYLESVILLE ROAD PYLESVILLE, MD 21132


HARFORD COUNTY PUBLIC

SCHOOLS

SHEET TITLE **ELECTRICAL** LEGEND, **CONVENTIONS, AND ABBREVIATIONS**


PROJECT NO. 17013.0100 **APR 25 2019**

AS NOTED

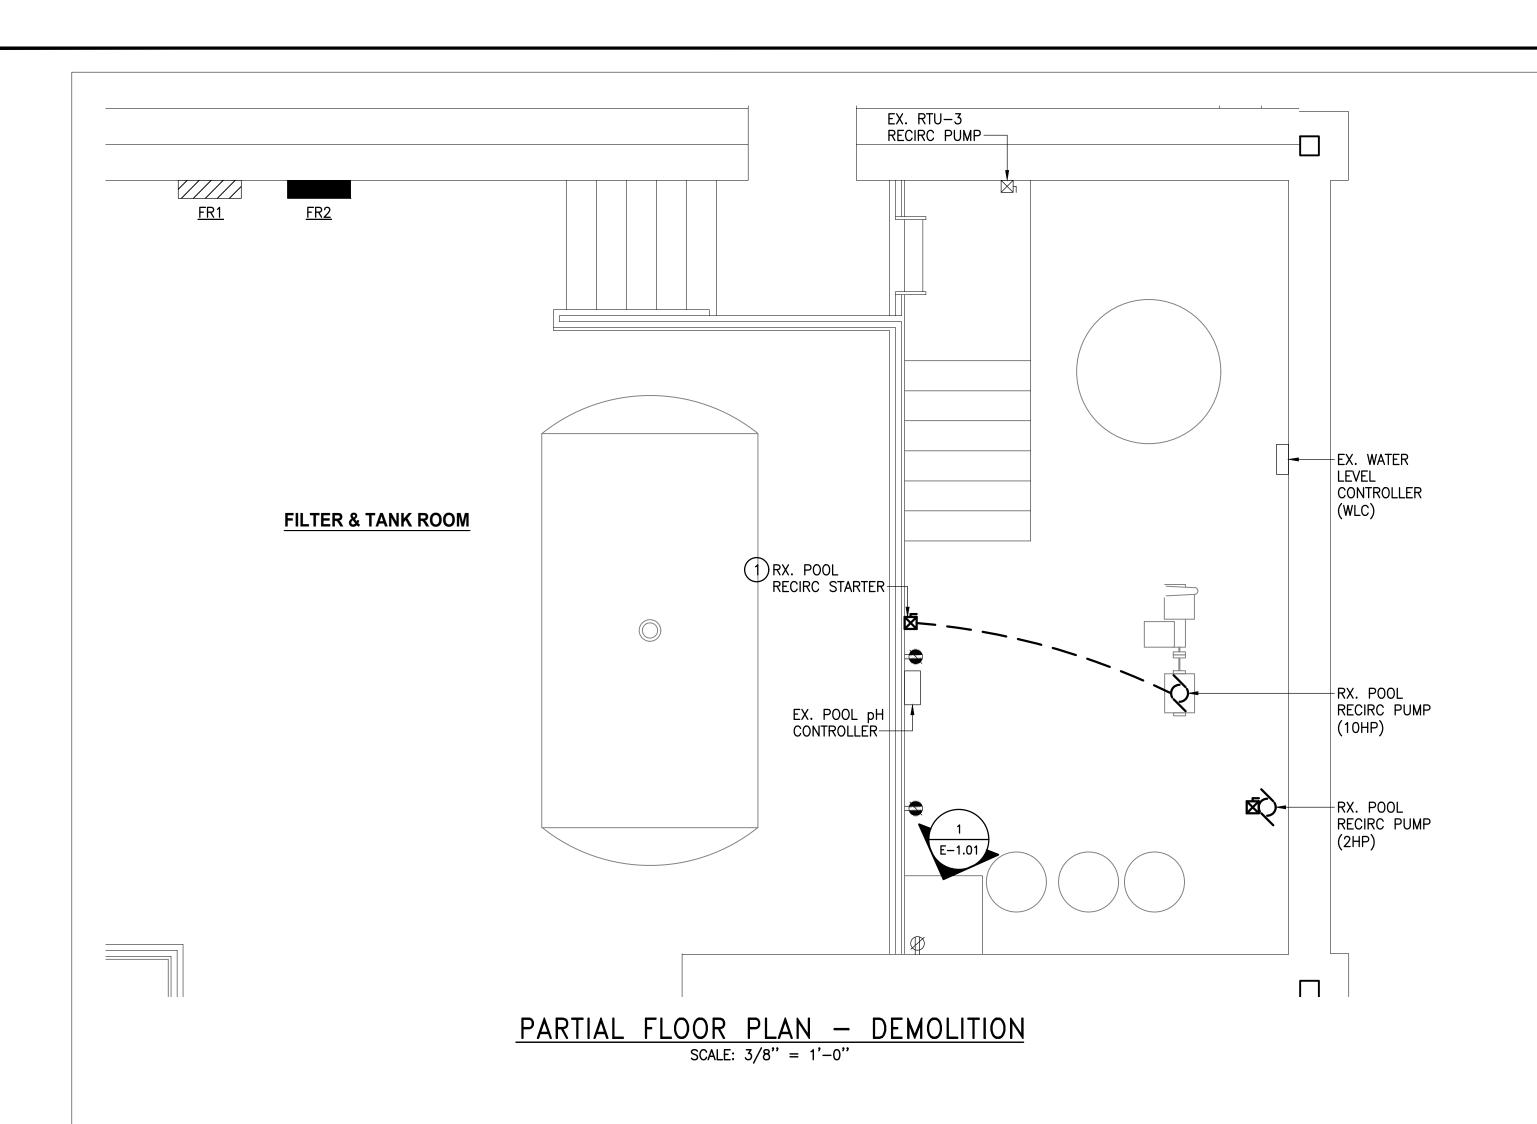

FILTER & TANK ROOM

2018 Repair

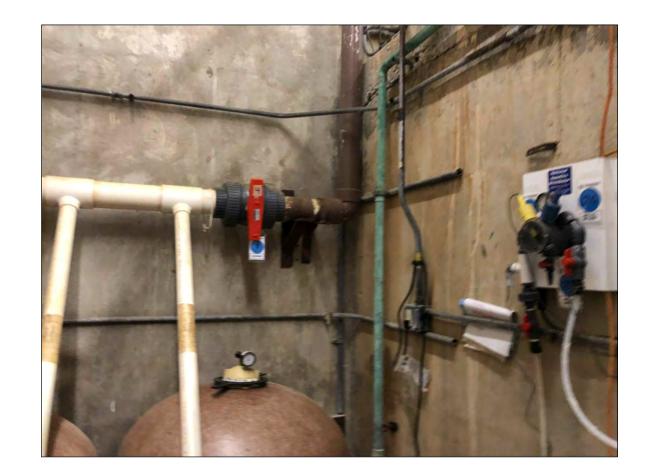

EXAMPLE OF ABANDONED PIPE TO BE DEMOLISHED

SCALE: NONE

- **GENERAL NOTES:**
- 1. ELECTRICAL CONTRACTOR SHALL REMOVE ABANDONED CONDUIT LOCATED IN PIT.
- COORDINATE LOCATIONS OF STARTERS/DISCONNECTS WITH INSTALLATION OF PIPING AND OTHER TRADES TO MAINTAIN NEC CLEARANCES.

DRAWING NOTES:

- MAINTAIN EXISTING CONNECTION TO DEMOLISHED STARTER. PROVIDE JUNCTION BOX AND EXTEND TO VSD, MATCH EXISTING WIRE SIZE. INSTALL VSD FURNISHED BY OTHERS.
- 2 NEMA SIZE O COMBINATION STARTER WITH 3P-30A-NF/SS AND HOA IN NEMA 4X STAINLESS STEEL ENCLOSURE.
- MAKE CONNECTION TO UV CONTROL PANEL WITH INTEGRAL DISCONNECT.
- 4 INSTALL INTERCONNECTING CABLES FURNISHED WITH UV SYSTEM, RACK ALONG WALL AND MAKE ALL CONNECTIONS.
- ELECTRICAL CONTRACTOR SHALL TRACE/DETECT PRESENCE OF ELECTRICAL CONDUIT EMBEDDED IN POOL DECK TO ASSIST IN IDENTIFYING EXISTING OBSTRUCTIONS IN DECK. DETECTION IS INCLUDED BUT IS NOT LIMITED TO THE USE OF X-RAY.

SCALE: 3/8" = 1'-0"

ARCHITECT



MEP ENGINEER

ALBAN ENGINEERING 303 INTERNATIONAL CIRCLE SUITE 450 HUNT VALLEY, MD 21030 410.842.6411

PROFESSIONAL CERTIFICATION.
I CERTIFY THAT THESE DOCUMENTS
WERE PREPARED BY OR APPROVED BY
ME AND THAT I AM A DULY LICENSED
ARCHITECT UNDER THE LAWS OF THE
STATE OF MARYLAND, LICENSE # 16066,
EXPIRATION DATE 01/06/20.

PROFESSIONAL SEAL:

	PRINTS ISSUED							
NO.	DESCRIPTION	DATE						
	50% CDs	11/1/18						
	95% CDs	12/5/18						
	BID SET	12/19/18						
<u> </u>	ADDENDUM #1	1/24/19						
<u>^</u>	ADDENDUM #2	2/13/19						
	PERMIT SET	3/27/19						

CONFORM. SET 4/25/19


NORTH HARFORD MIDDLE SCHOOL POOL REPAIRS PHASES 2 & 3

112 PYLESVILLE ROAD PYLESVILLE,MD 21132


HARFORD COUNTY PUBLIC SCHOOLS


SHEET TITLE

PROPOSED FLOOR PLAN - DEMO & POWER

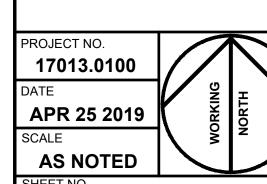

E-1.01

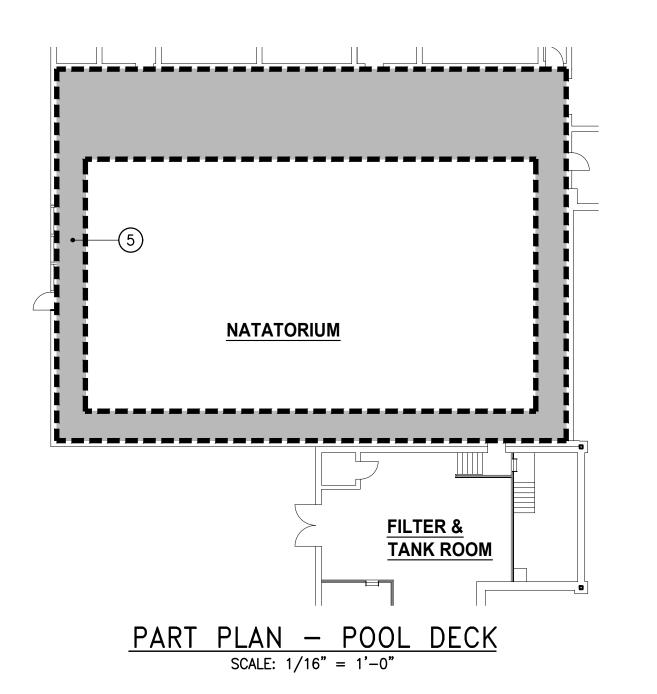

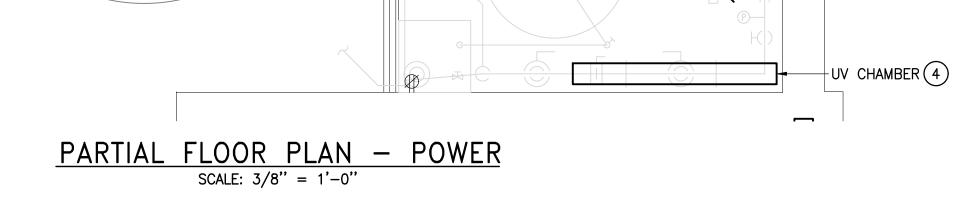


EX. WLC


POOL RECIRC PUMP (10HP)

EX. RTU-3 RECIRC PUMP-


4 UV PANEL-

EX. POOL pH CONTROLLER

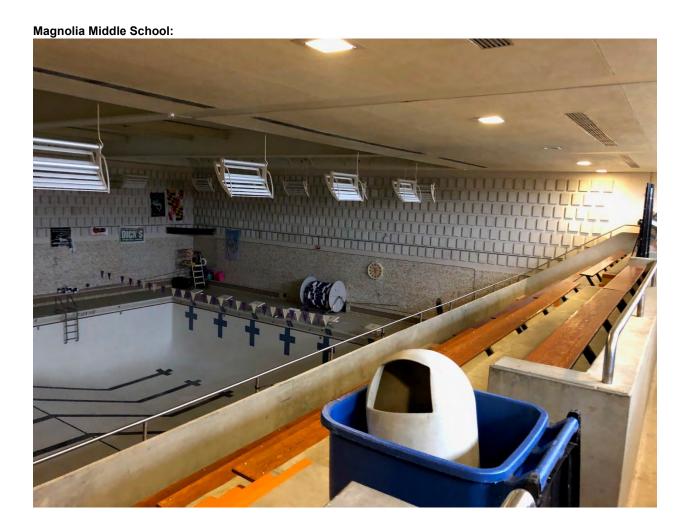


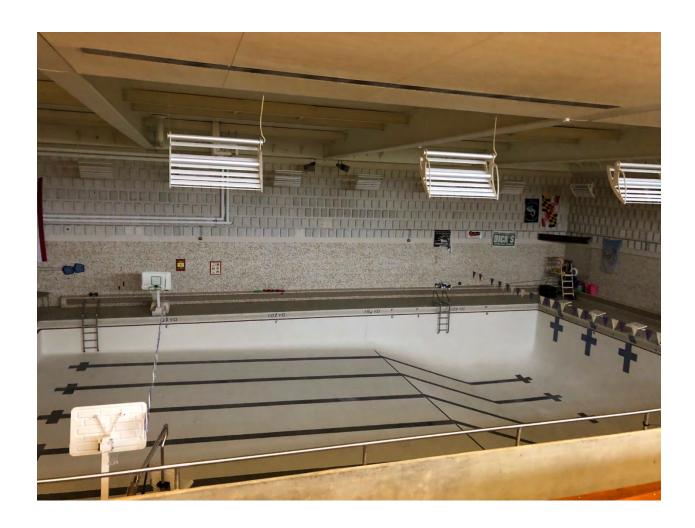





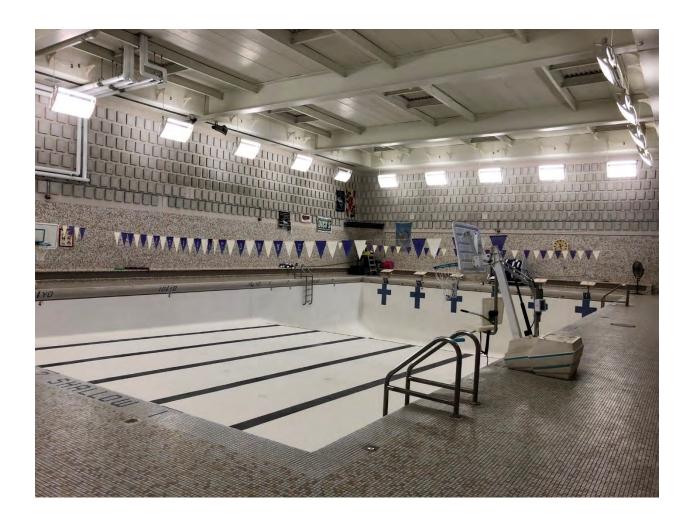



Drawings include Original and After 2013 Renovation

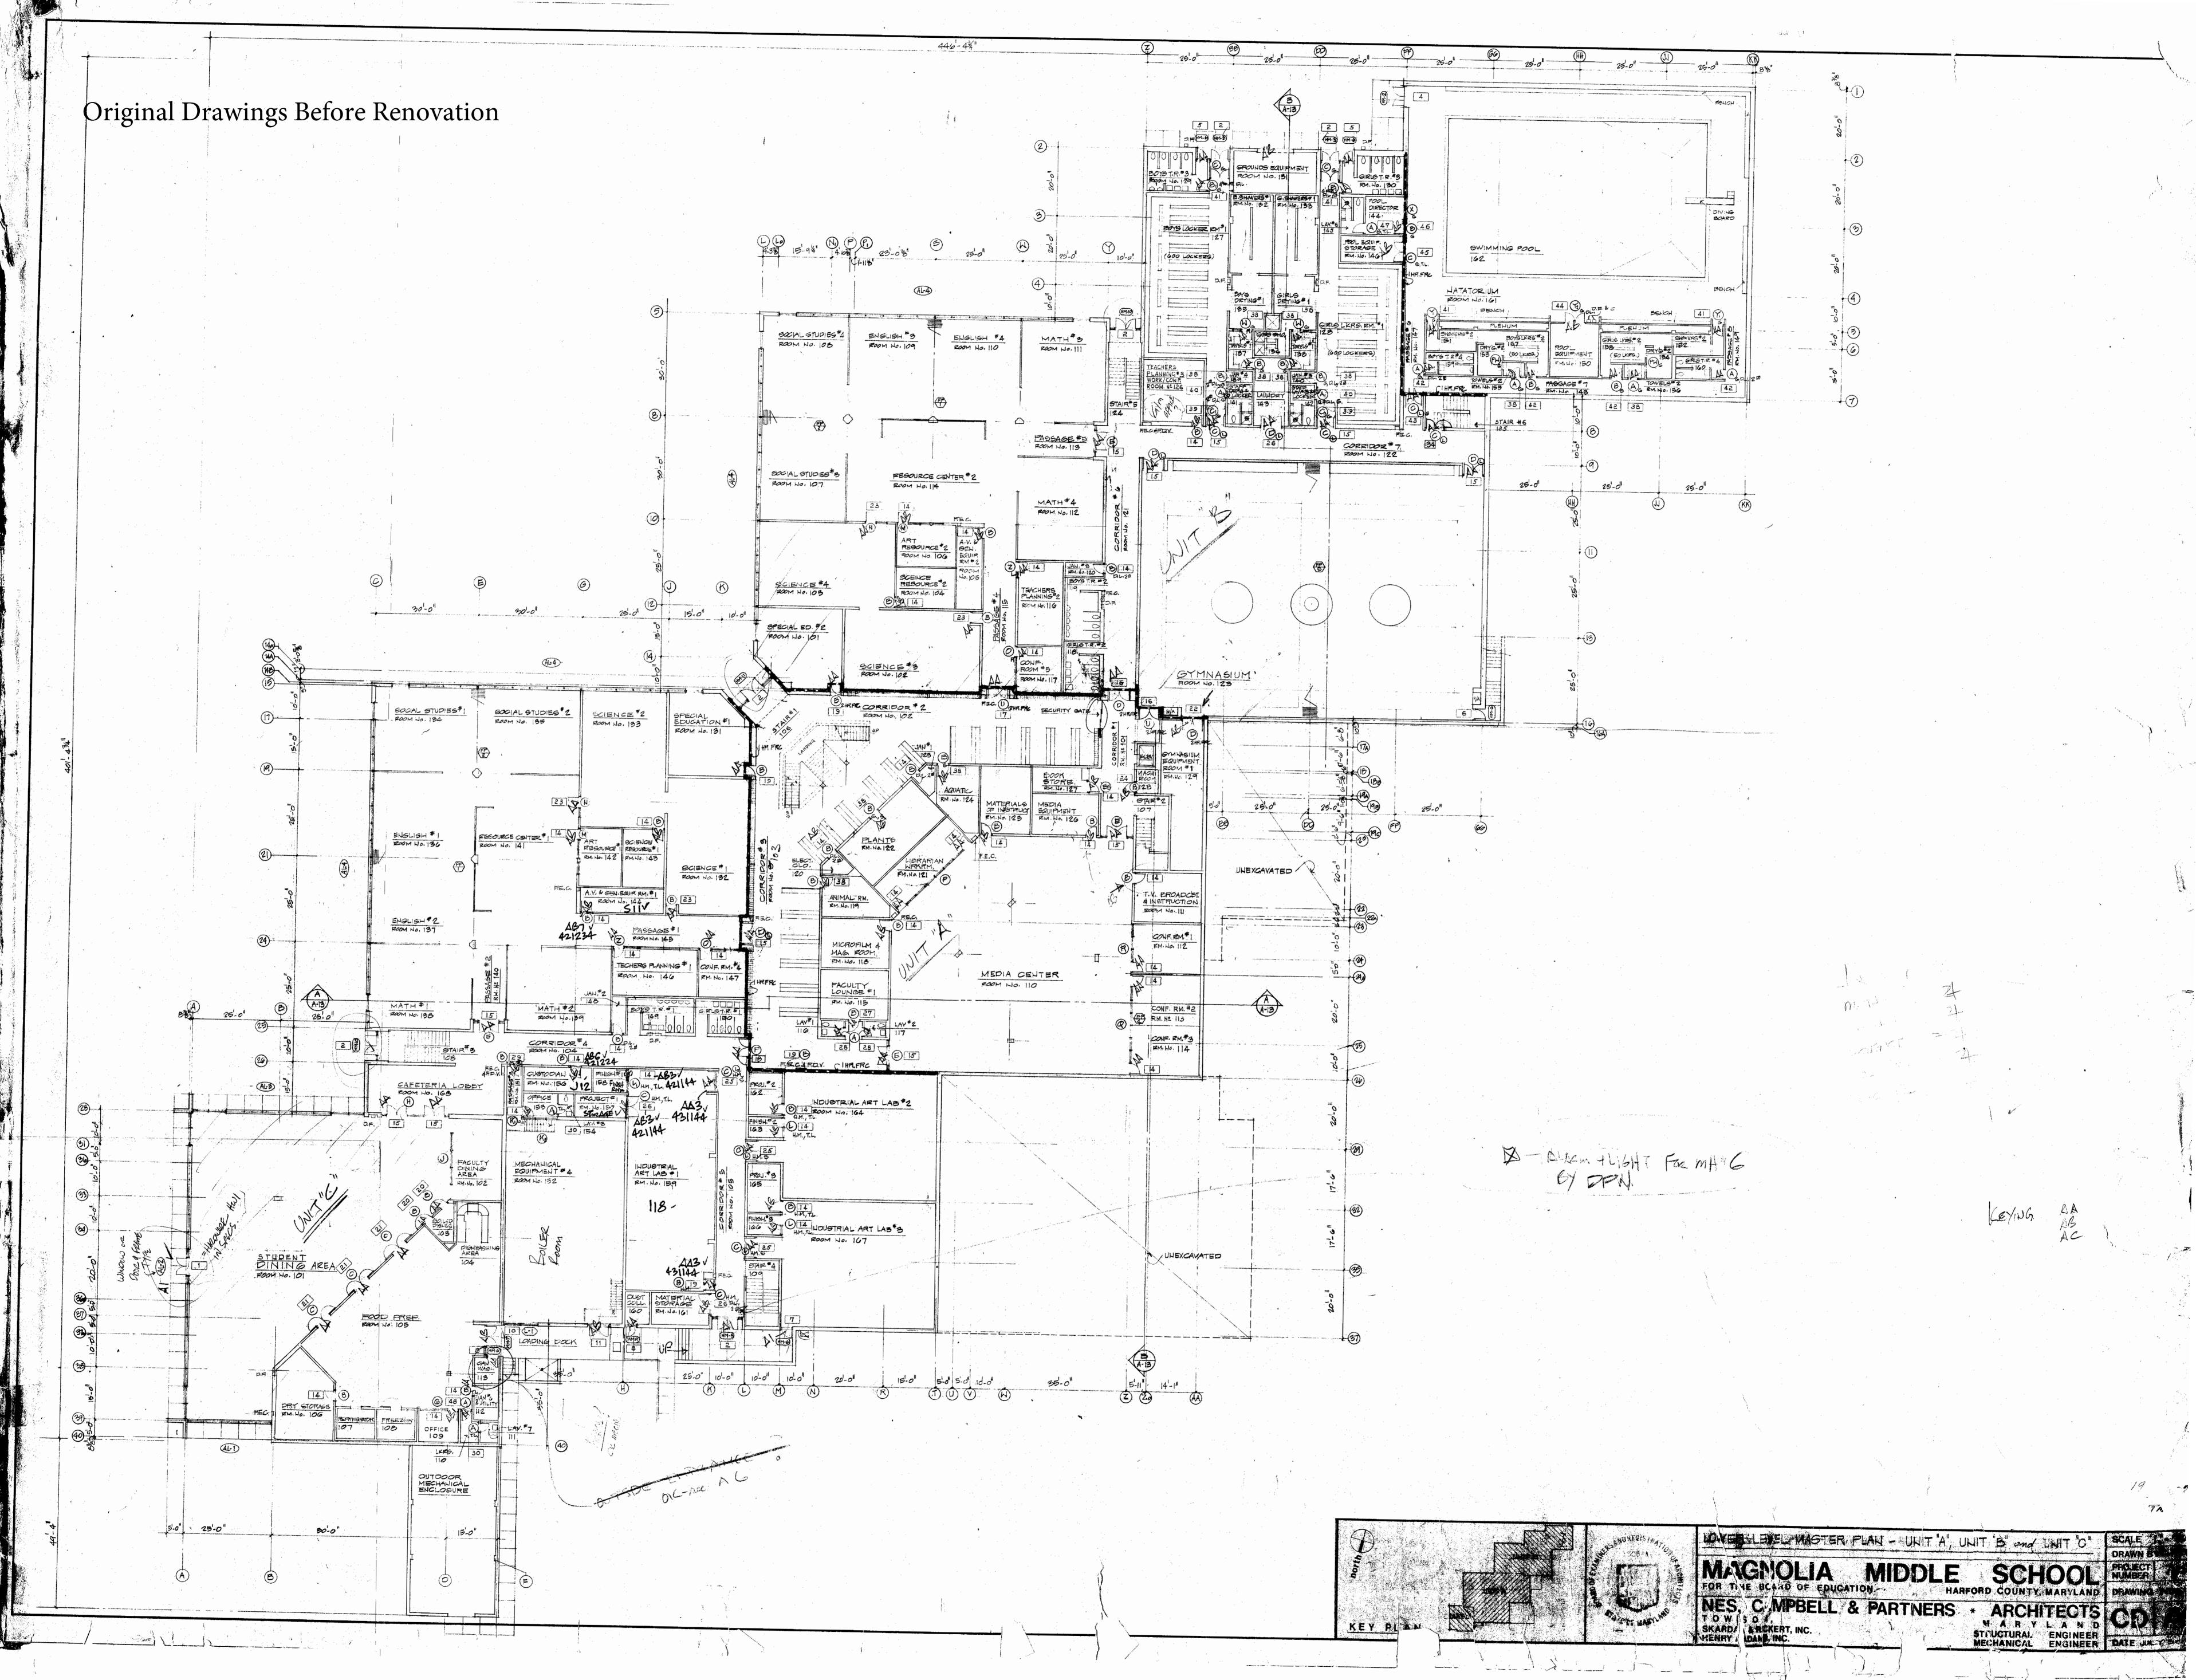


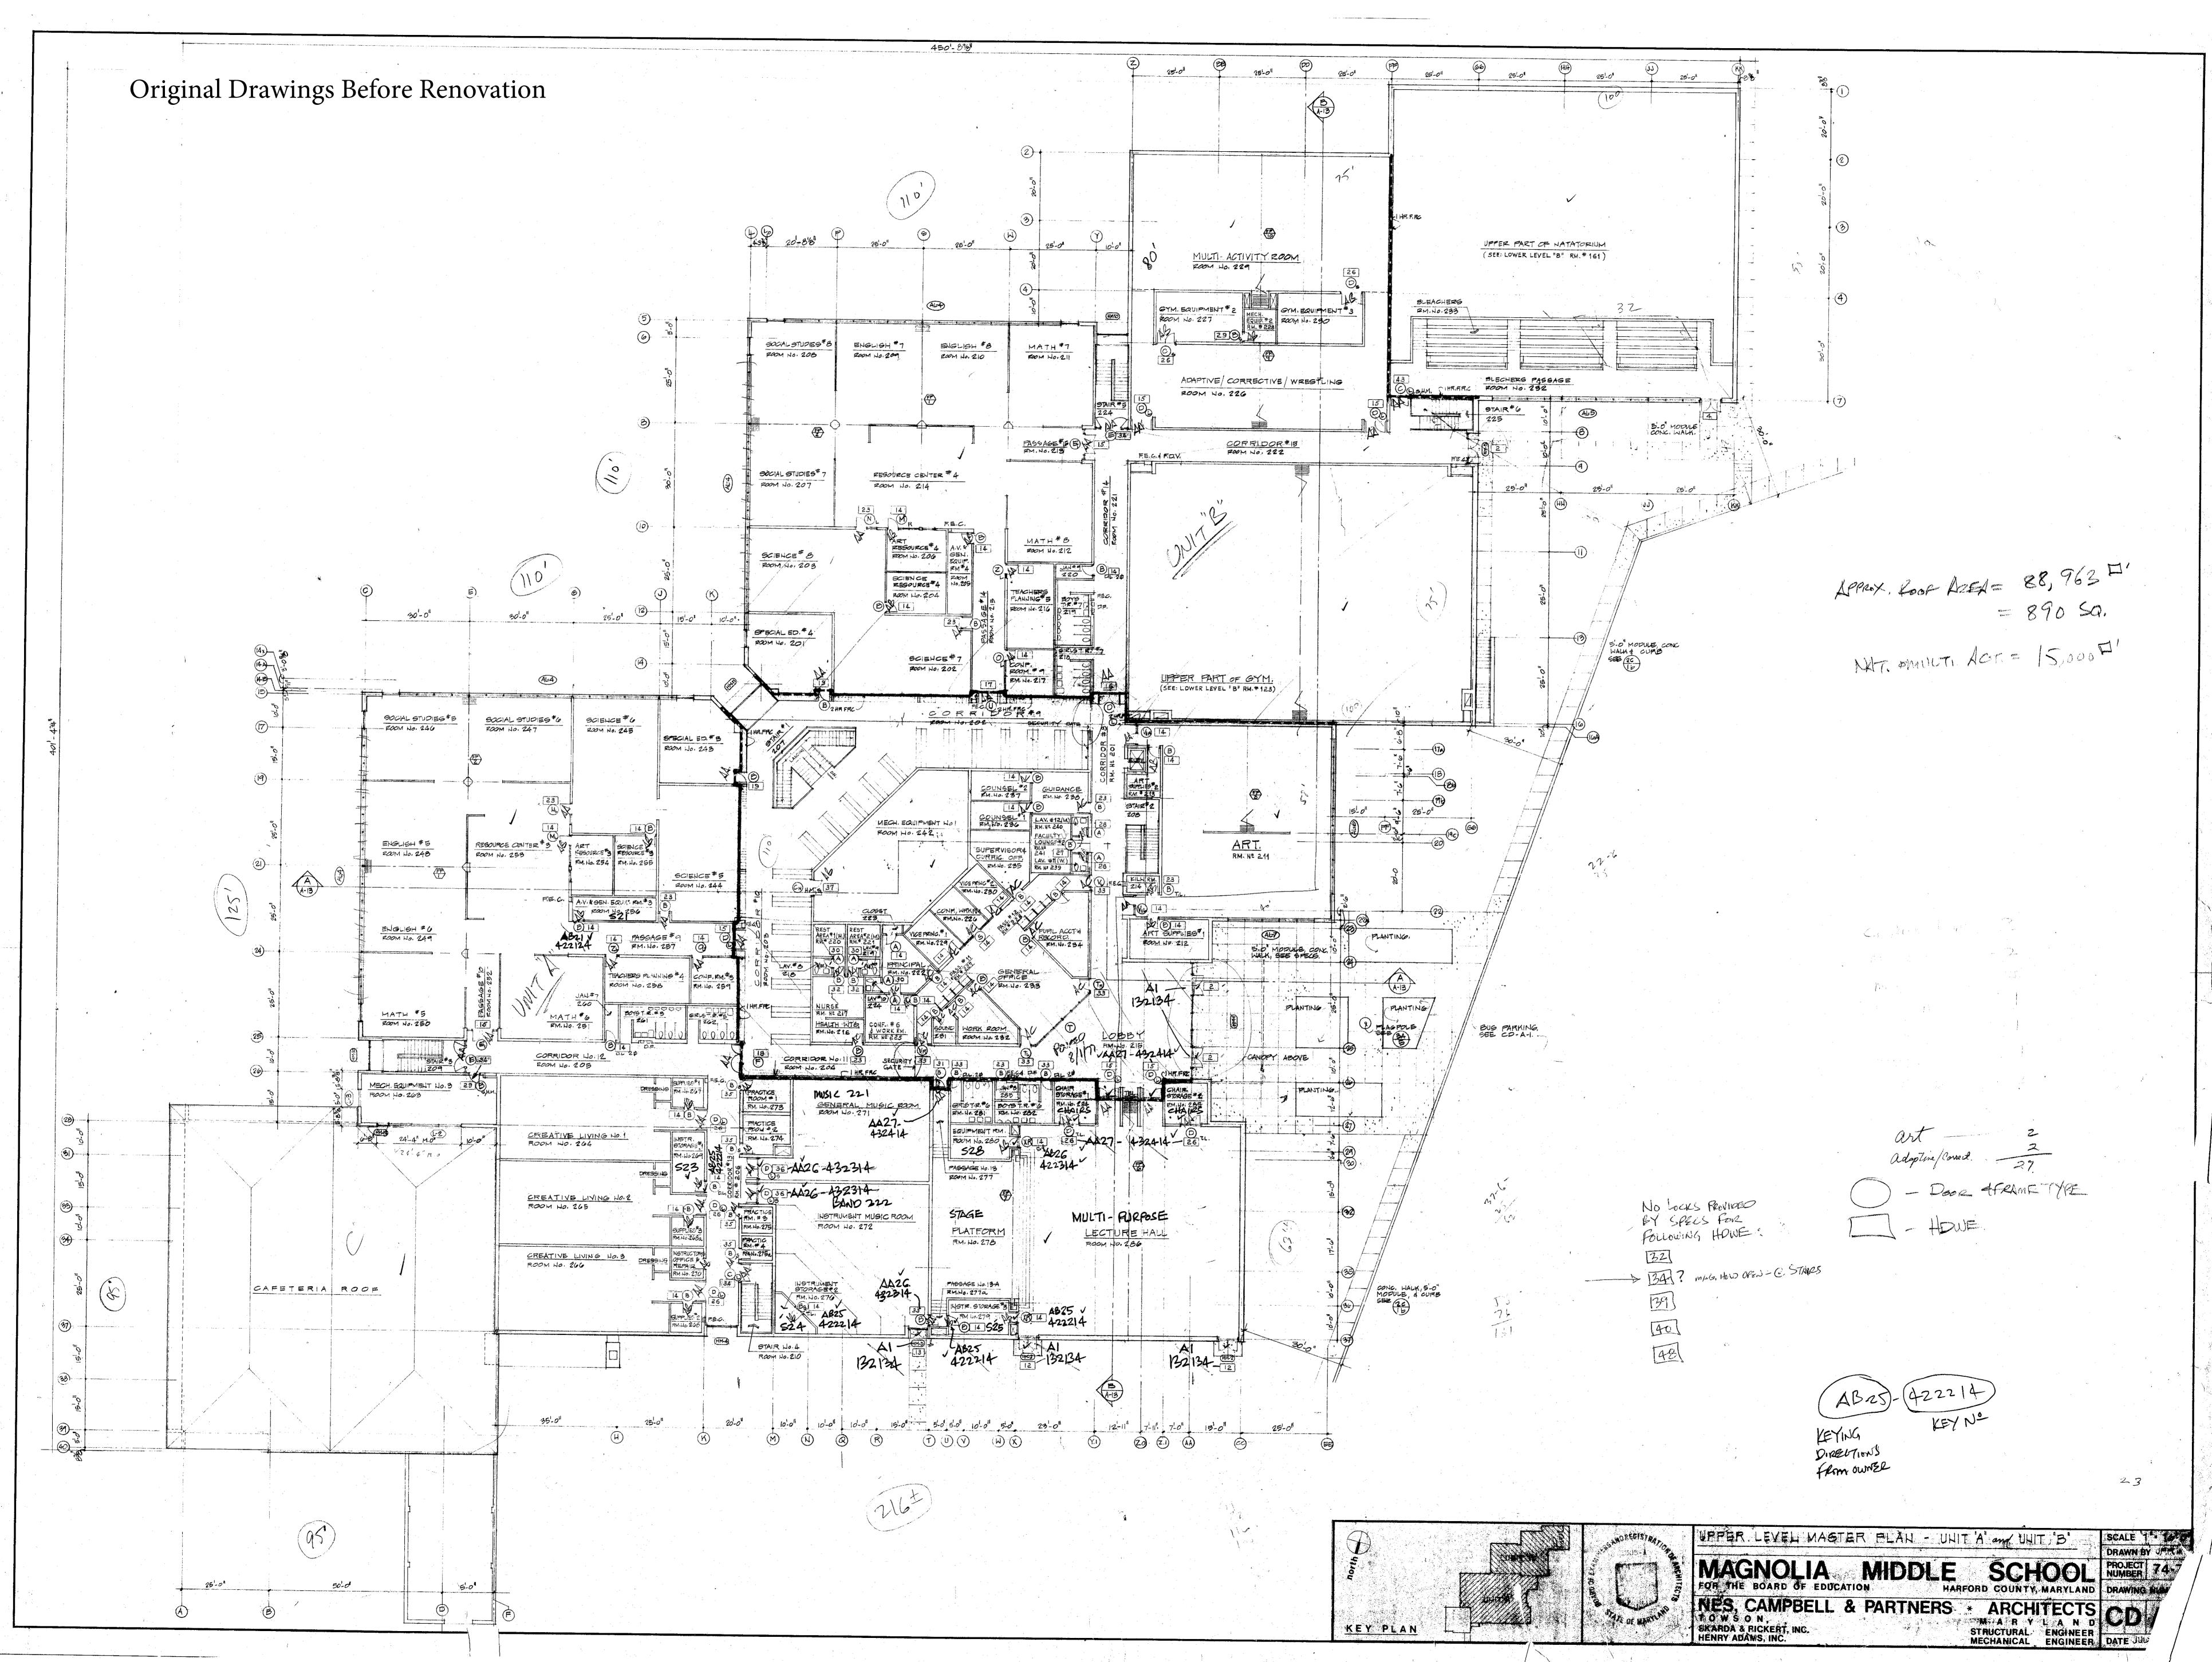


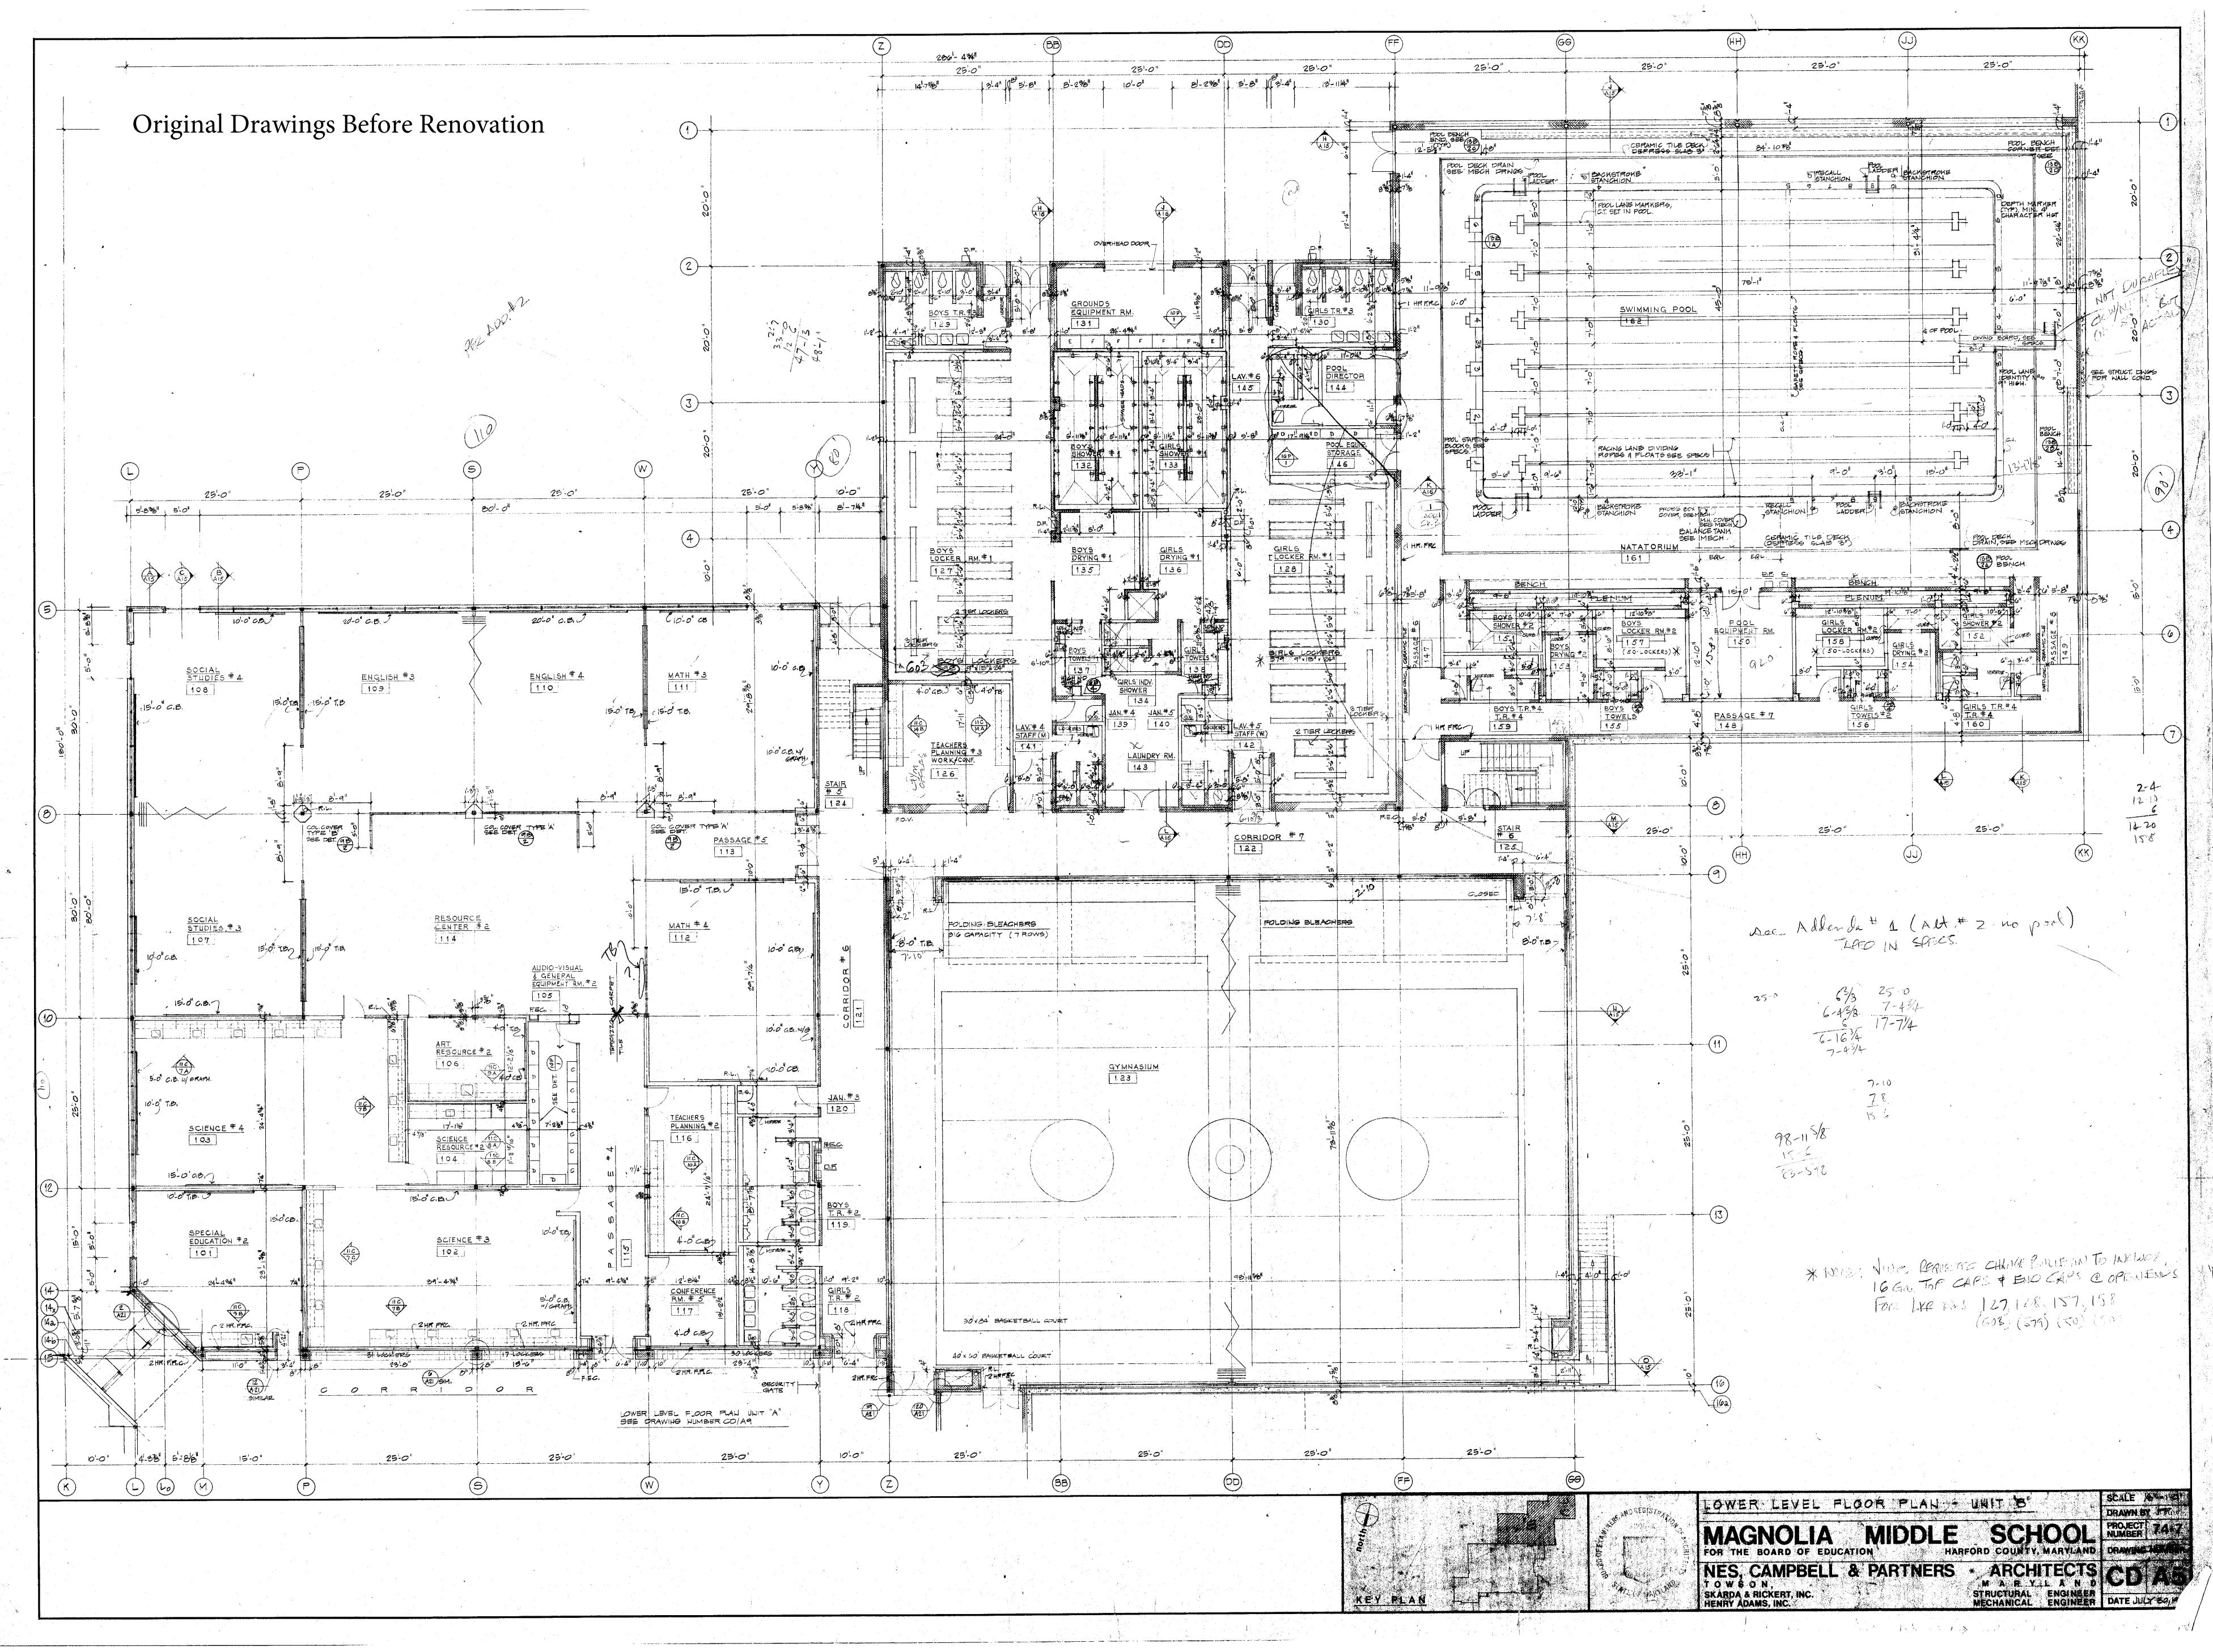


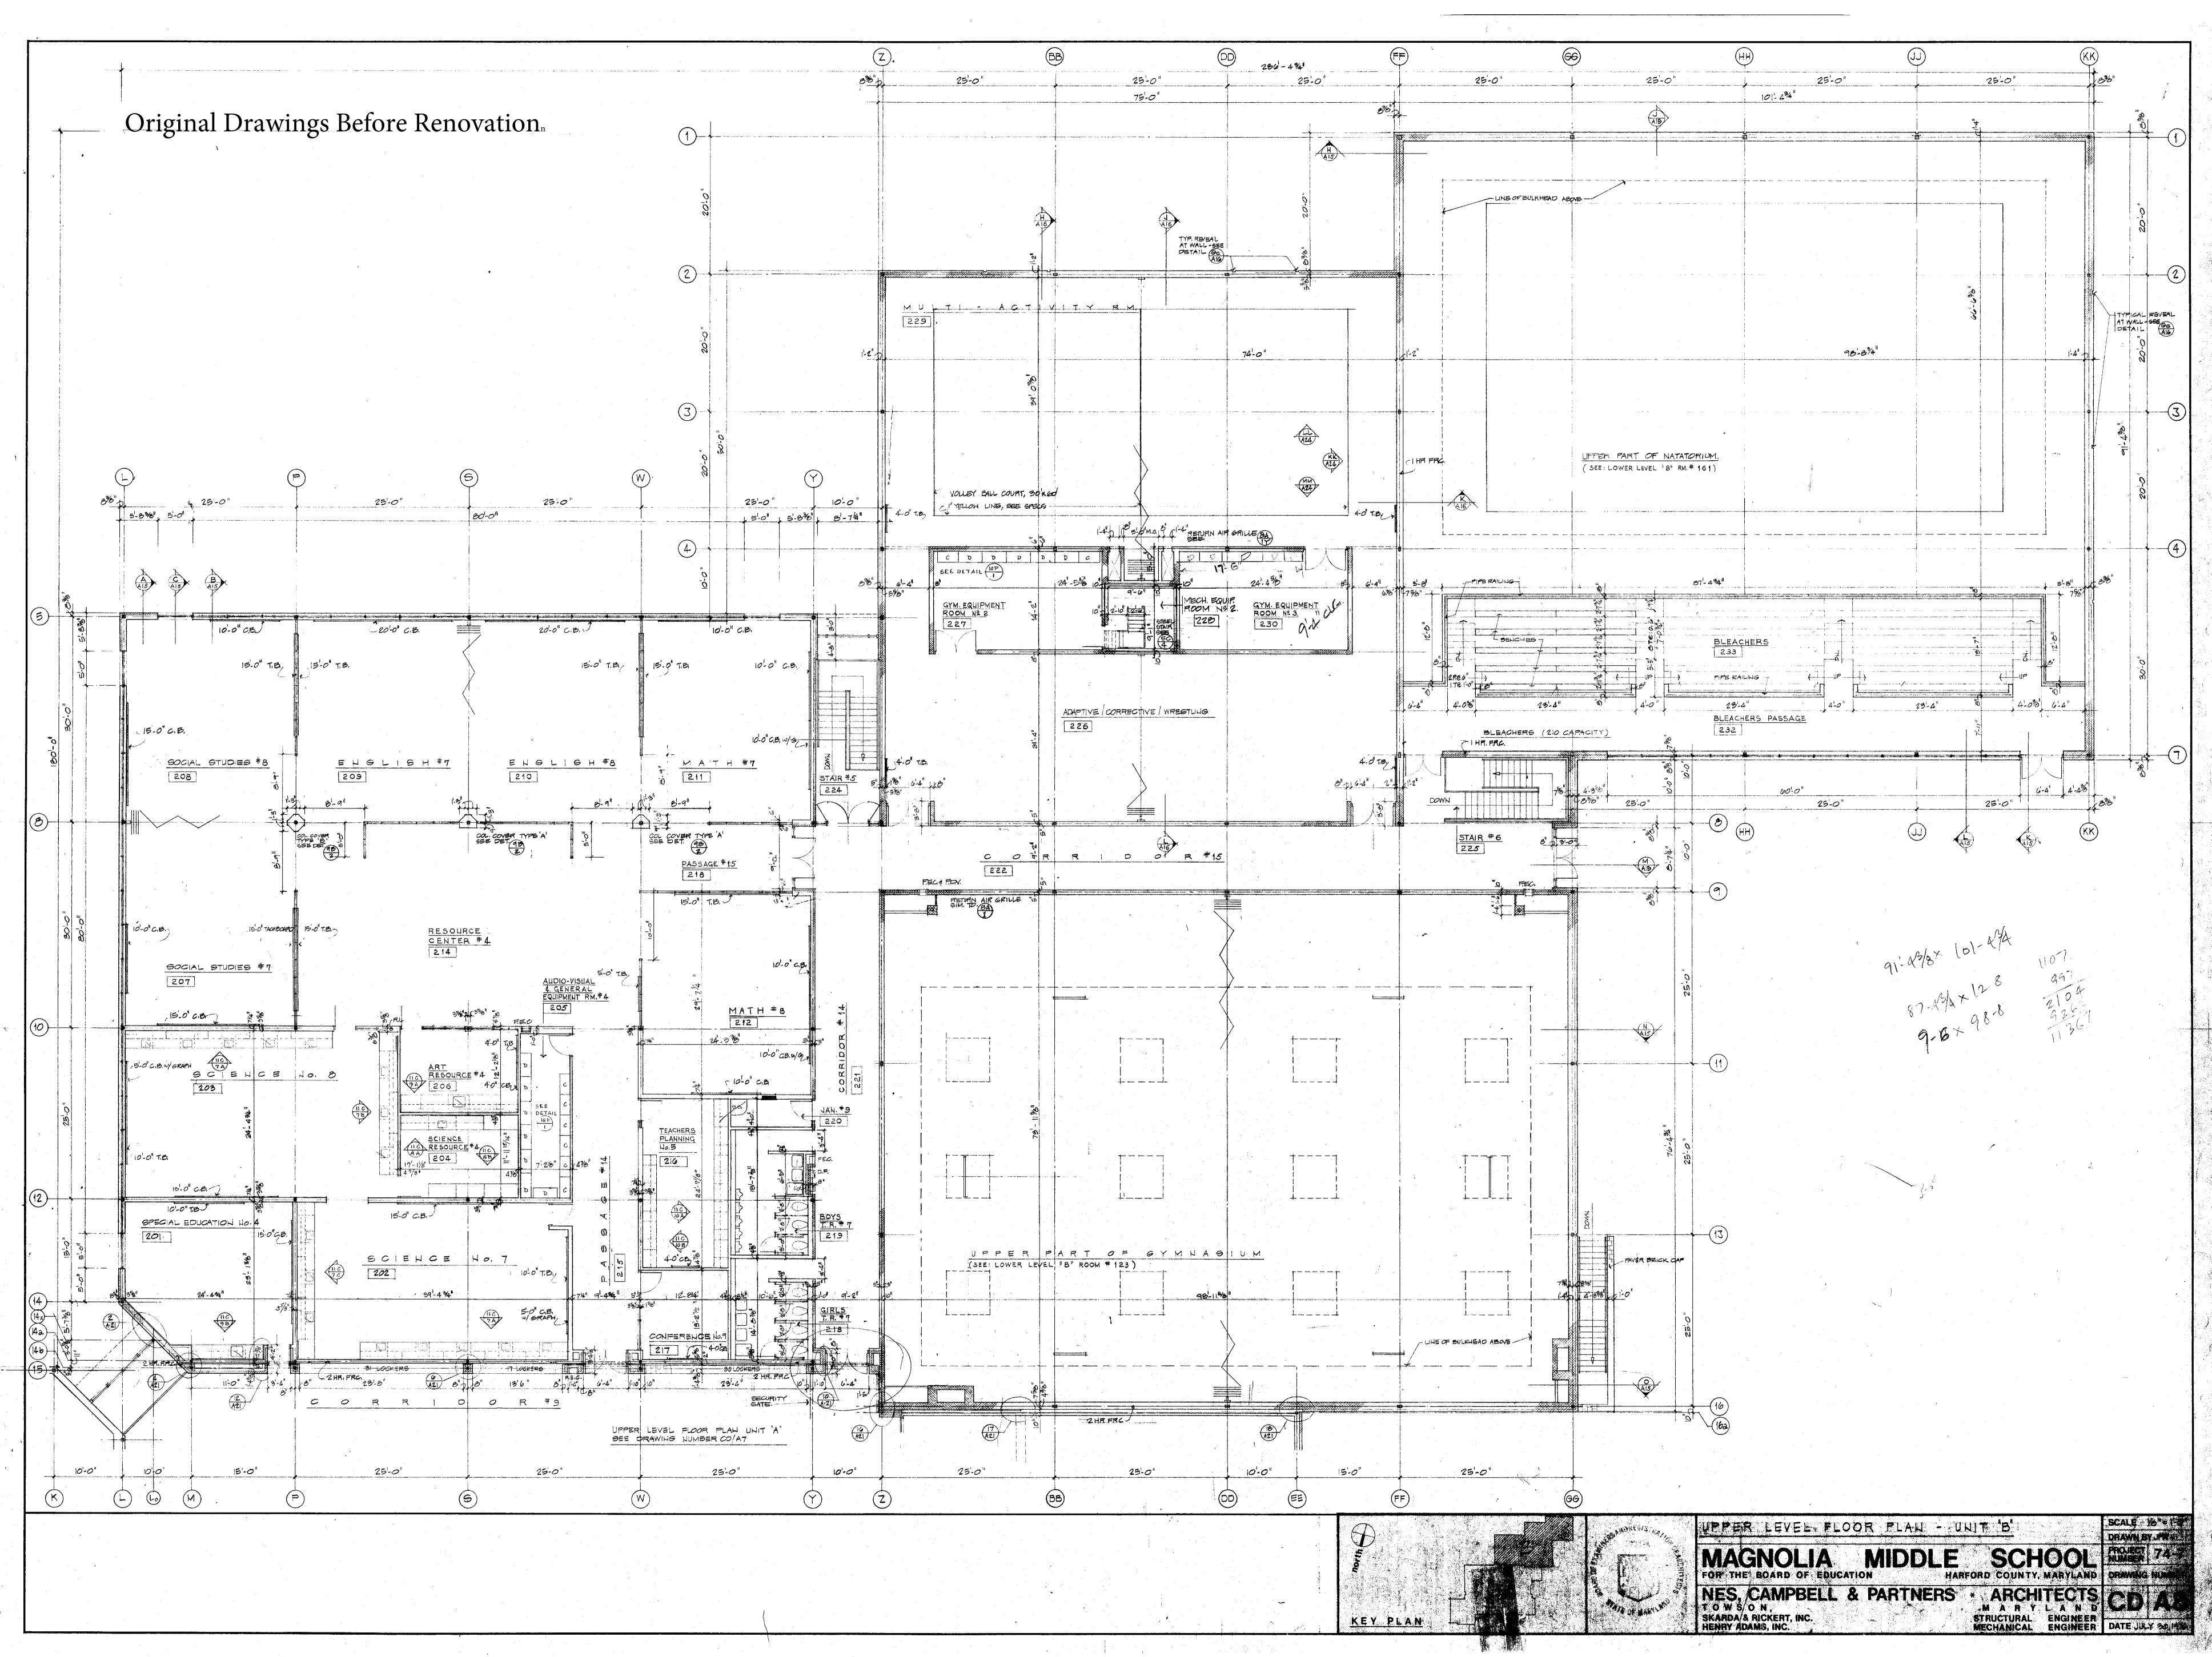


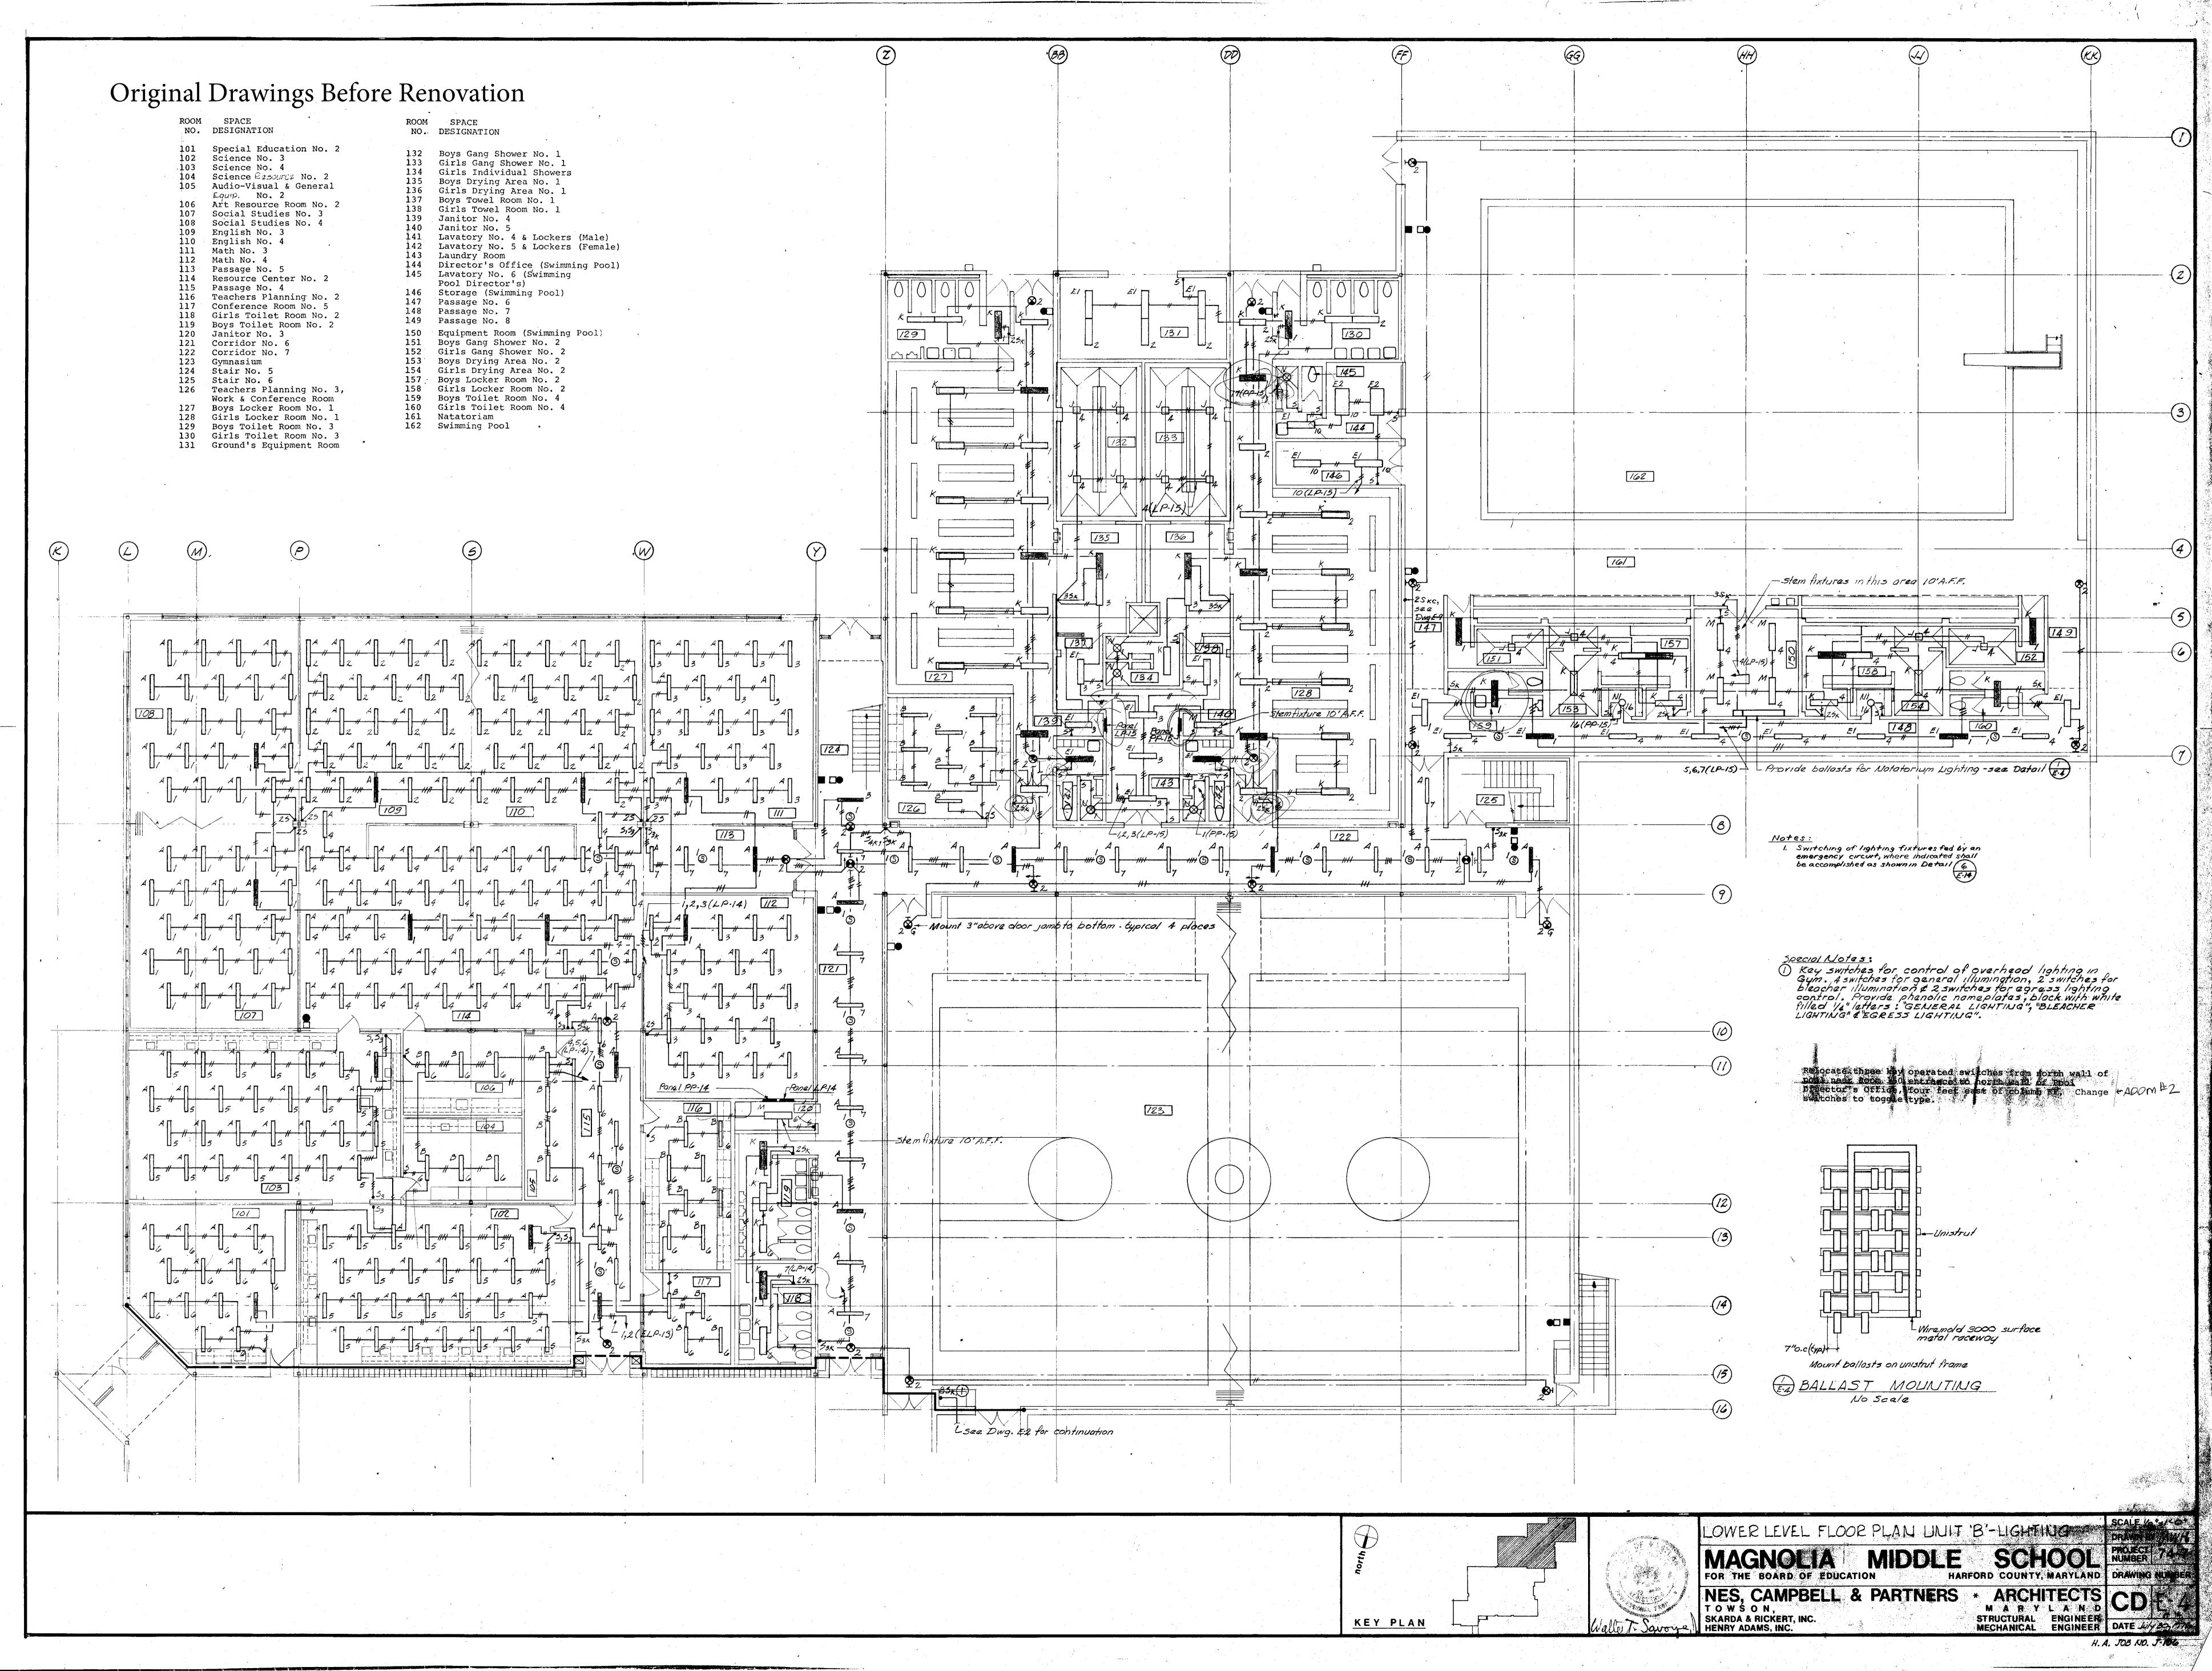

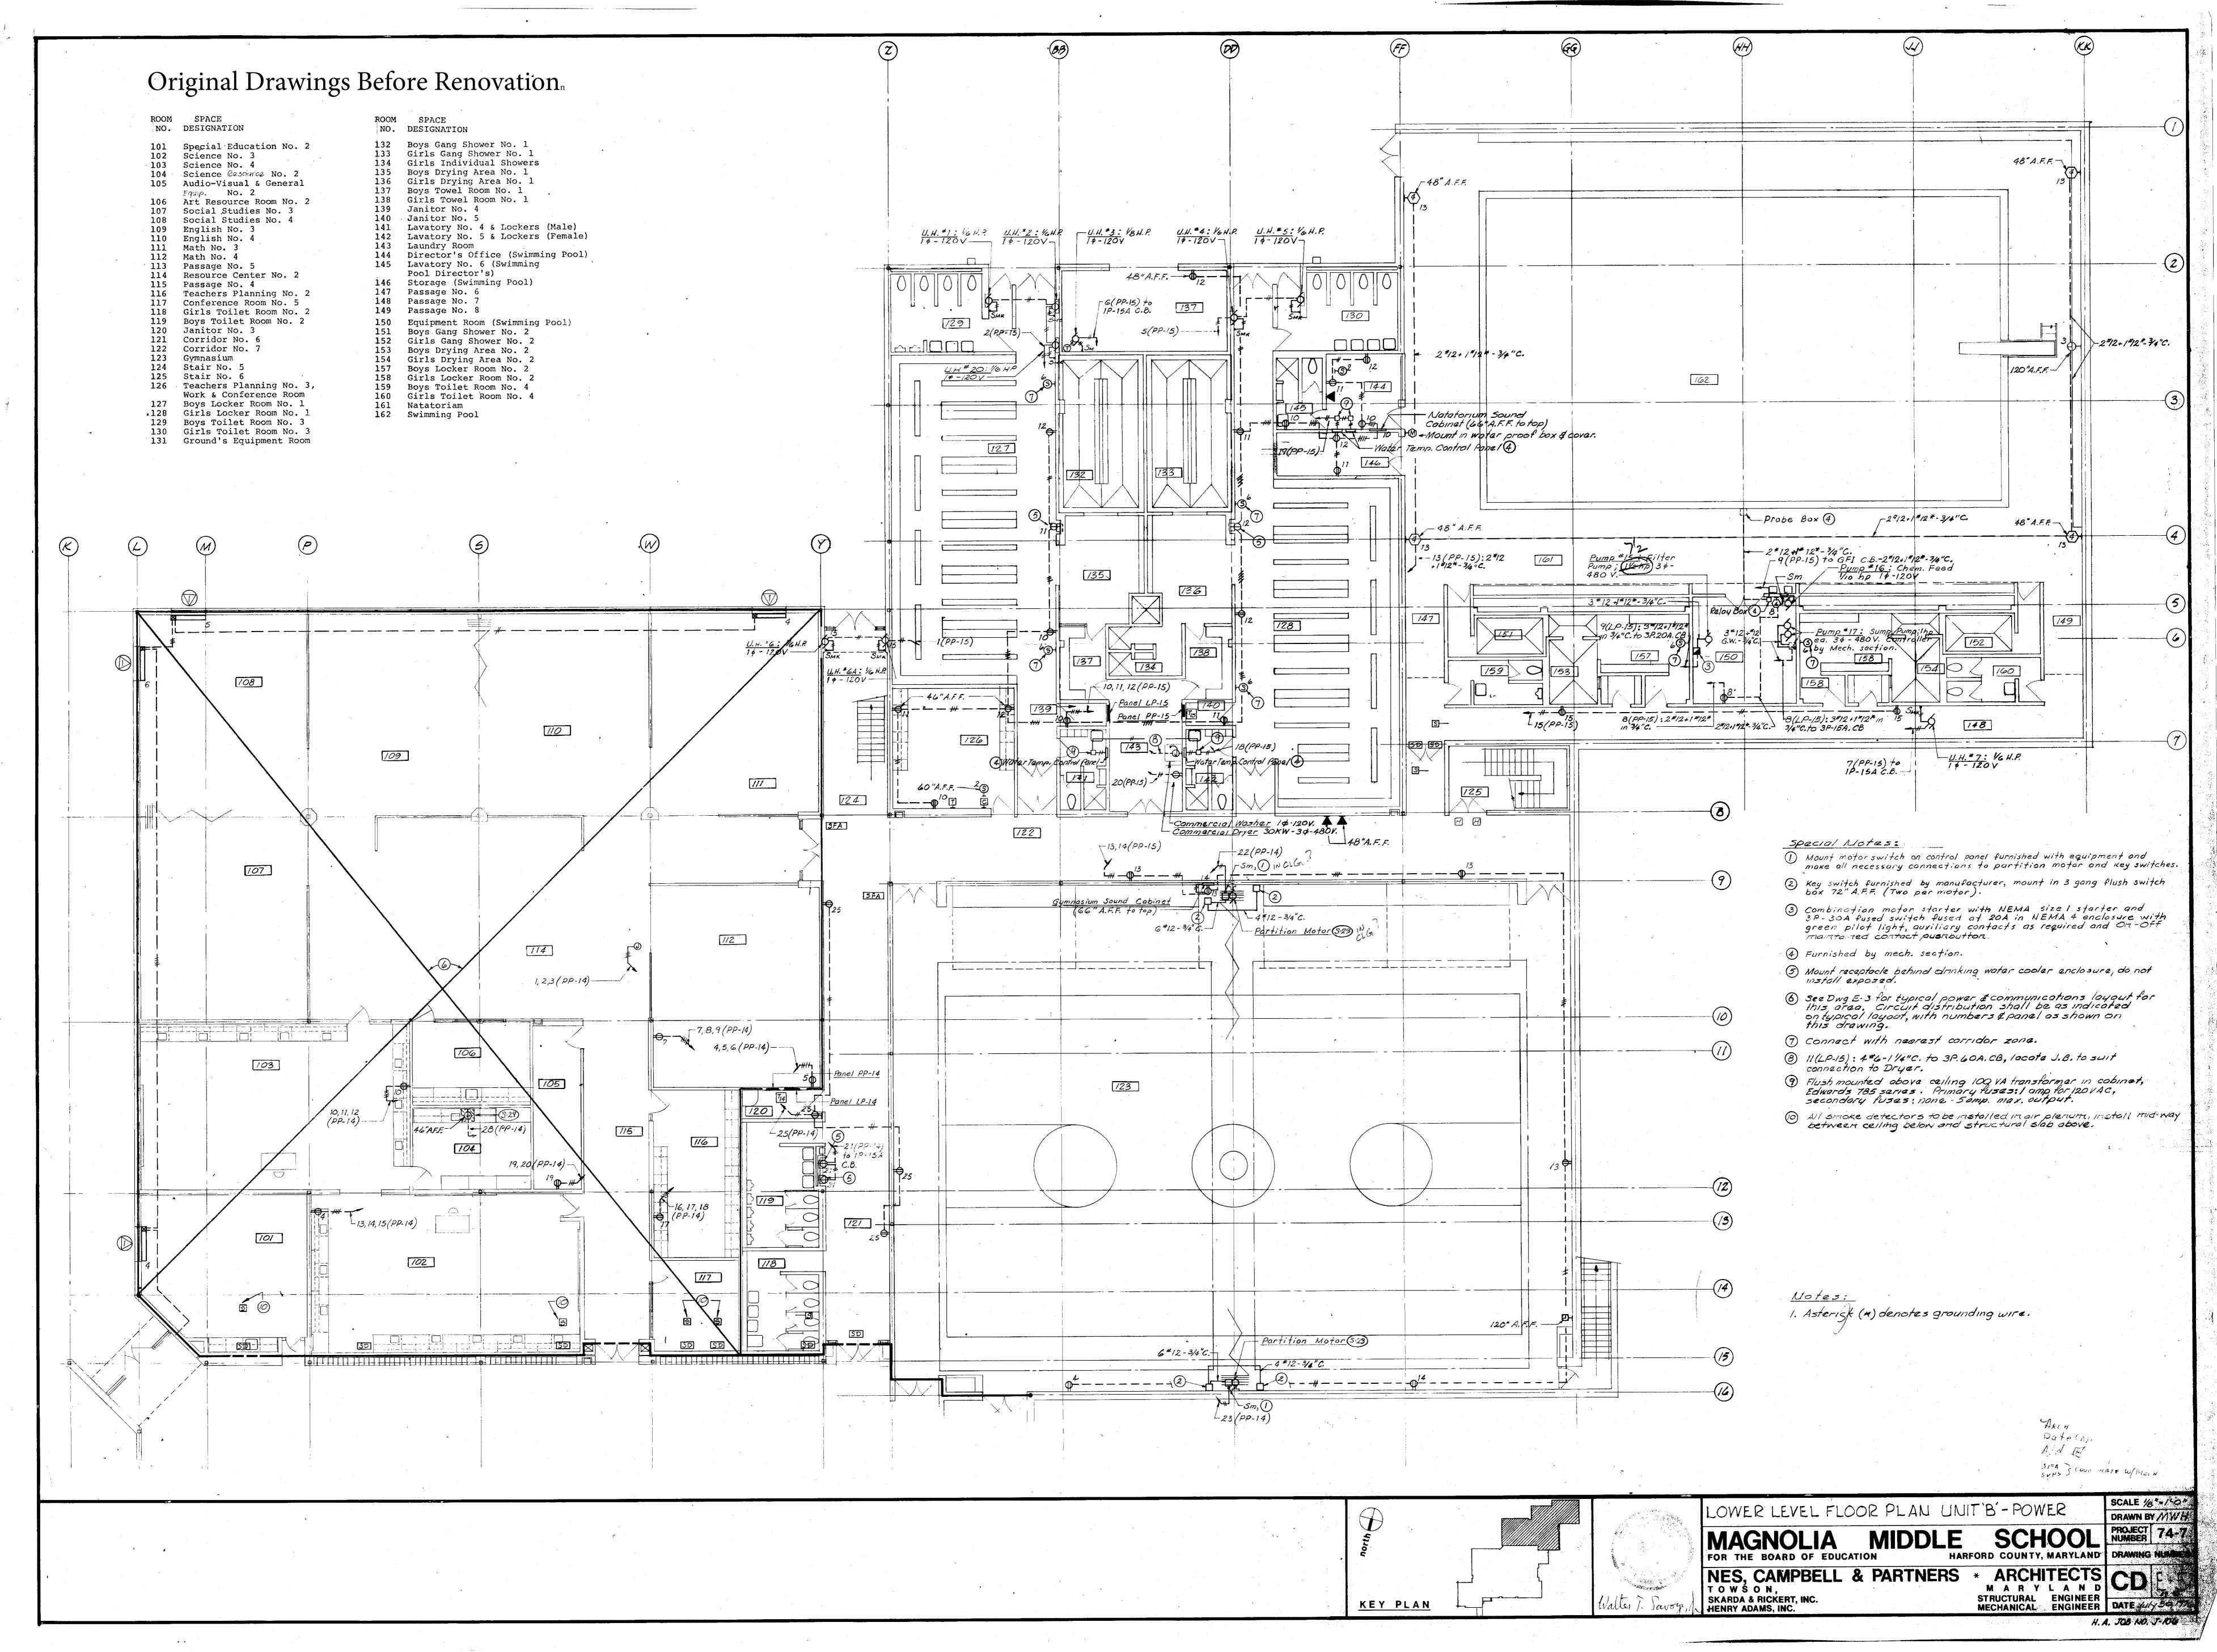


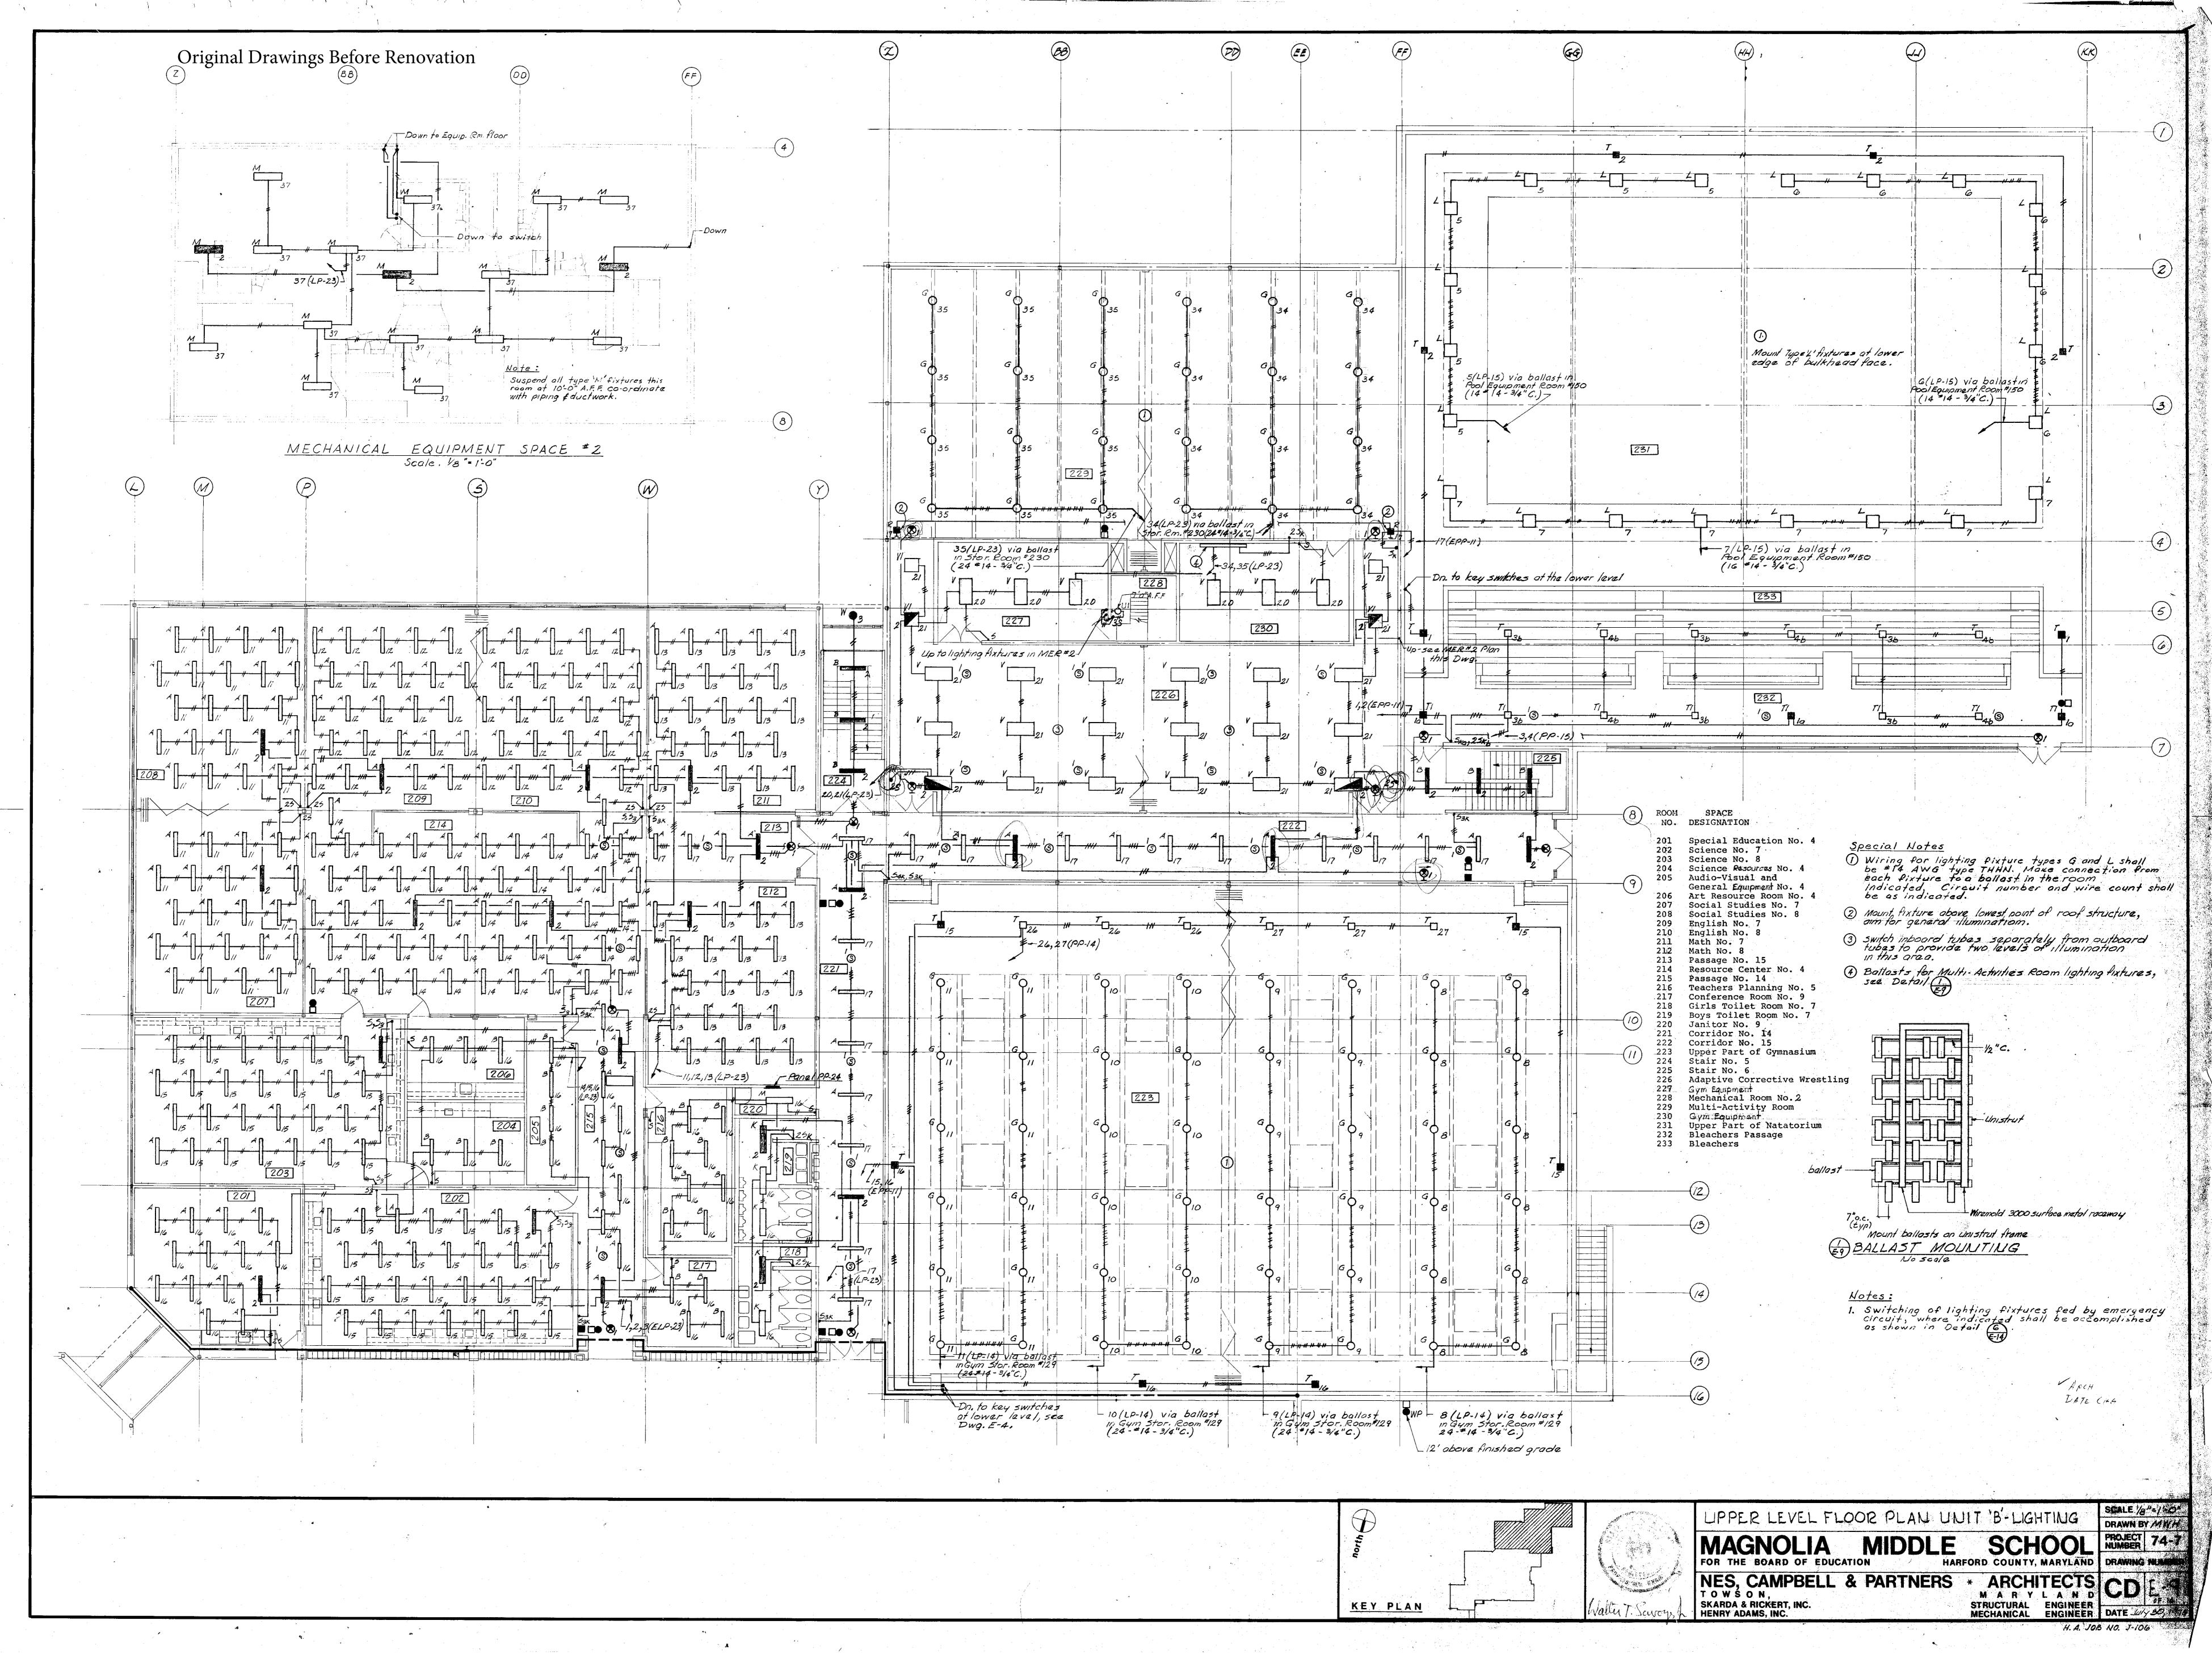

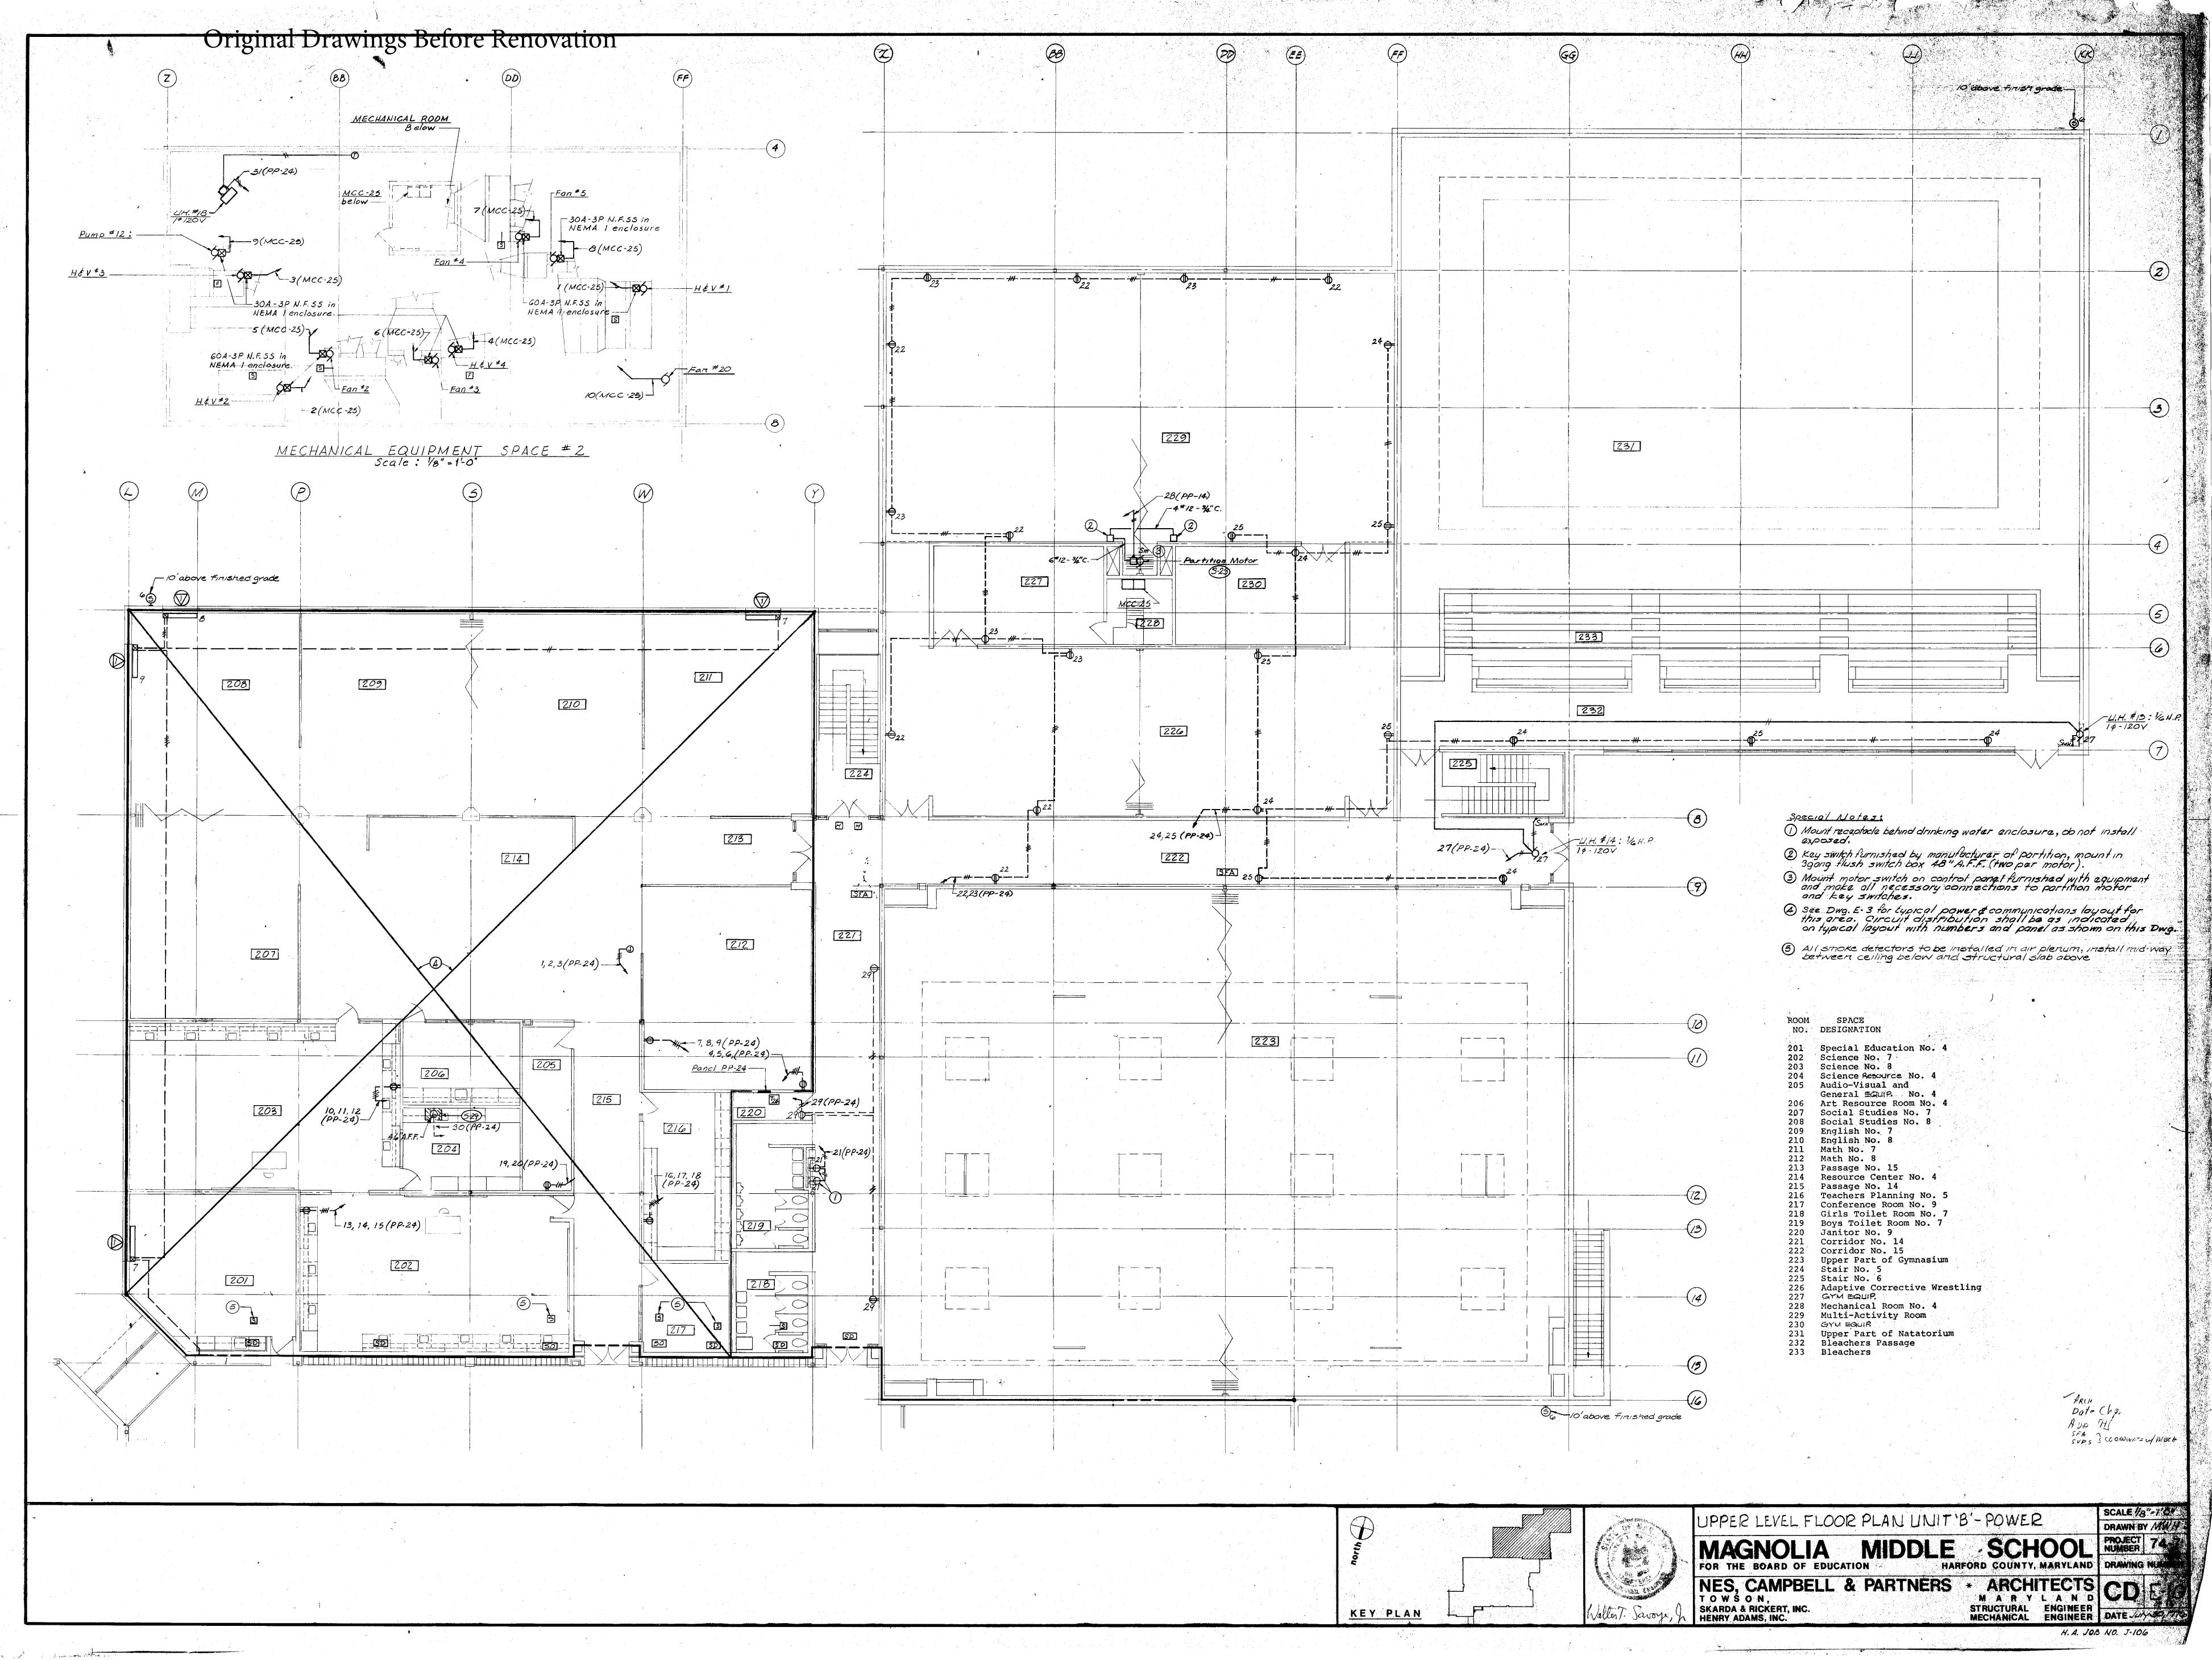

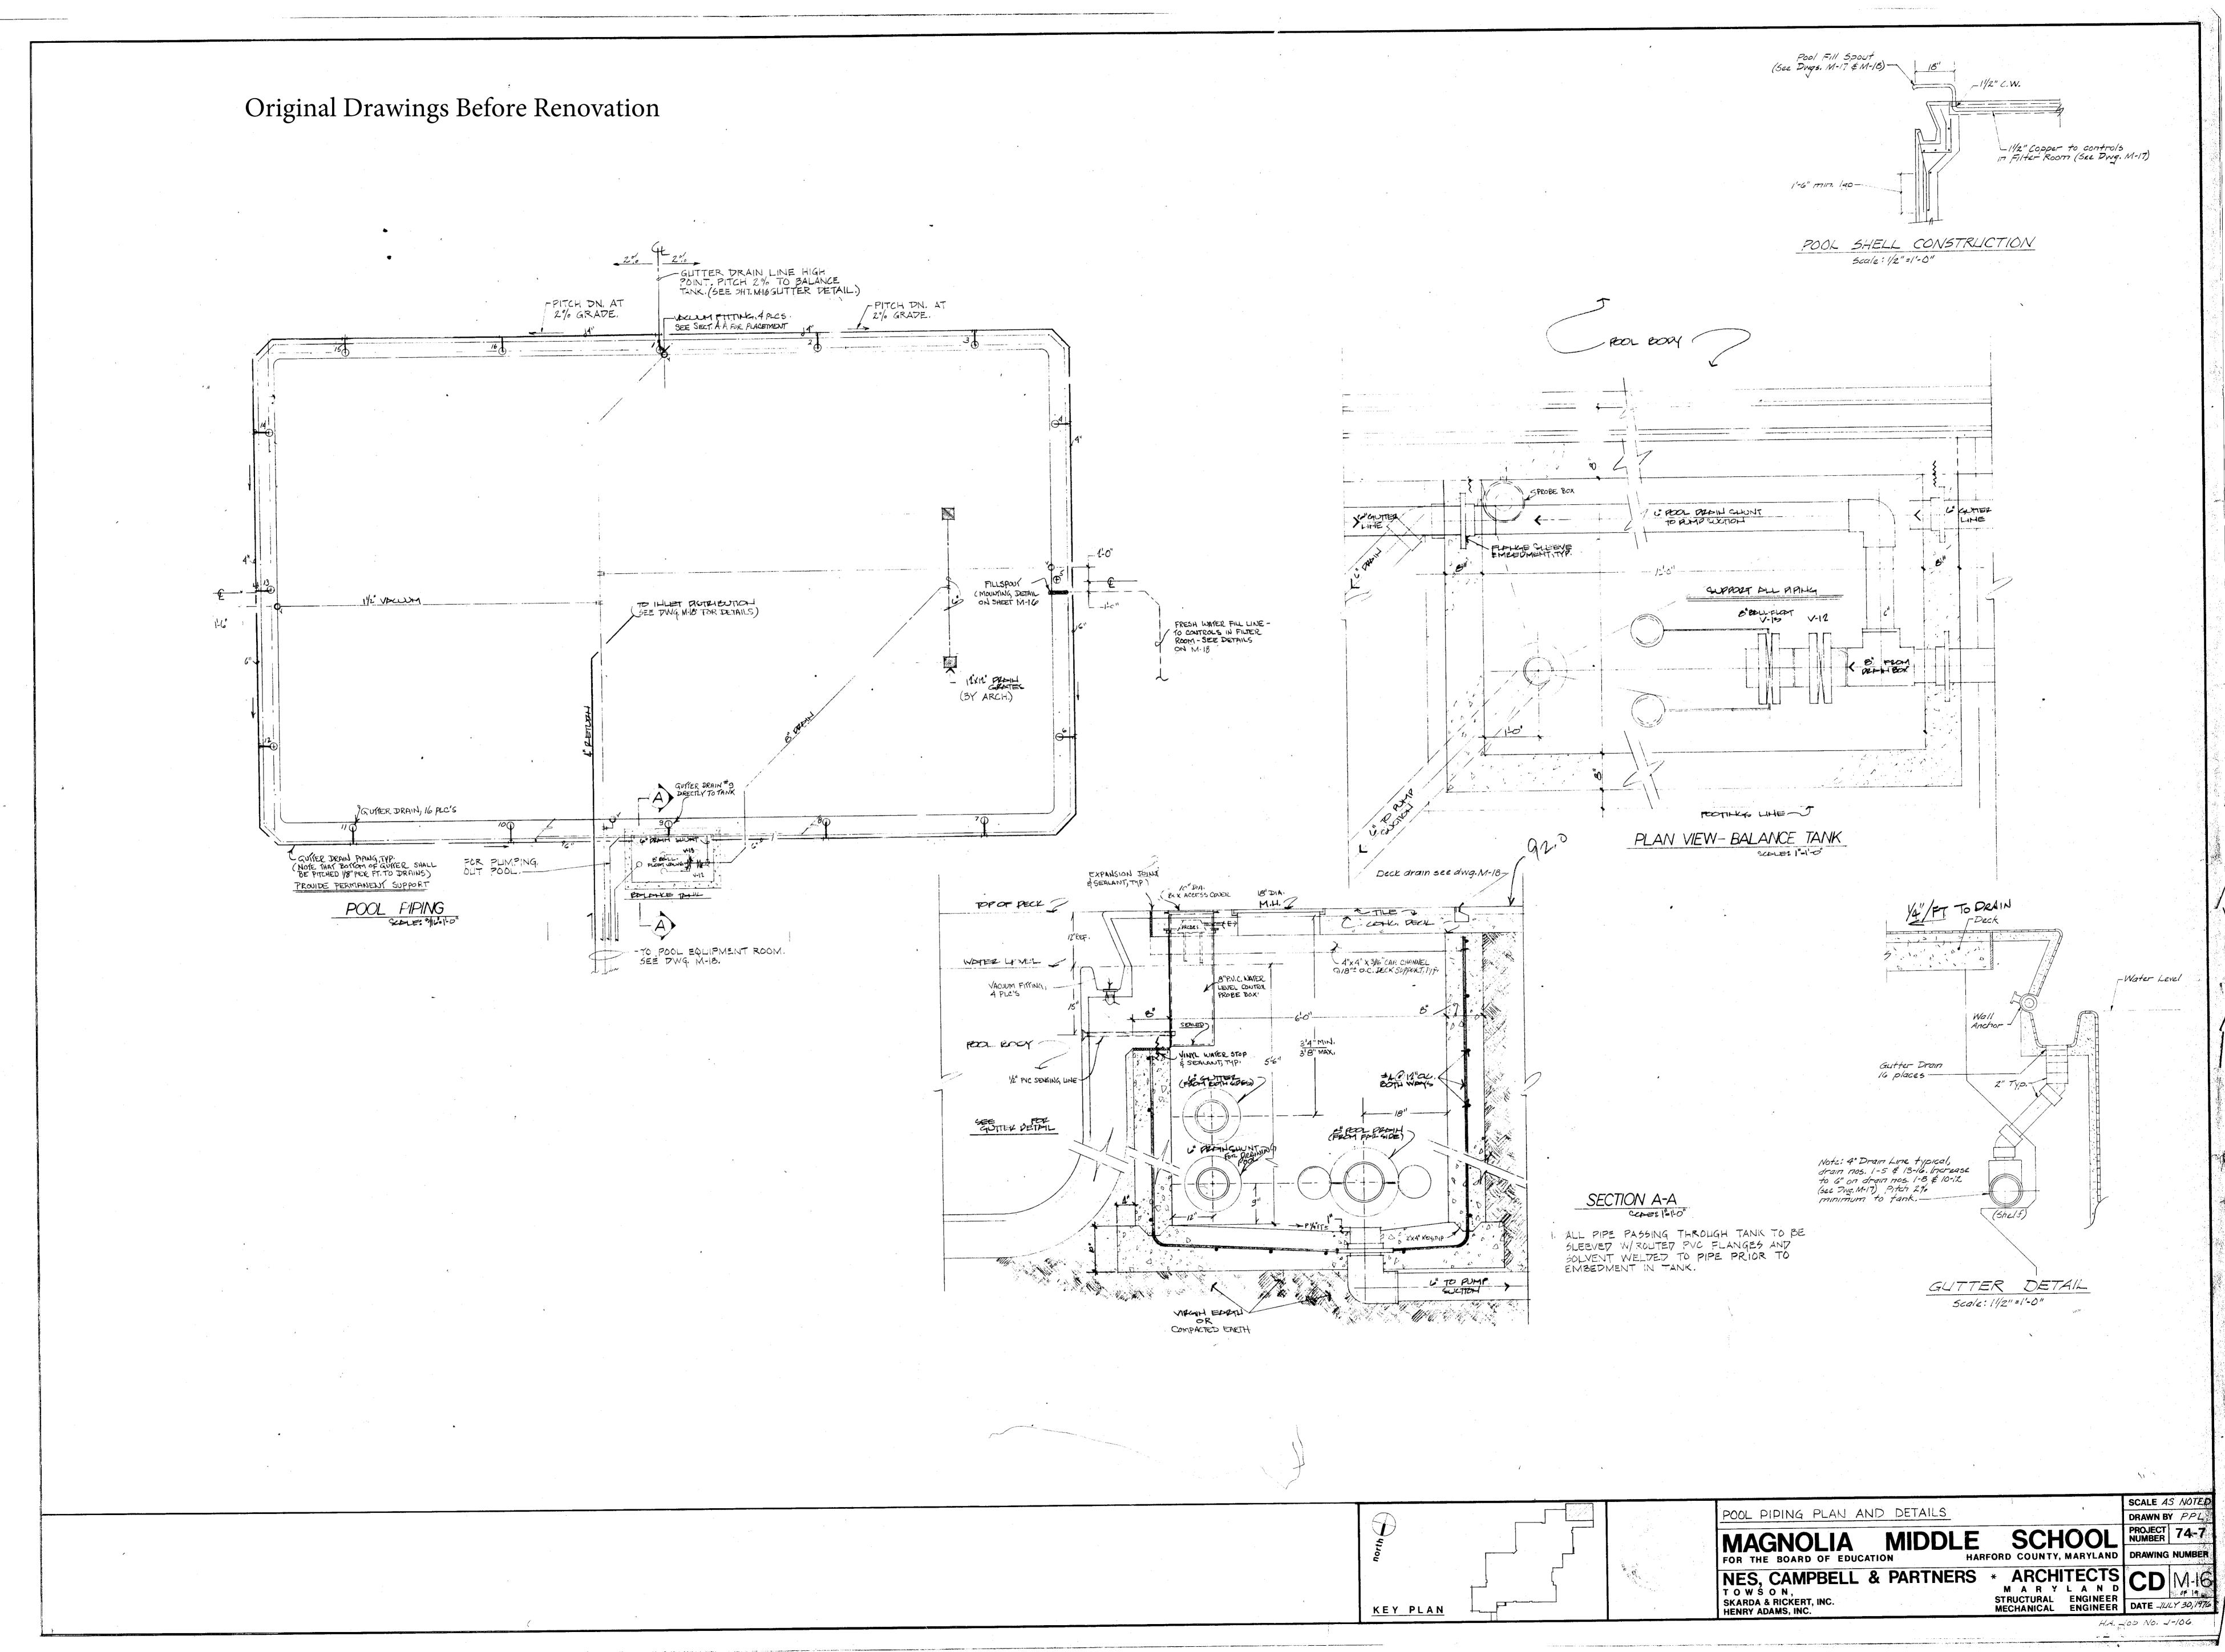

Original Drawings Before Renovation

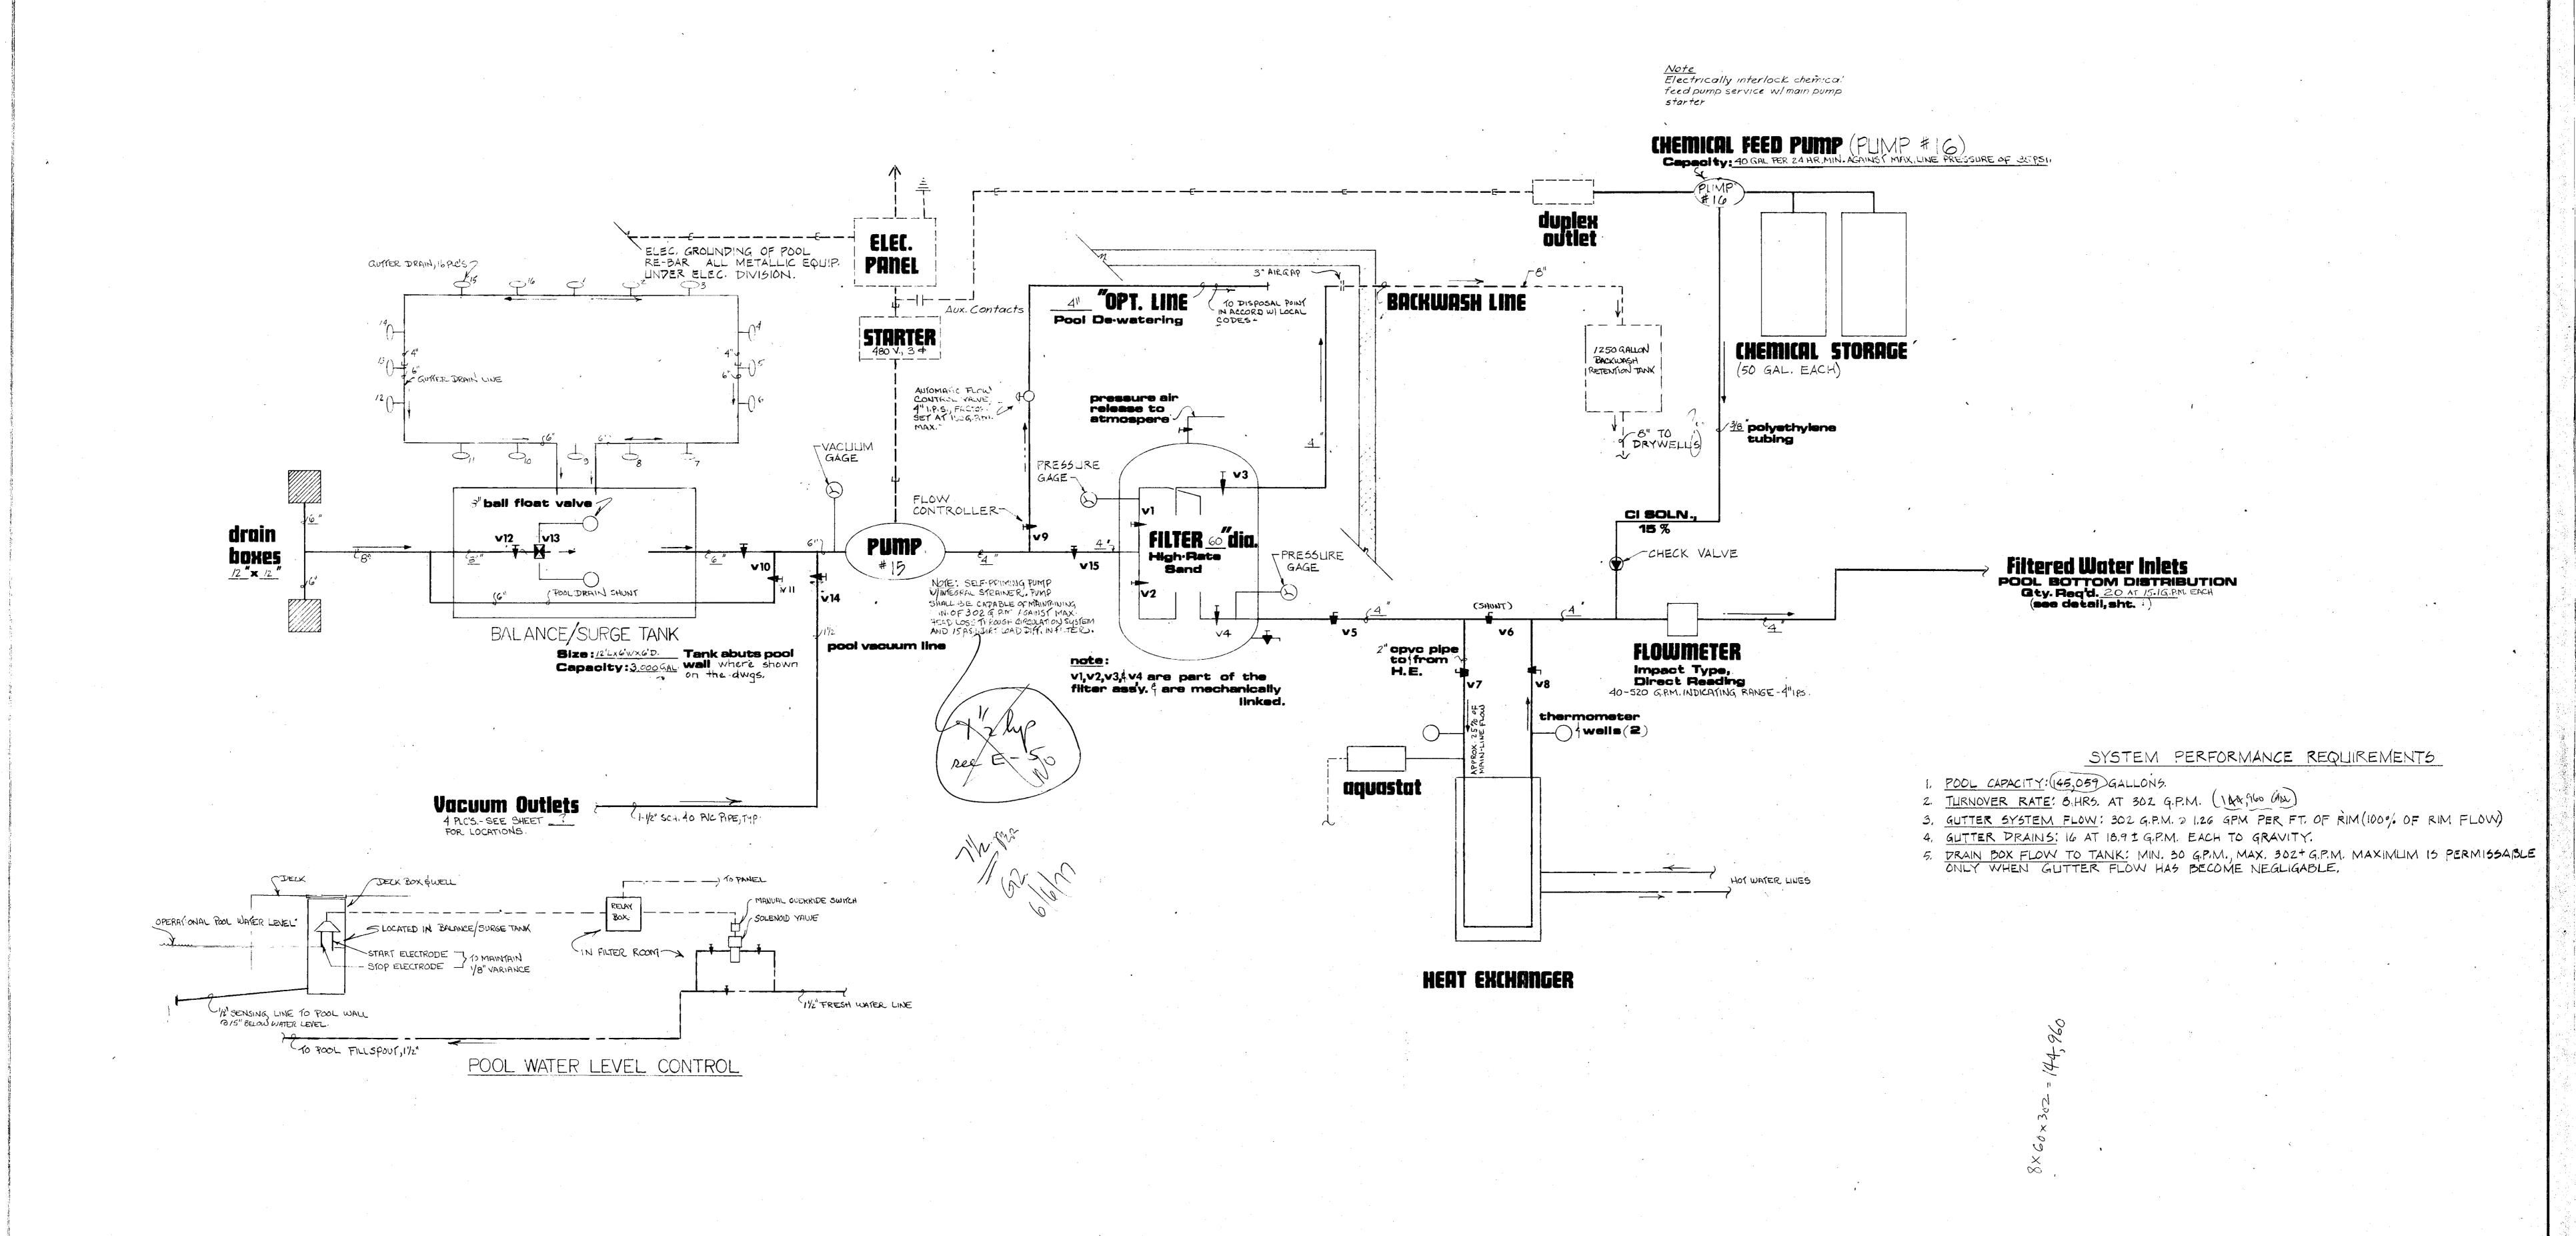

KEY PLAN

POOL PIPING FLOW DIAGRAM

MAGNOLIA MIDDLE SCHOON HARFORD COUNTY, MARYL

NES, CAMPBELL & PARTNERS * ARCHITECTOWS ON,
SKARDA & RICKERT, INC.
HENRY ADAMS, INC.

**ARCHITECTOR MARY LANSTRUCTURAL ENGINE
MECHANICAL ENGINE


* ARCHITECTS

M A R Y L A N D

STRUCTURAL ENGINEER
MECHANICAL ENGINEER

DATE JULY 30, 197


Original Drawings Before Renovation

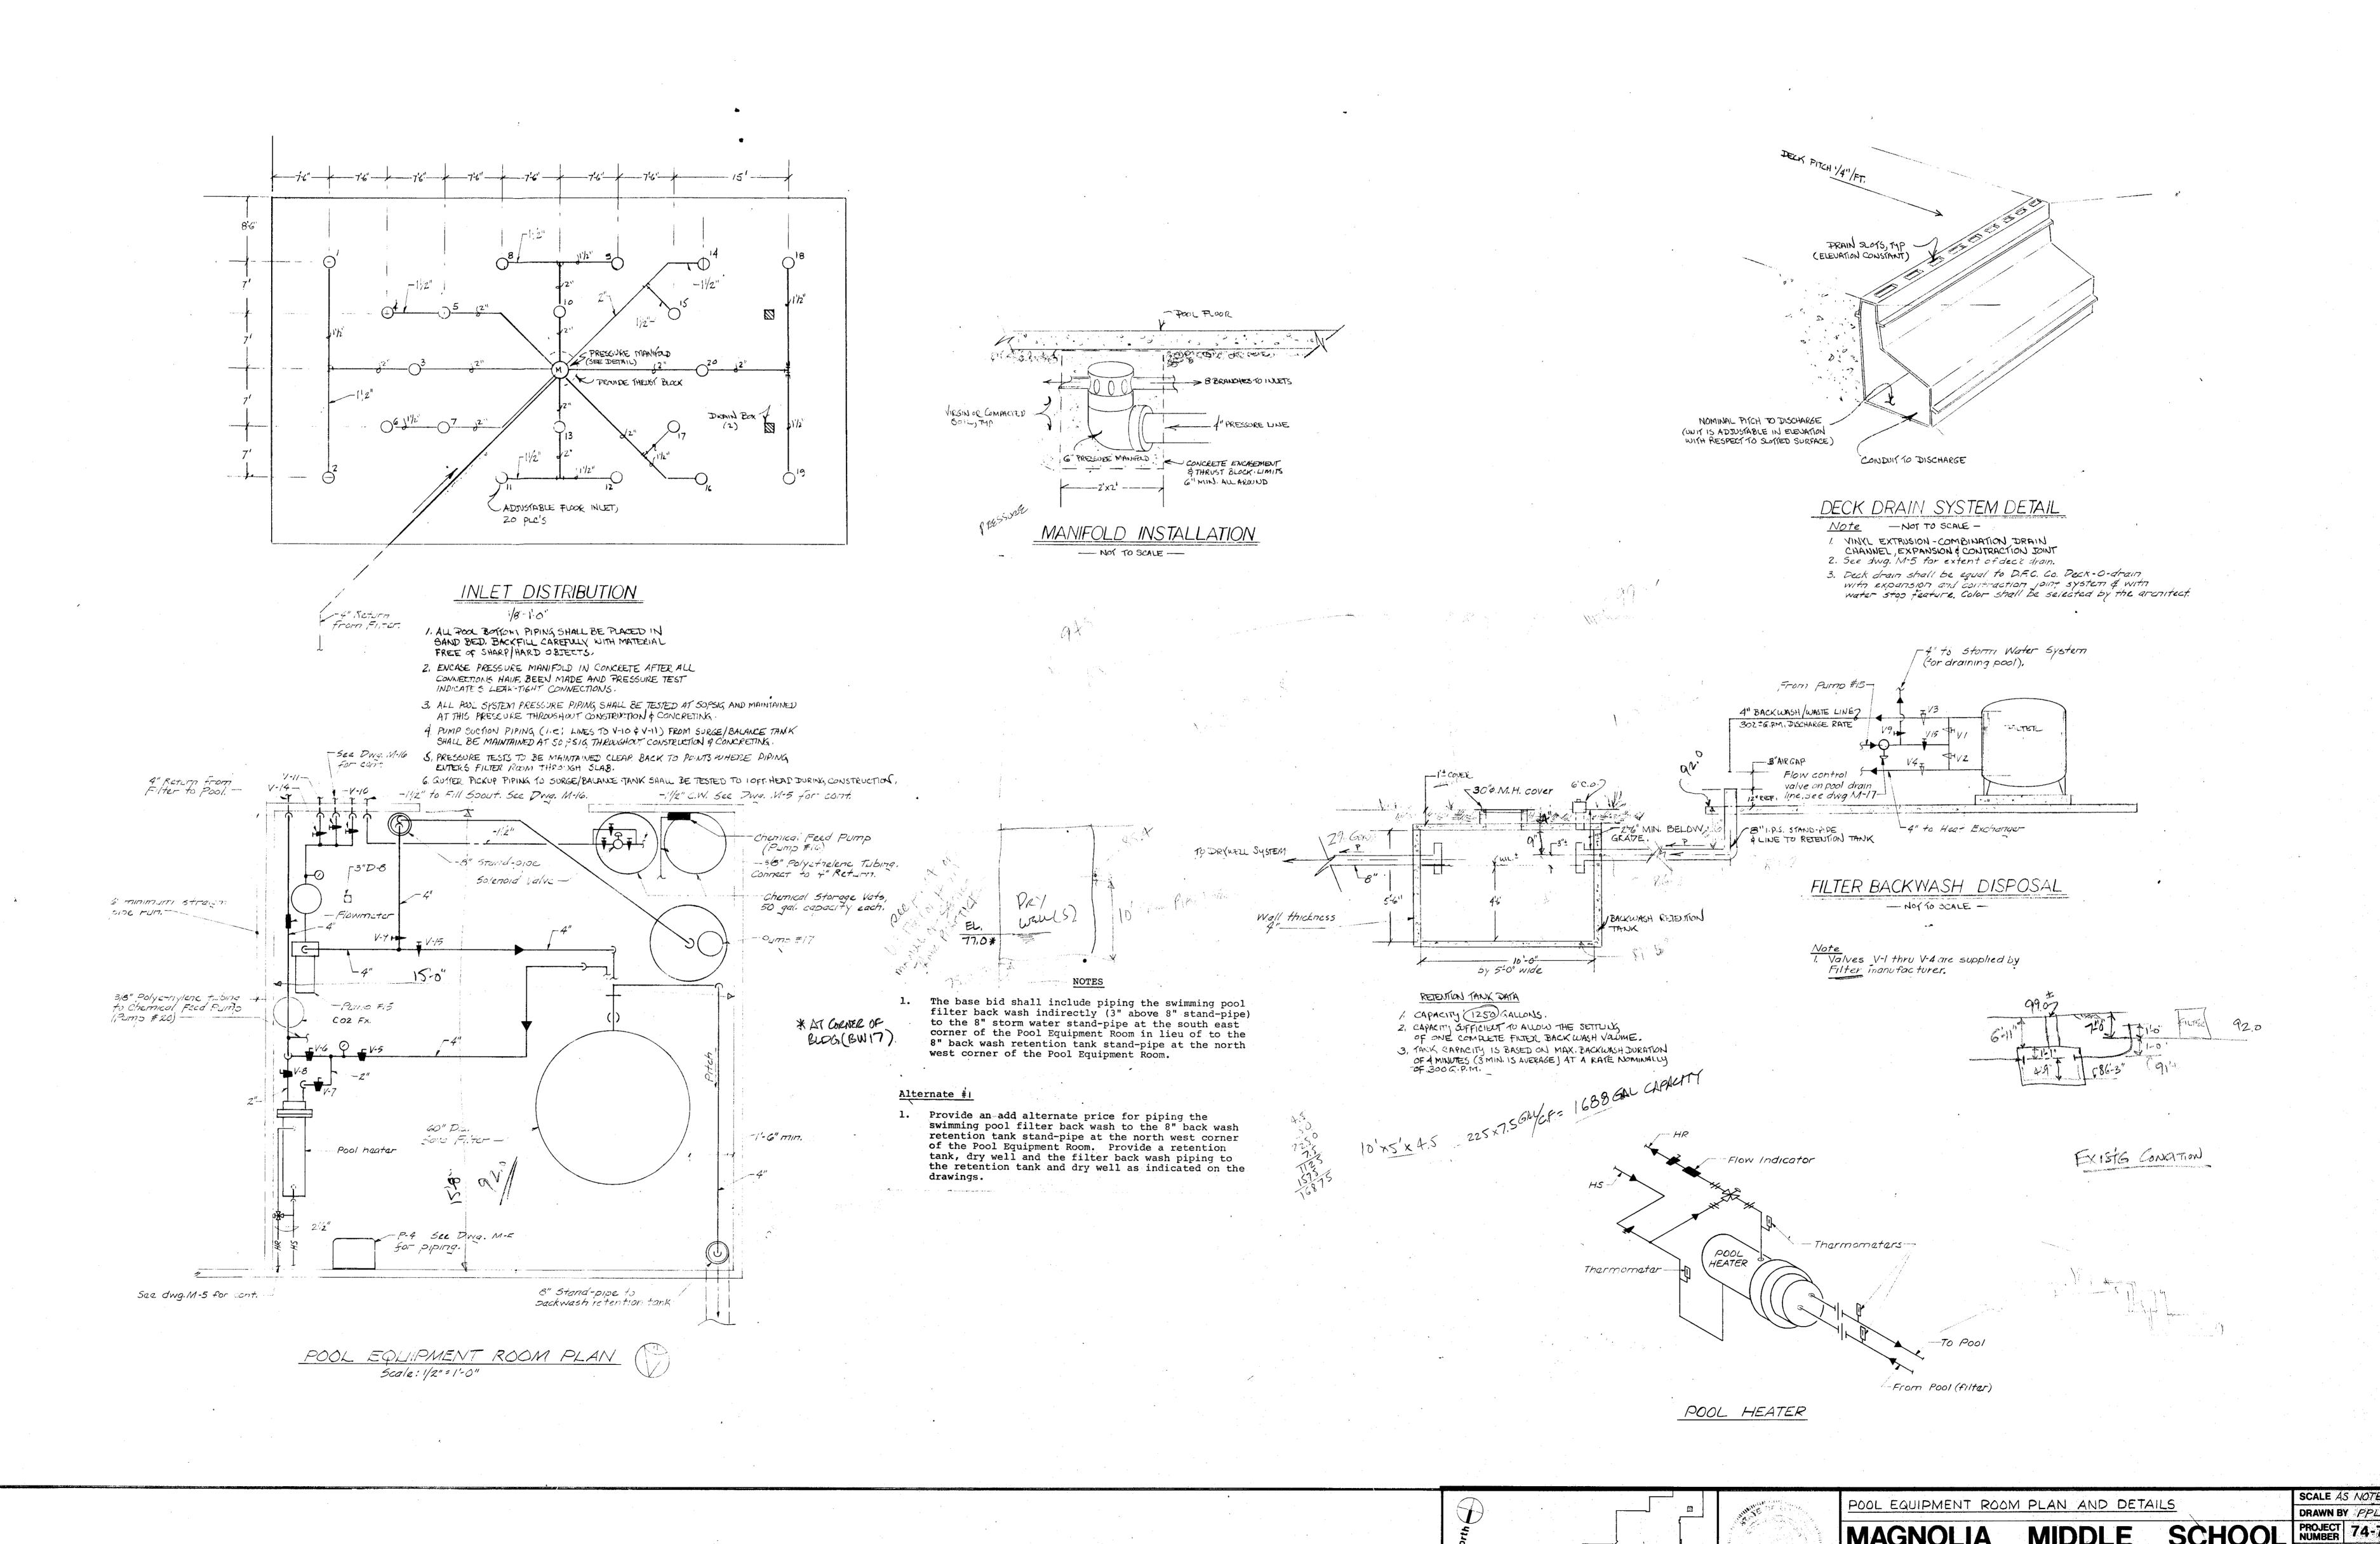



KEY PLAN


NES, CAMPBELL & PARTNERS
TOWSON,
SKARDA & RICKERT, INC.
HENRY ADAMS, INC.


* ARCHITECTS
M A R Y L A N D
STRUCTURAL ENGINEER
MECHANICAL ENGINEER
DATE

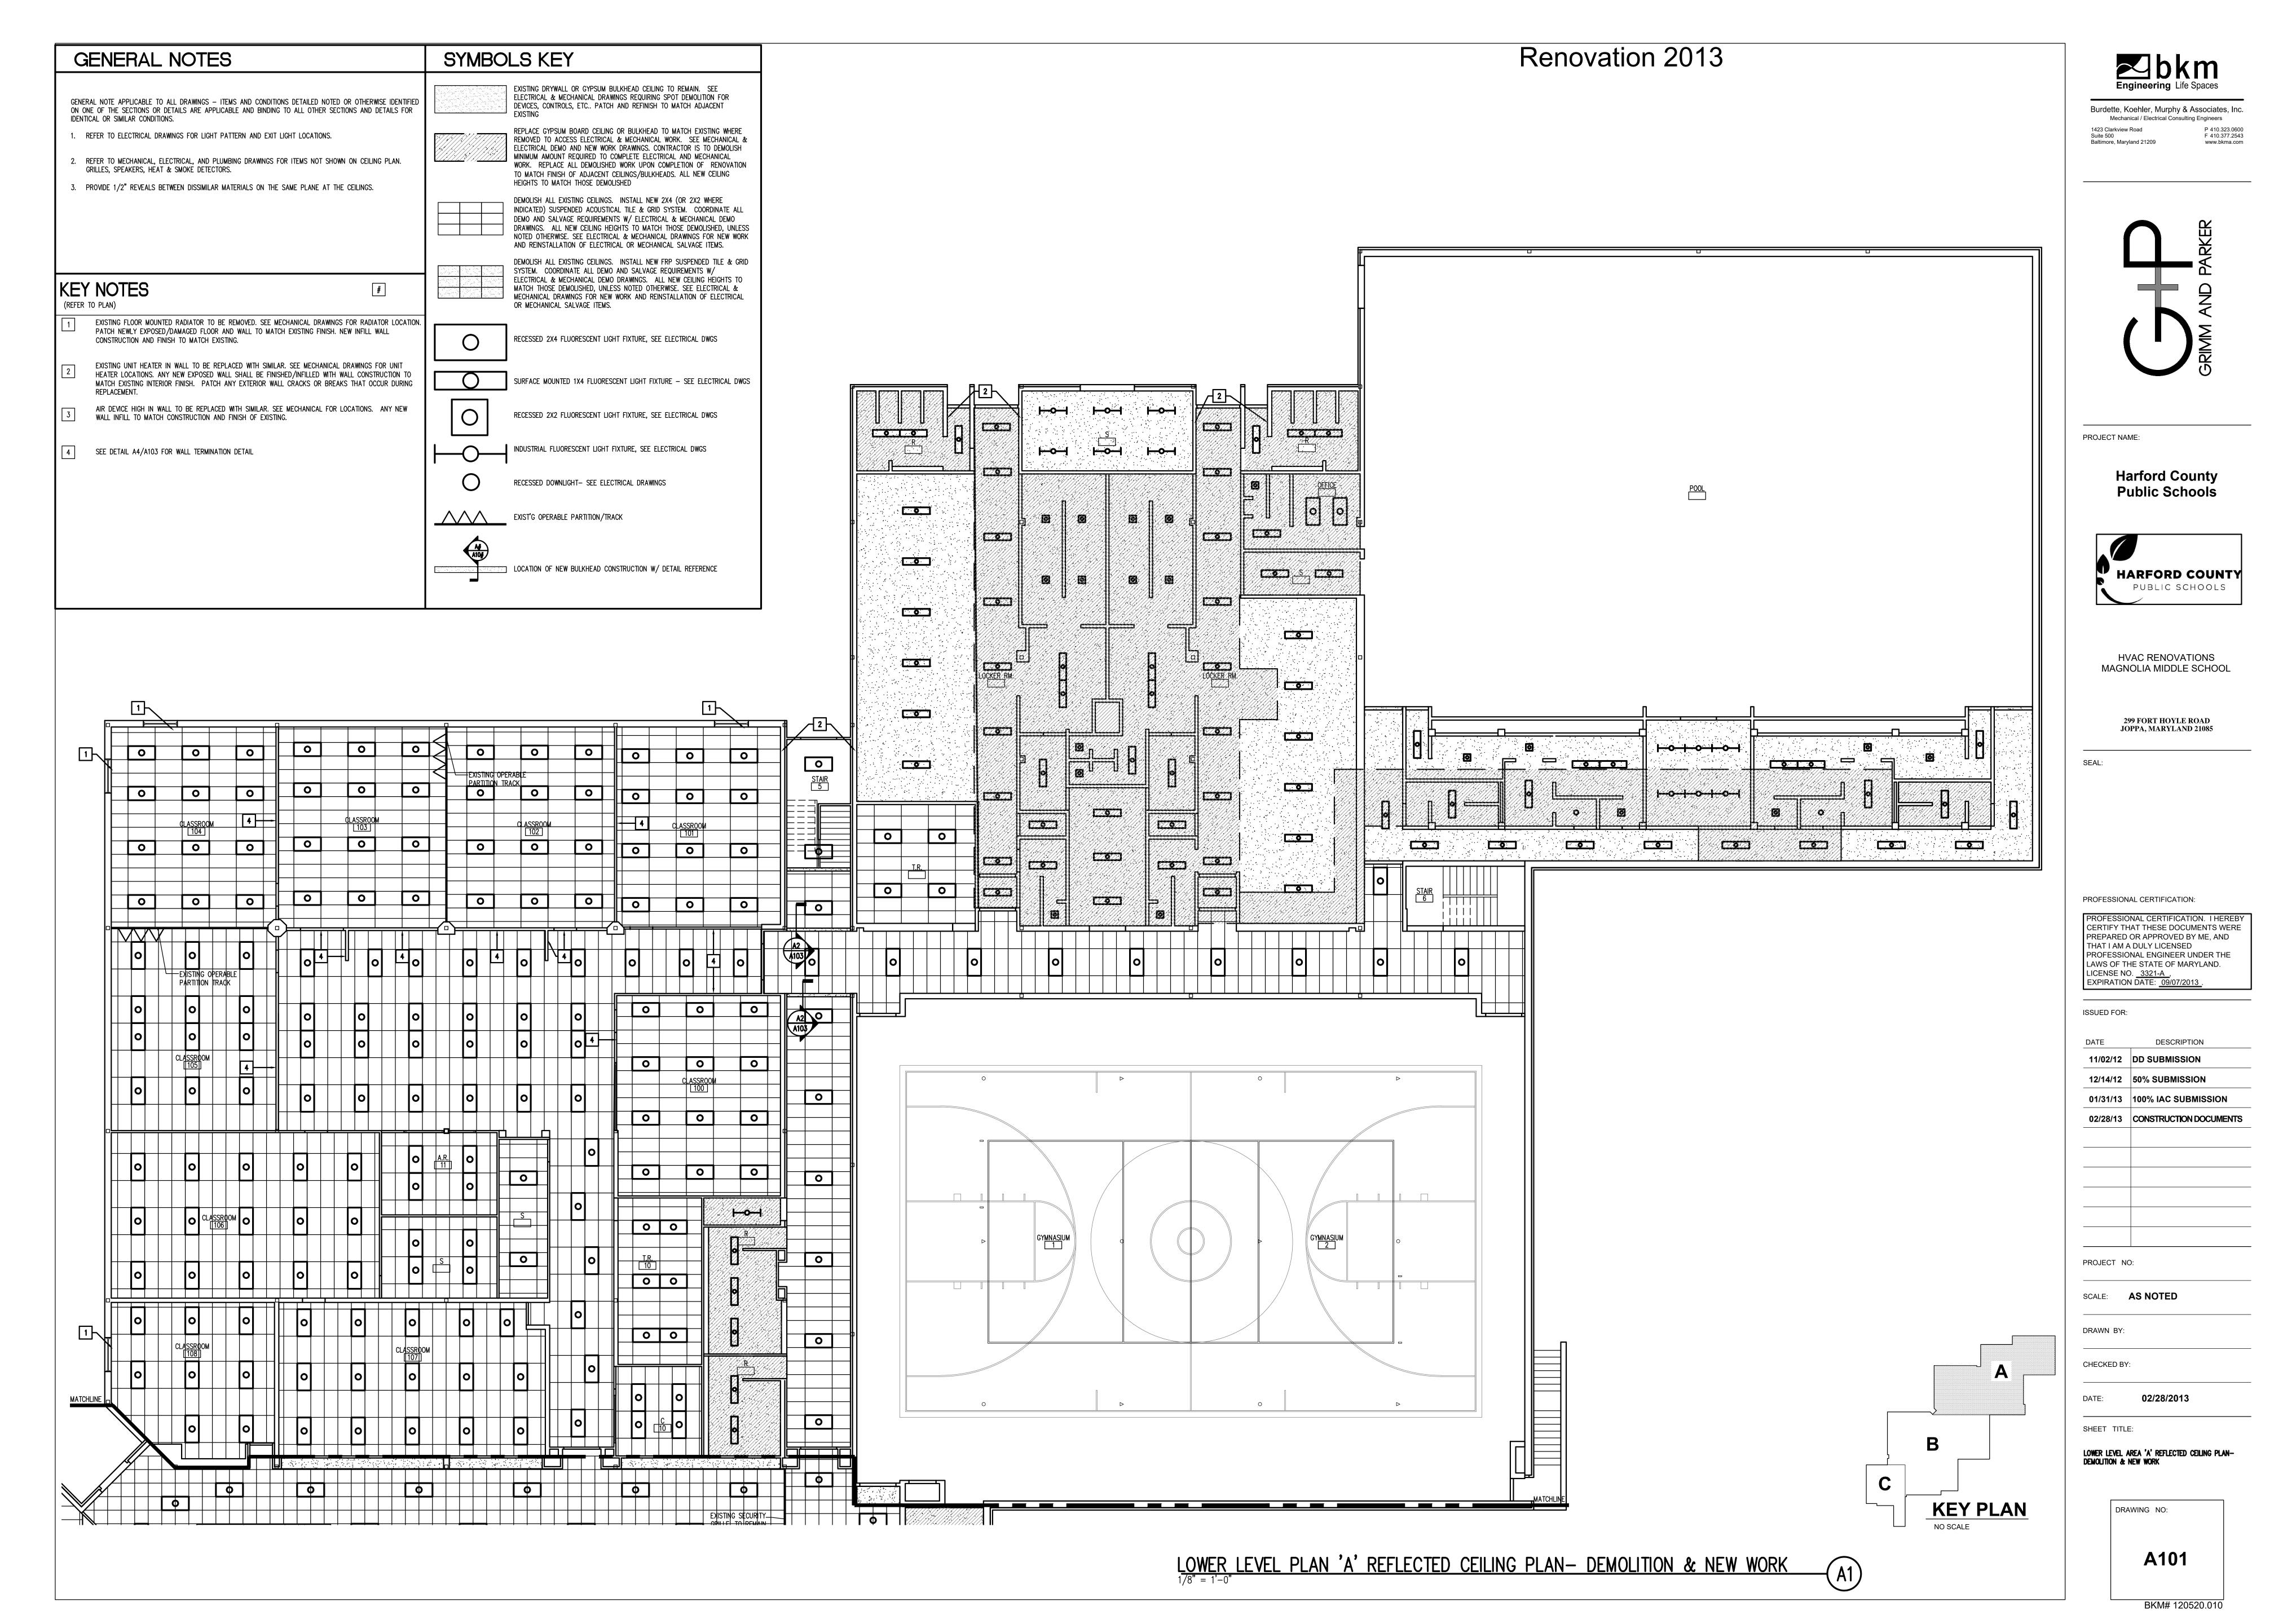

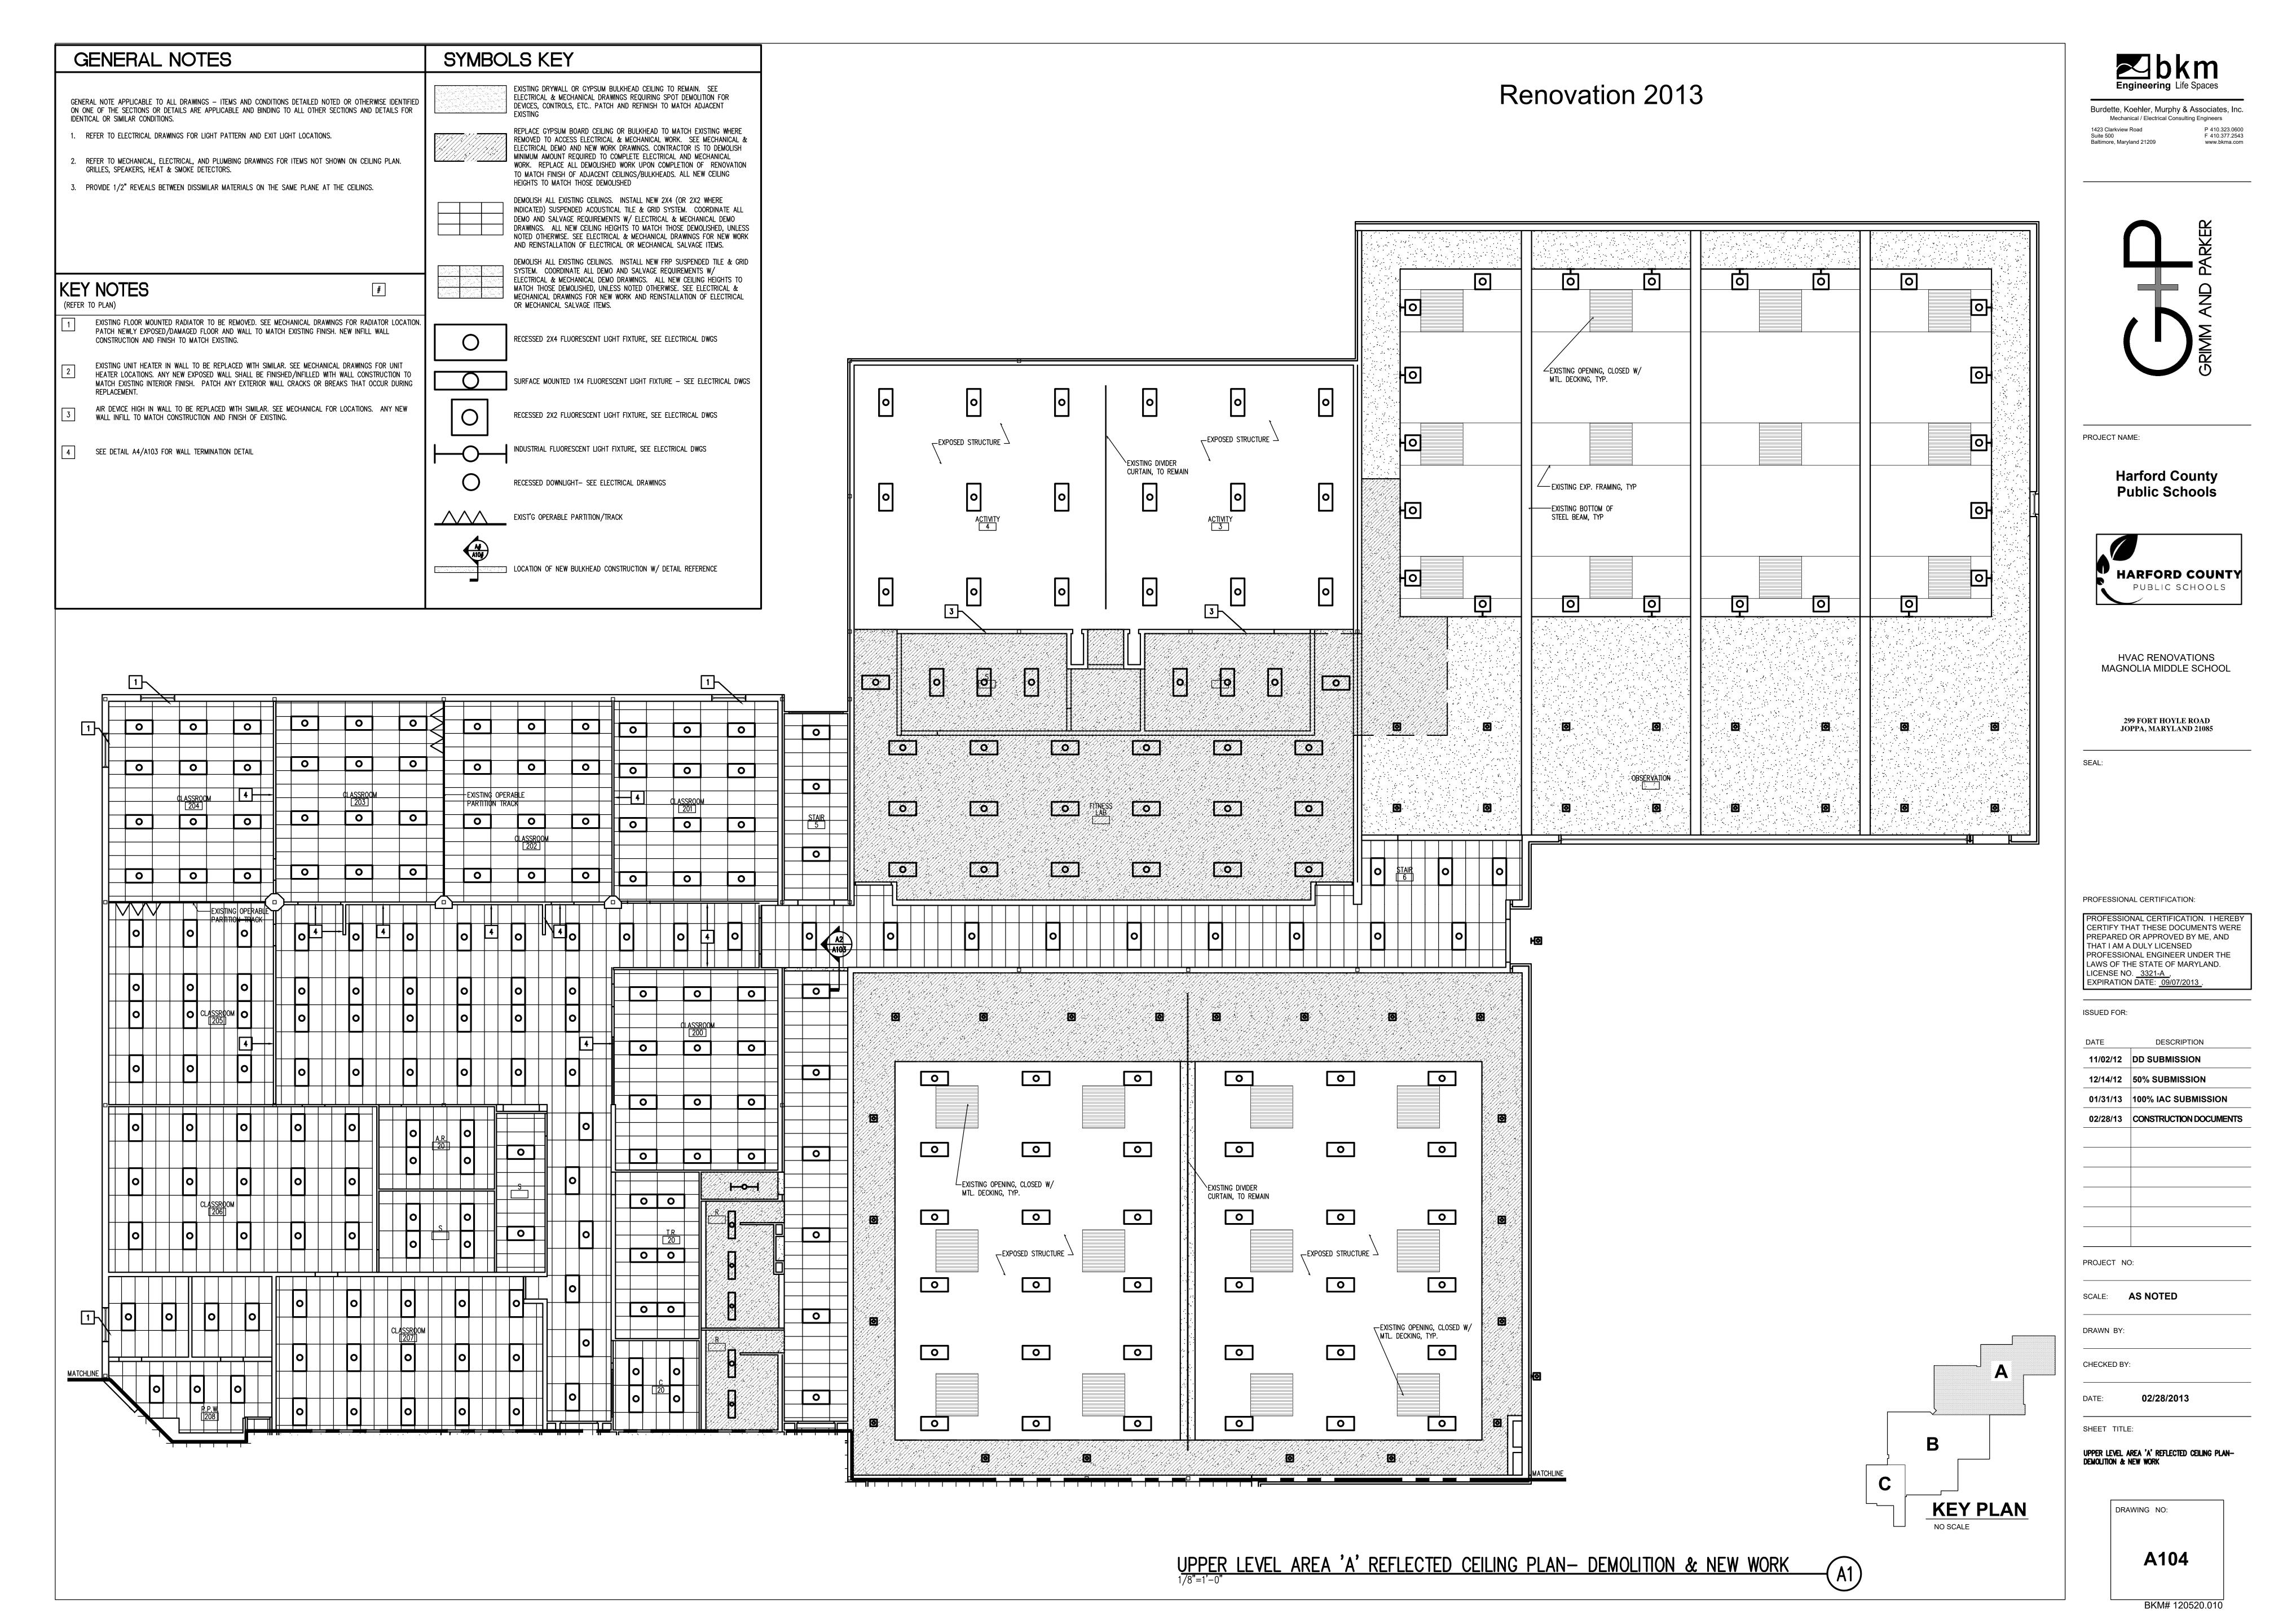

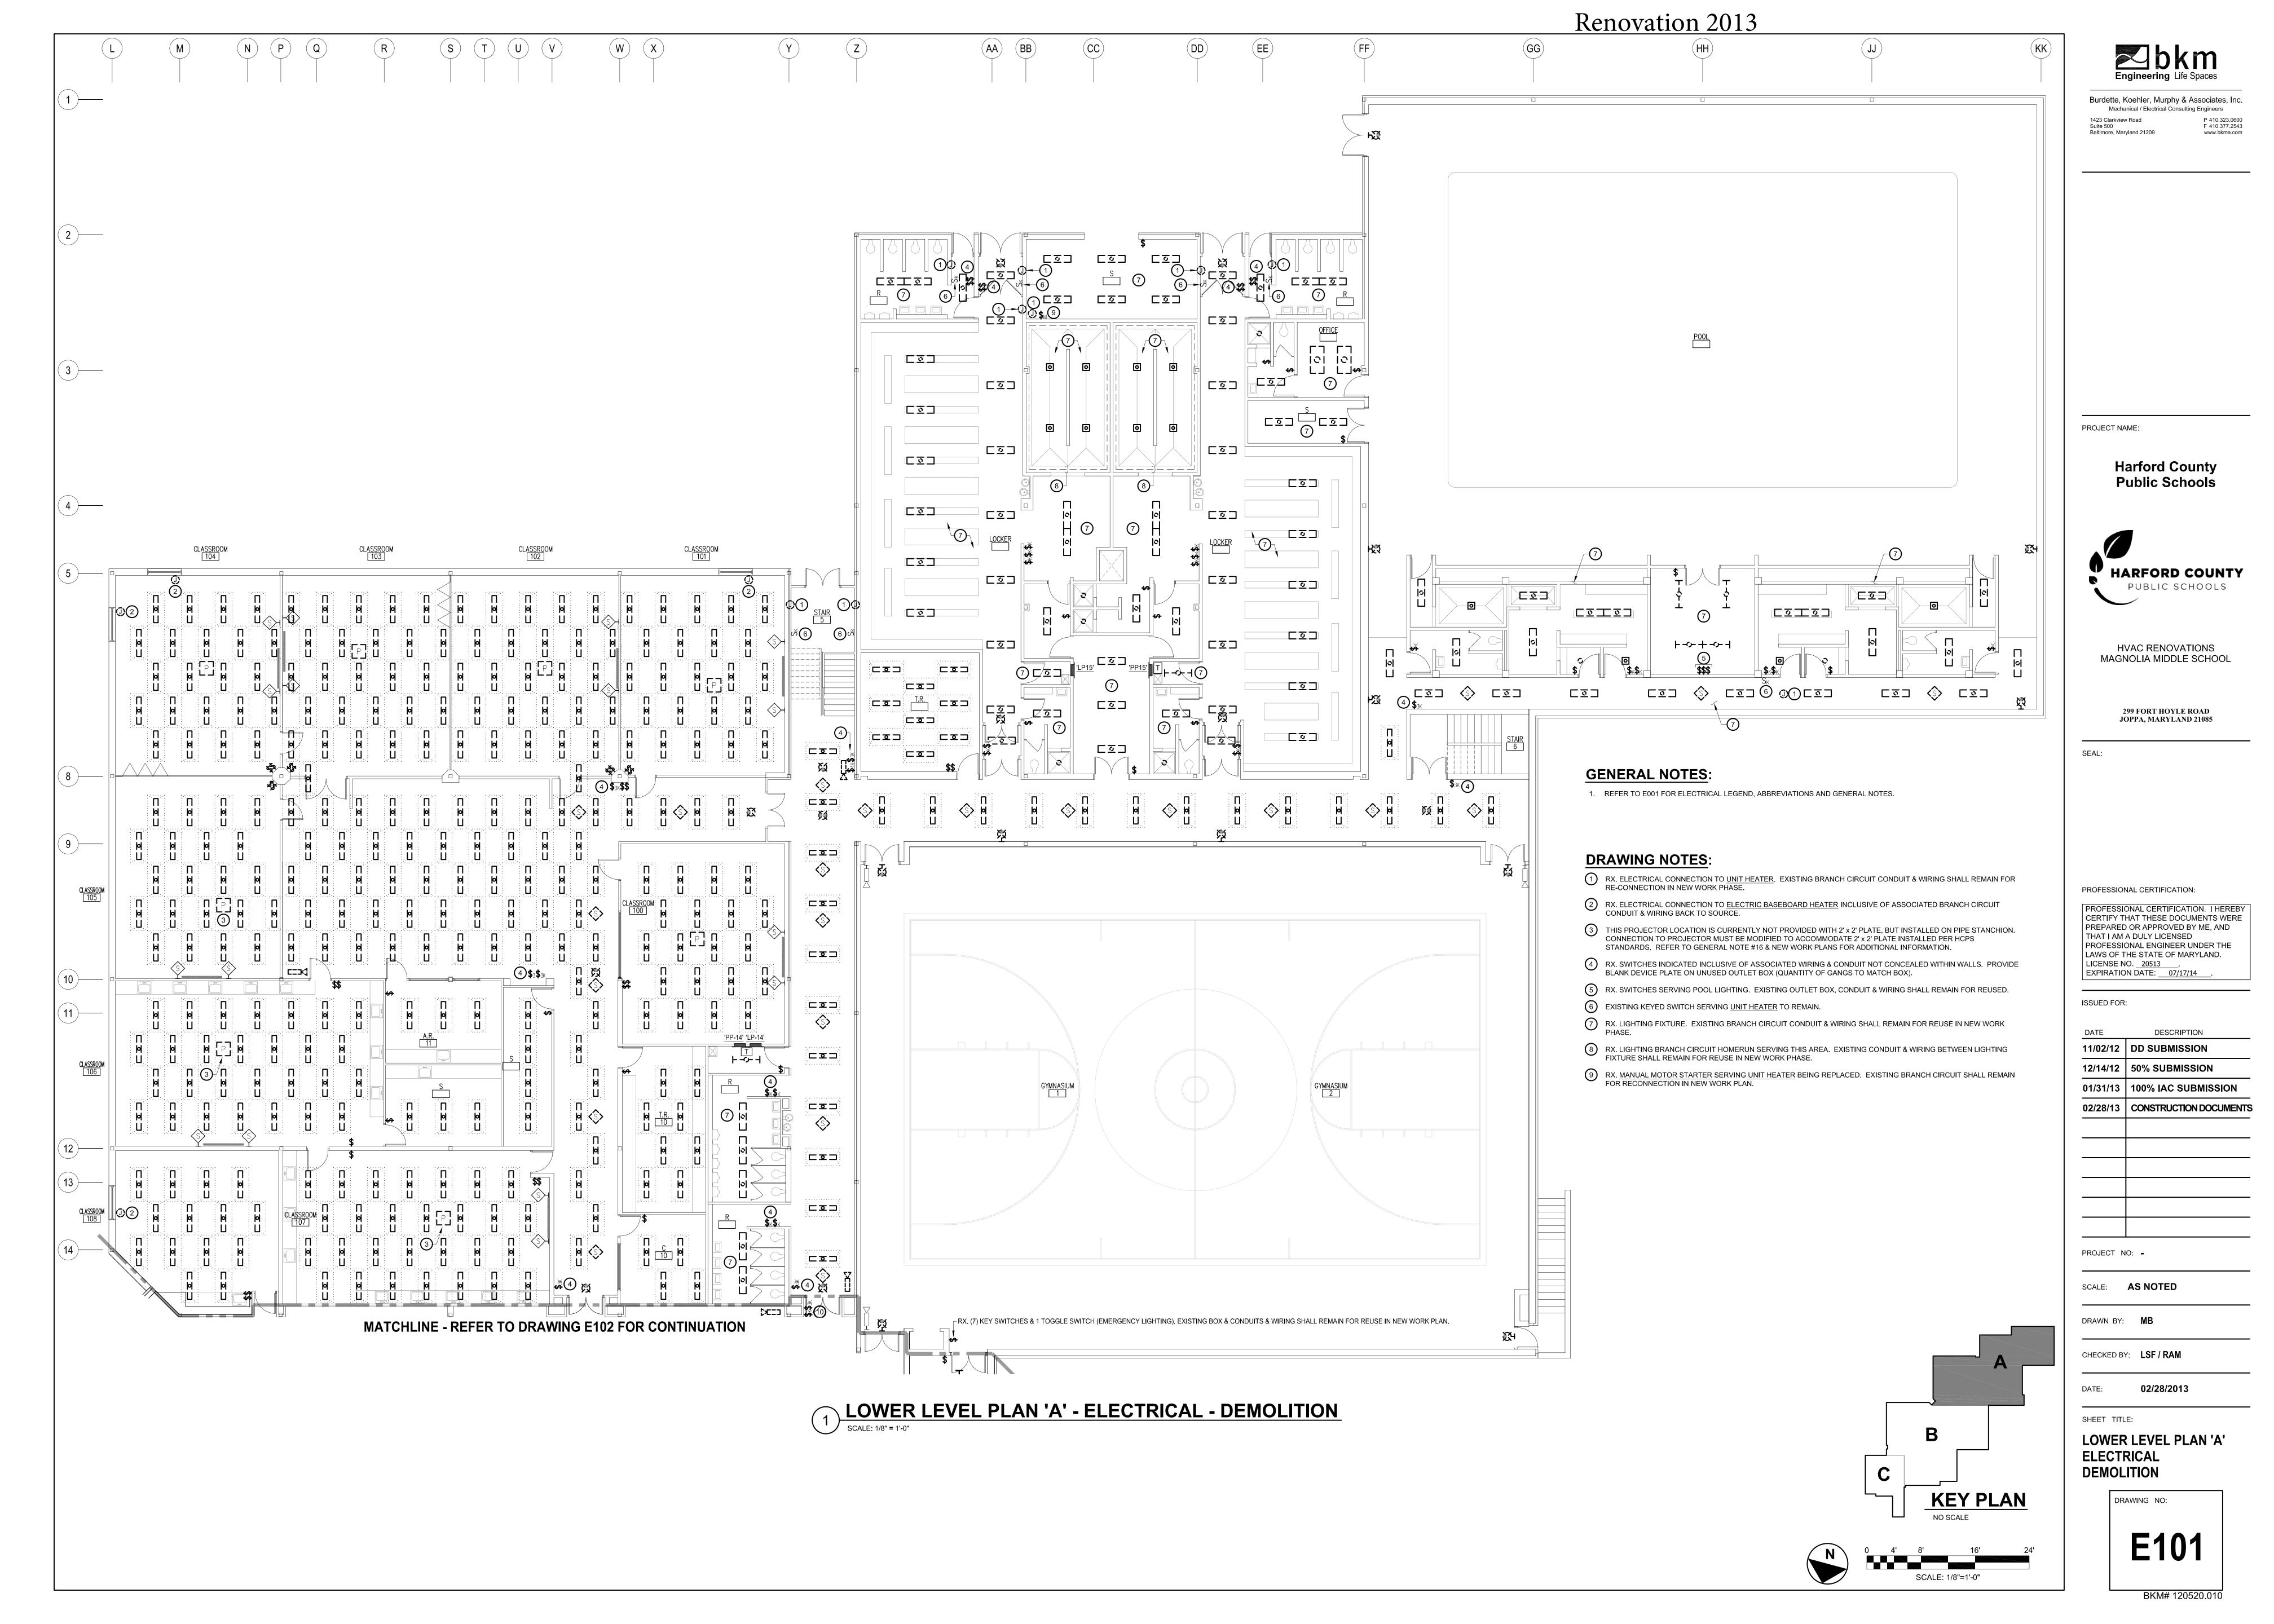


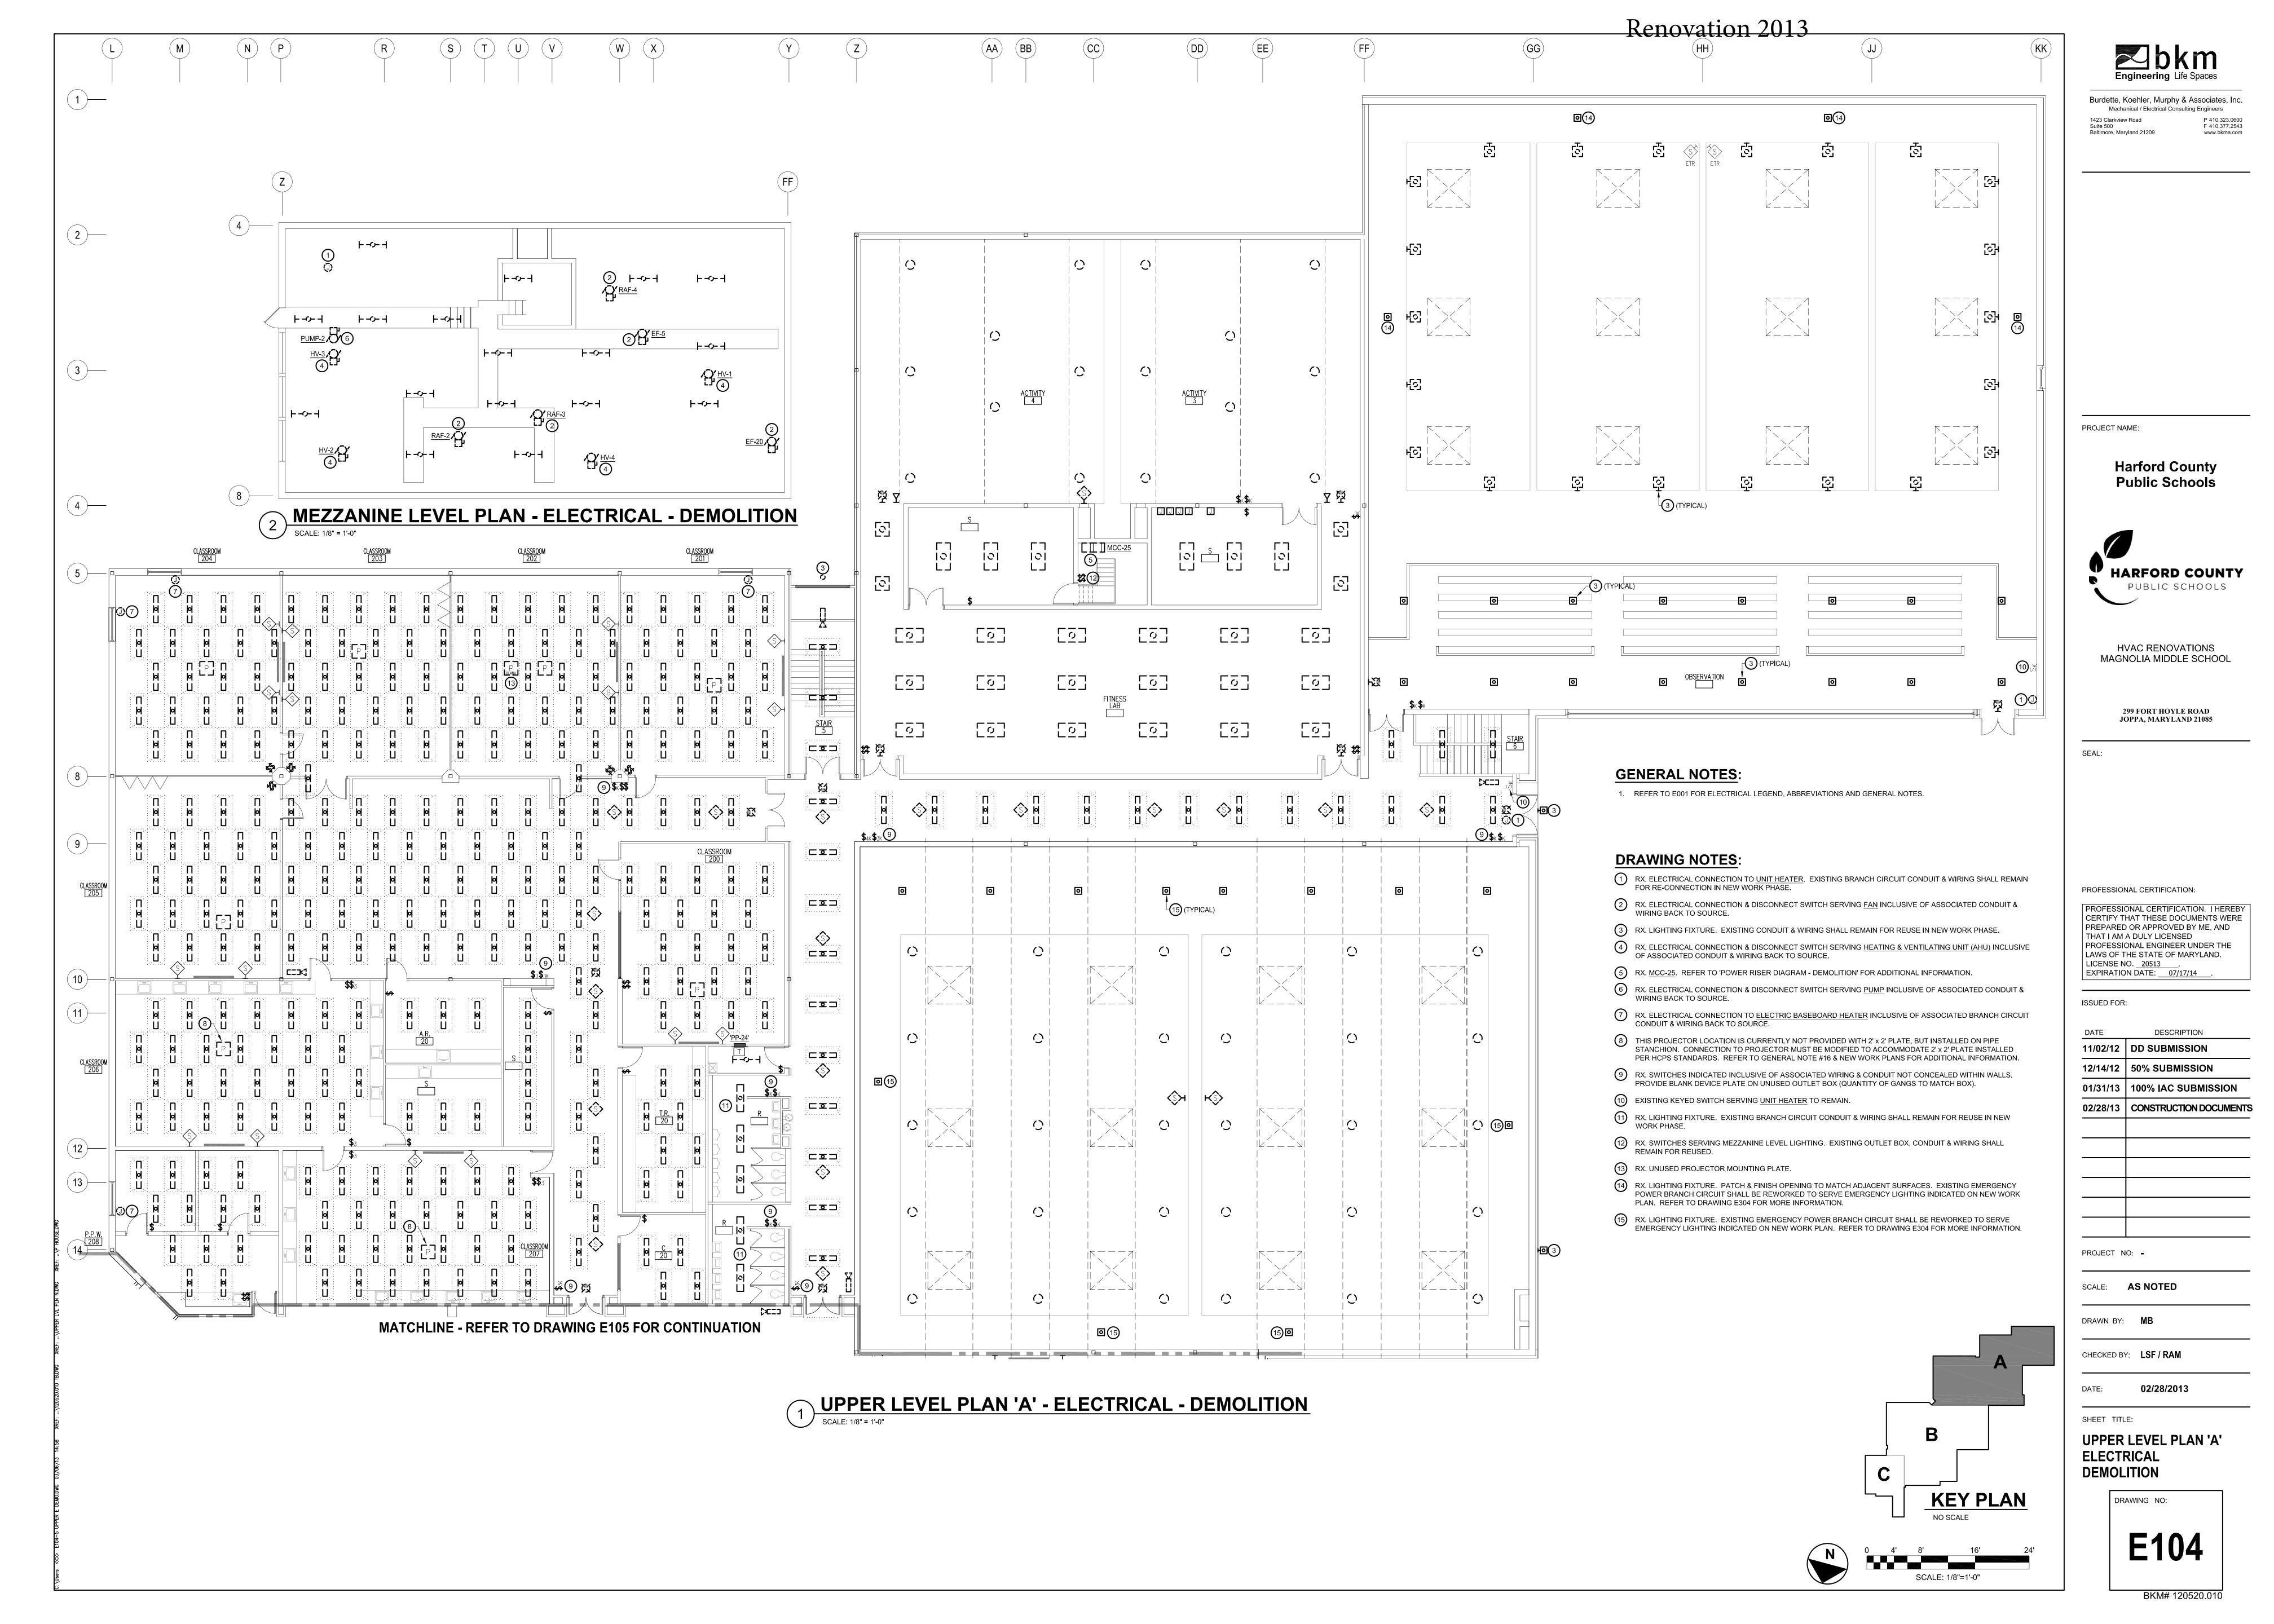


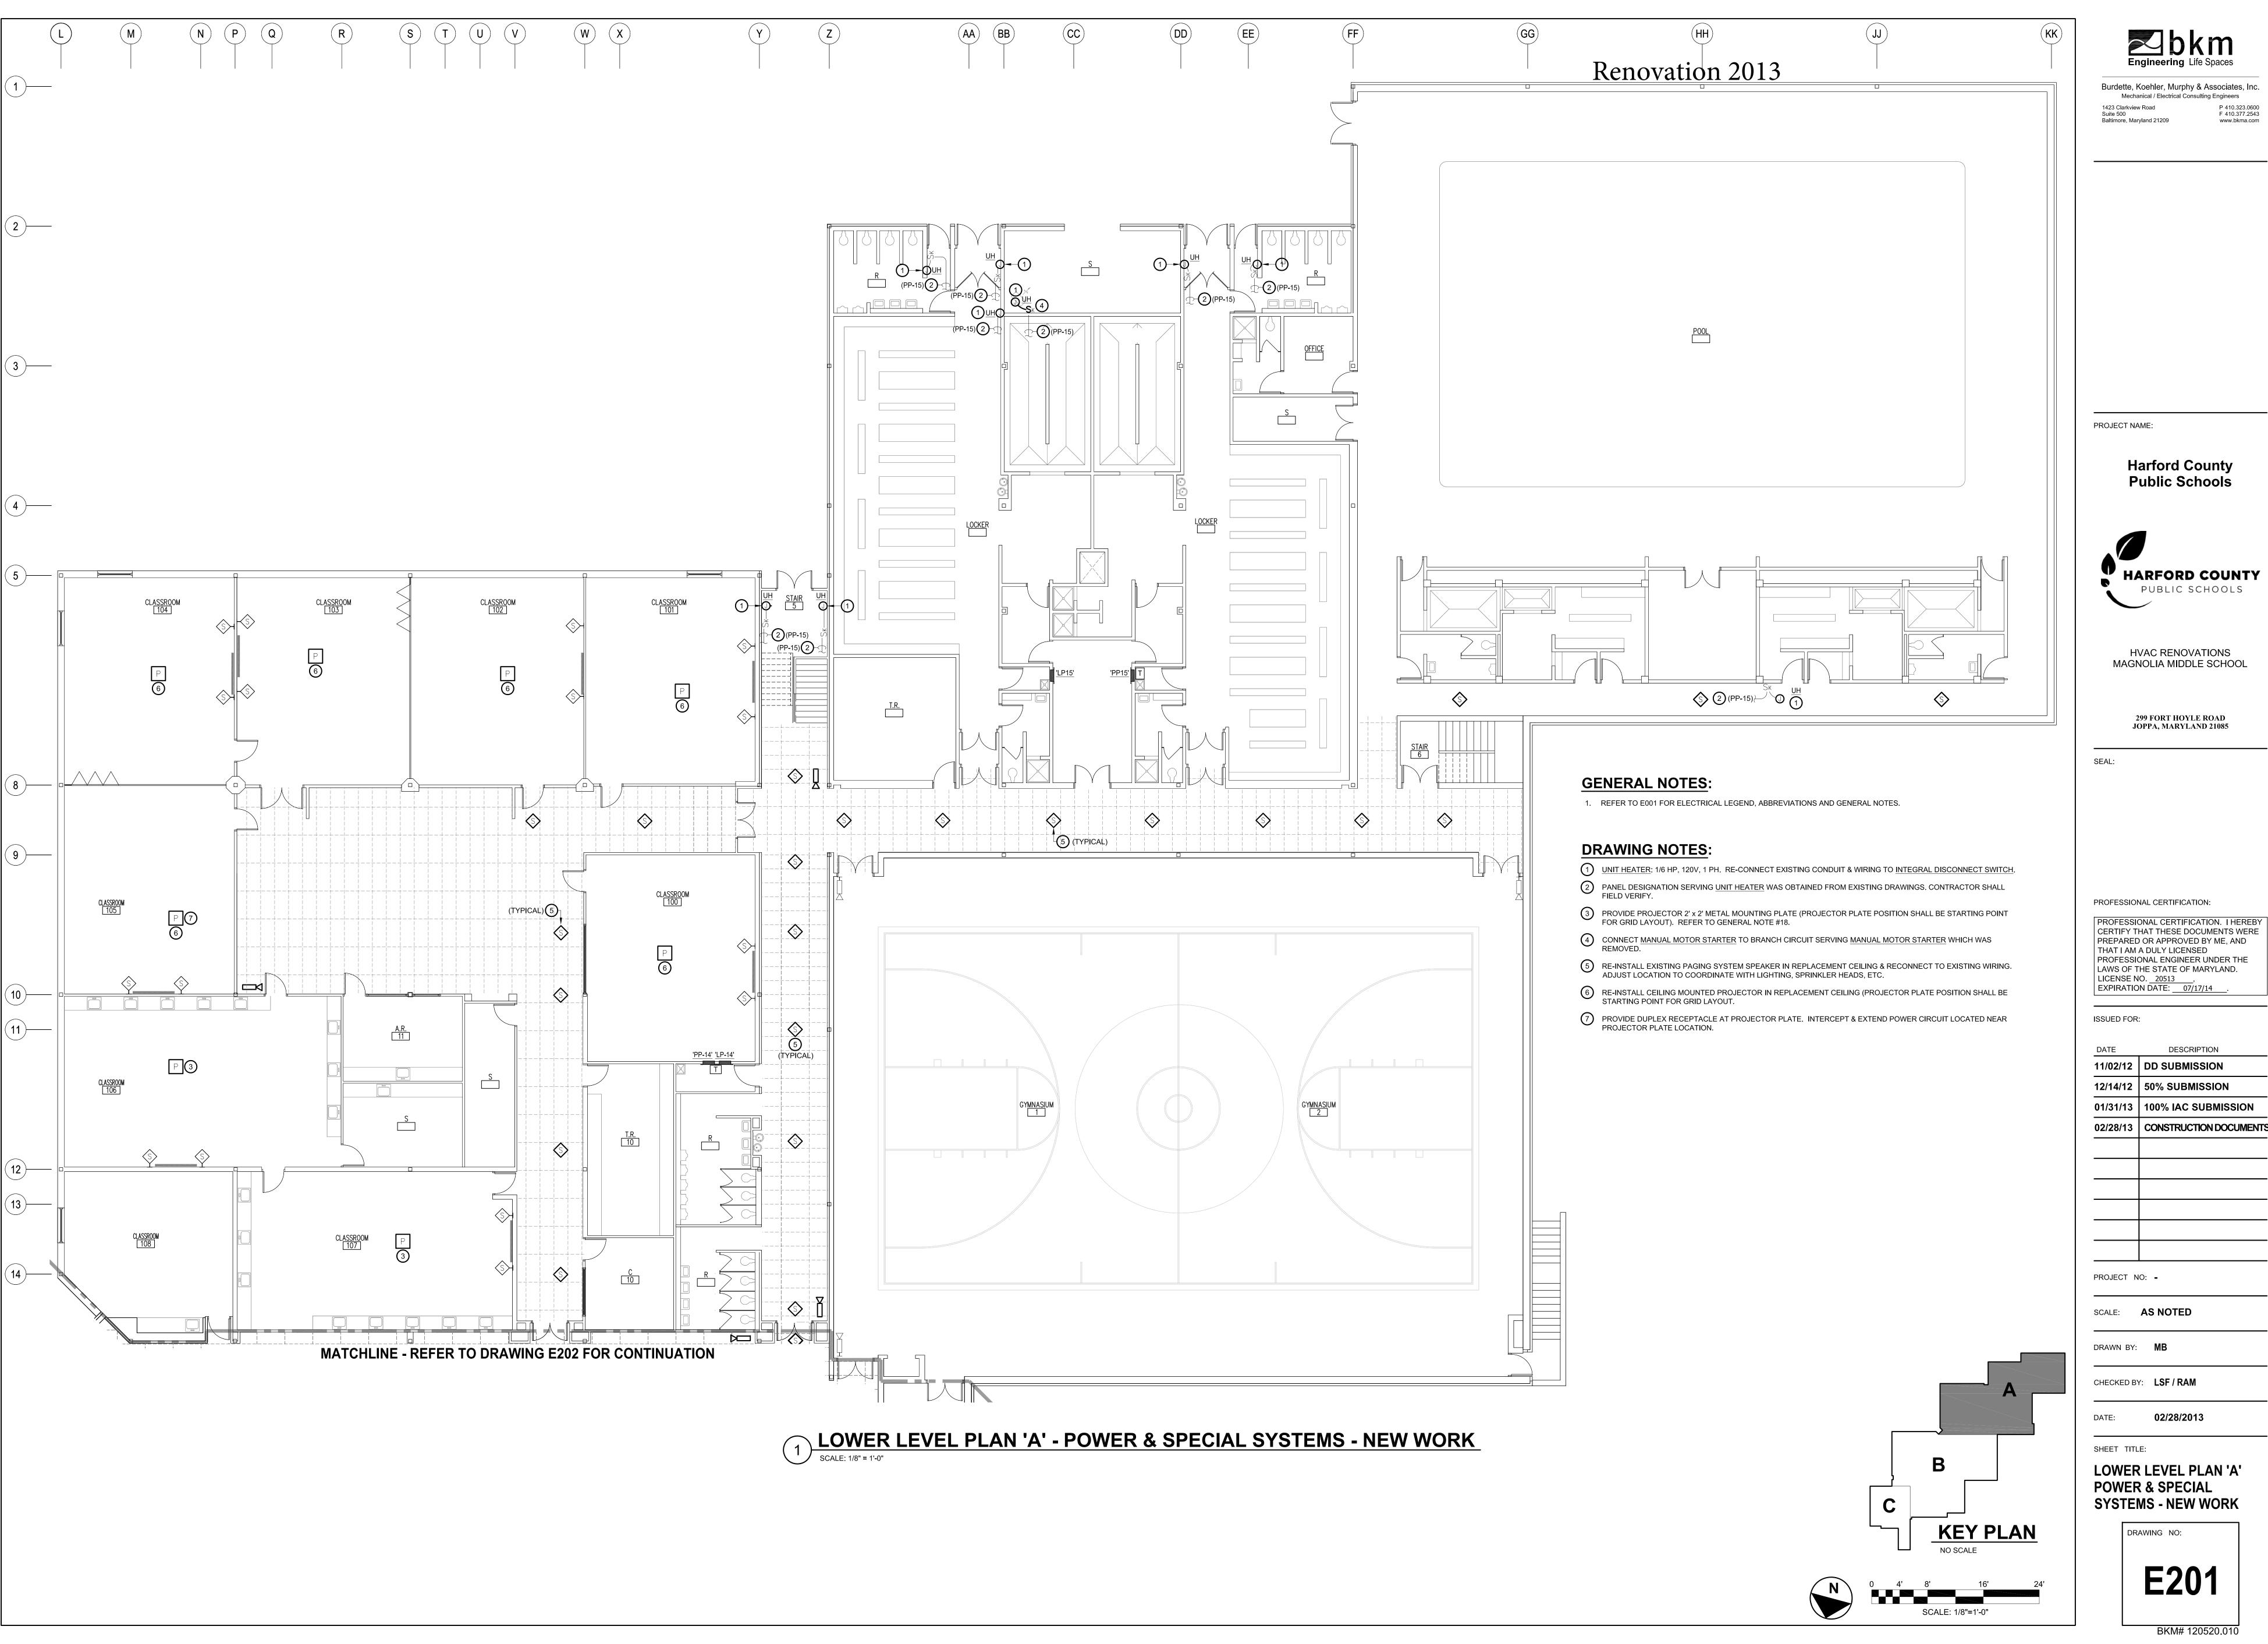



DATE	DESCRIPTION
11/02/12	DD SUBMISSION
12/14/12	50% SUBMISSION
01/31/13	100% IAC SUBMISSION
02/28/13	CONSTRUCTION DOCUMENT

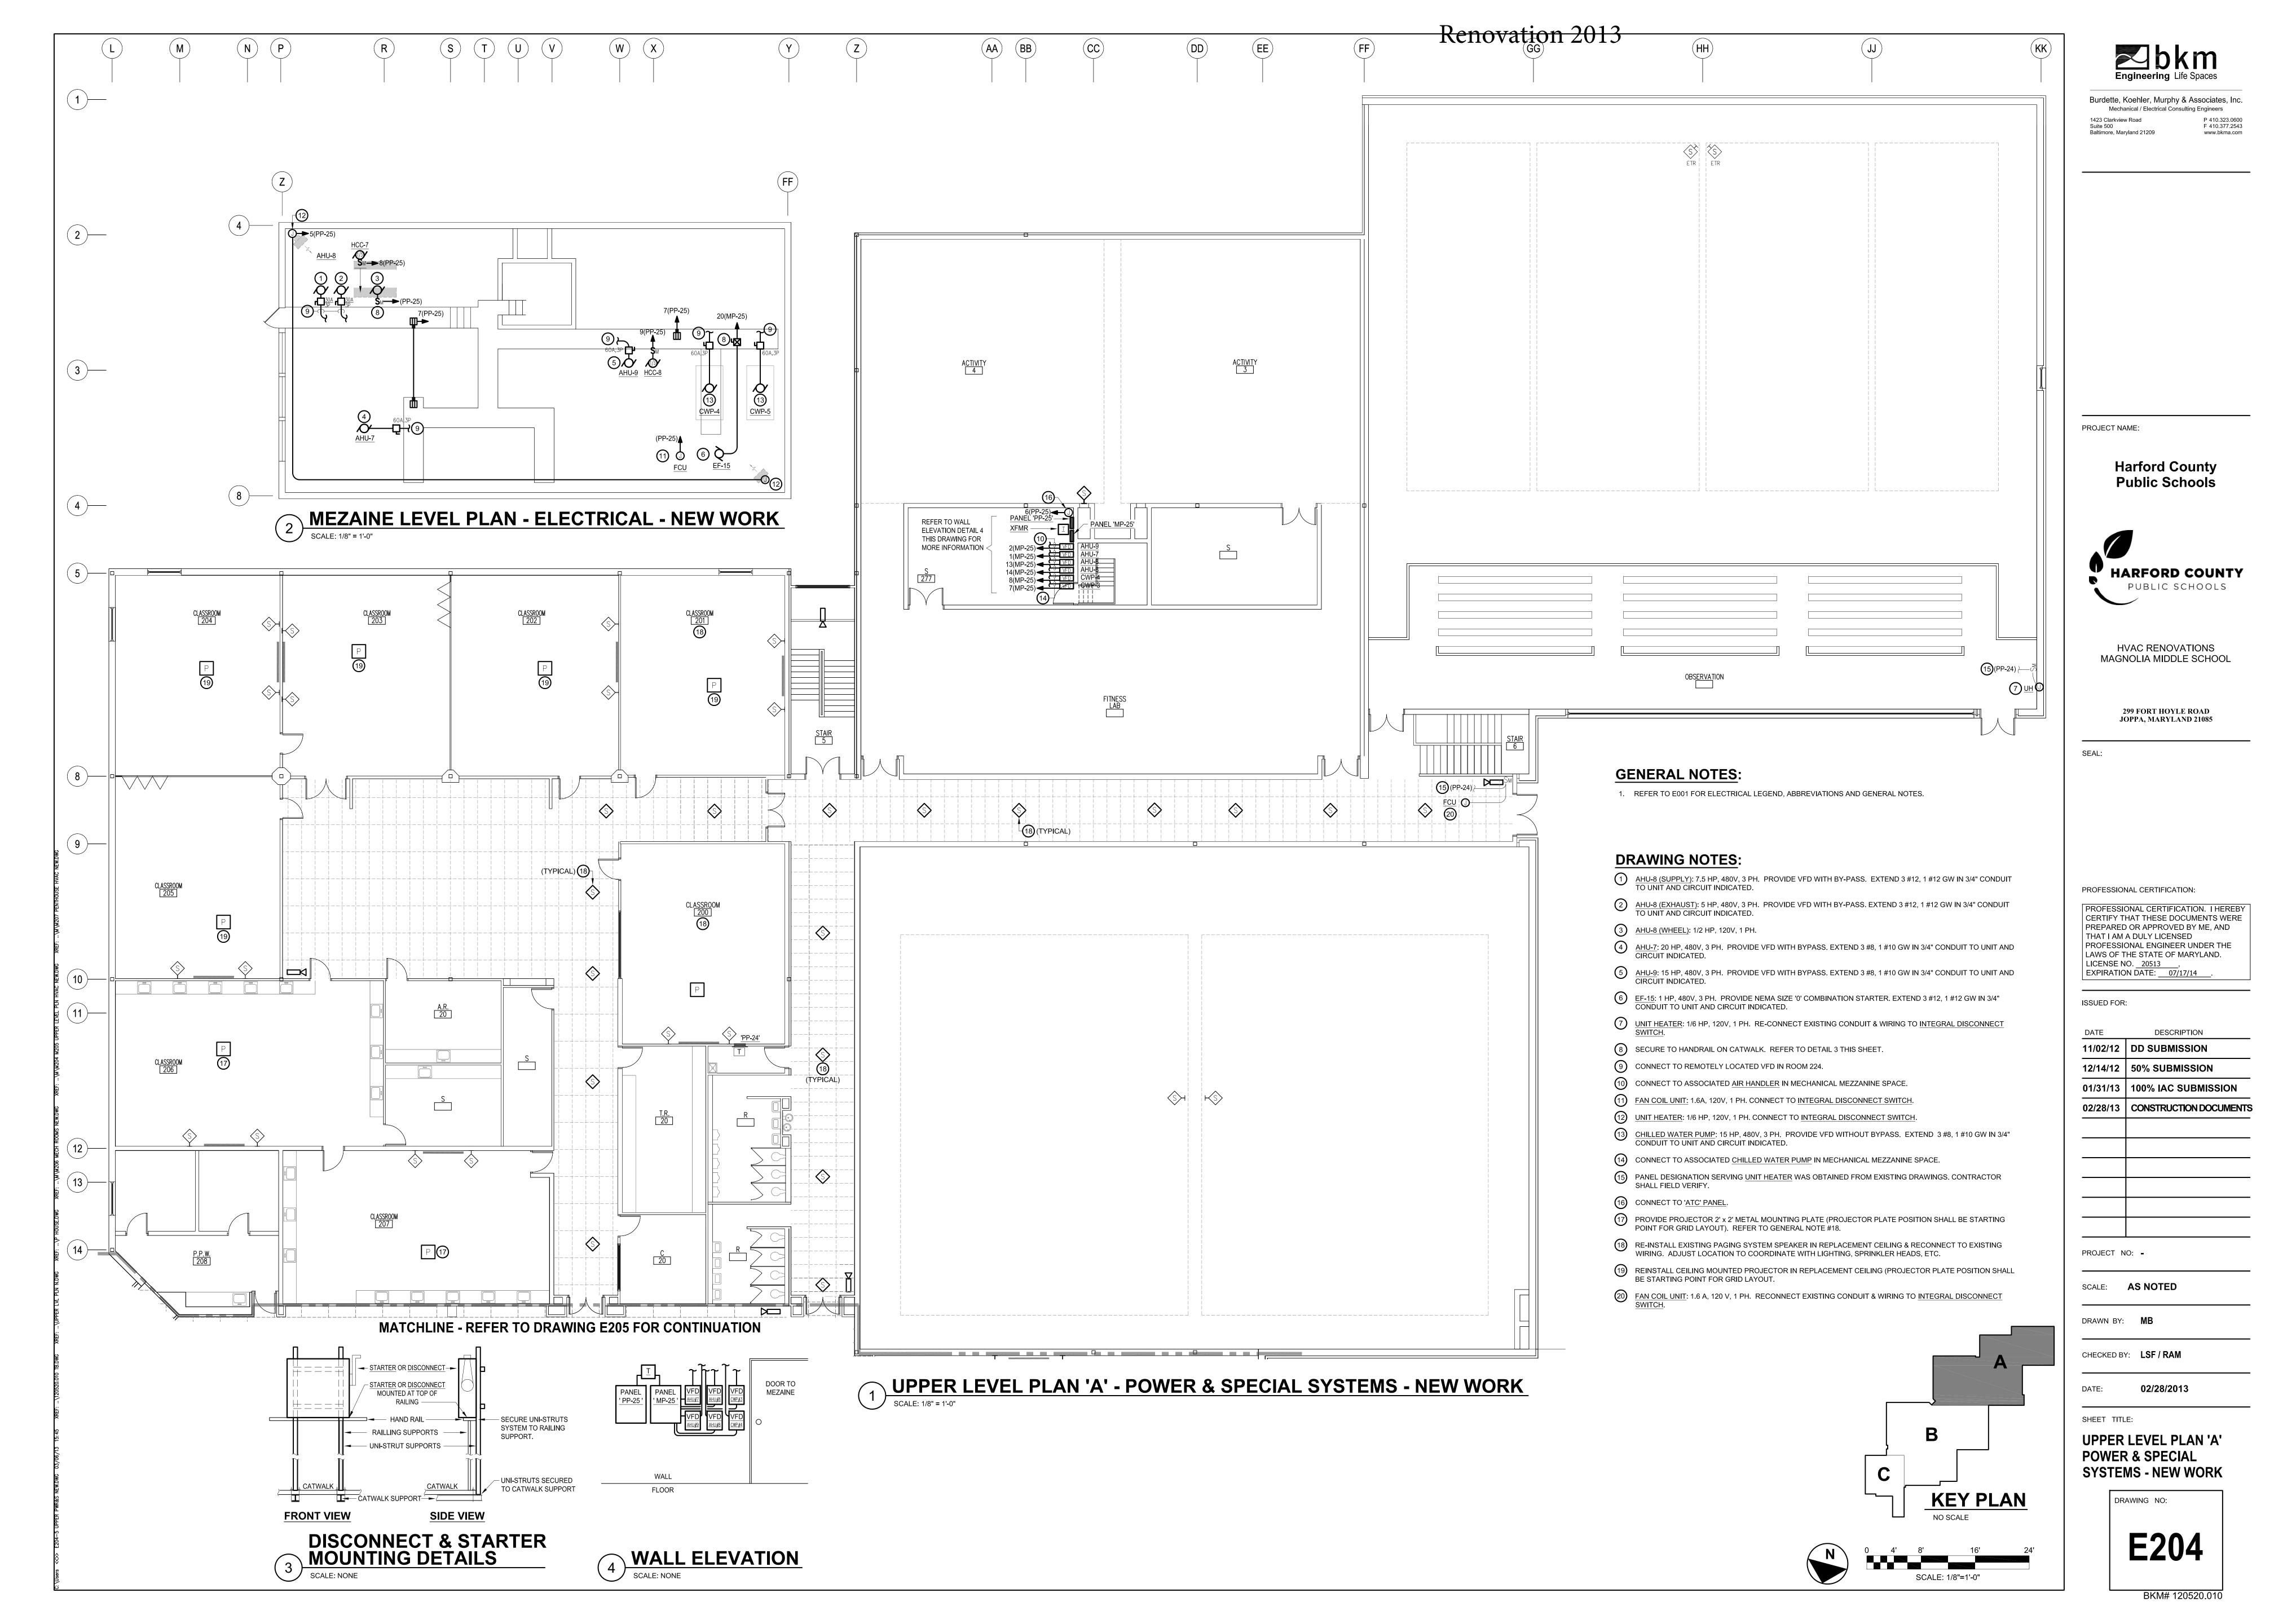

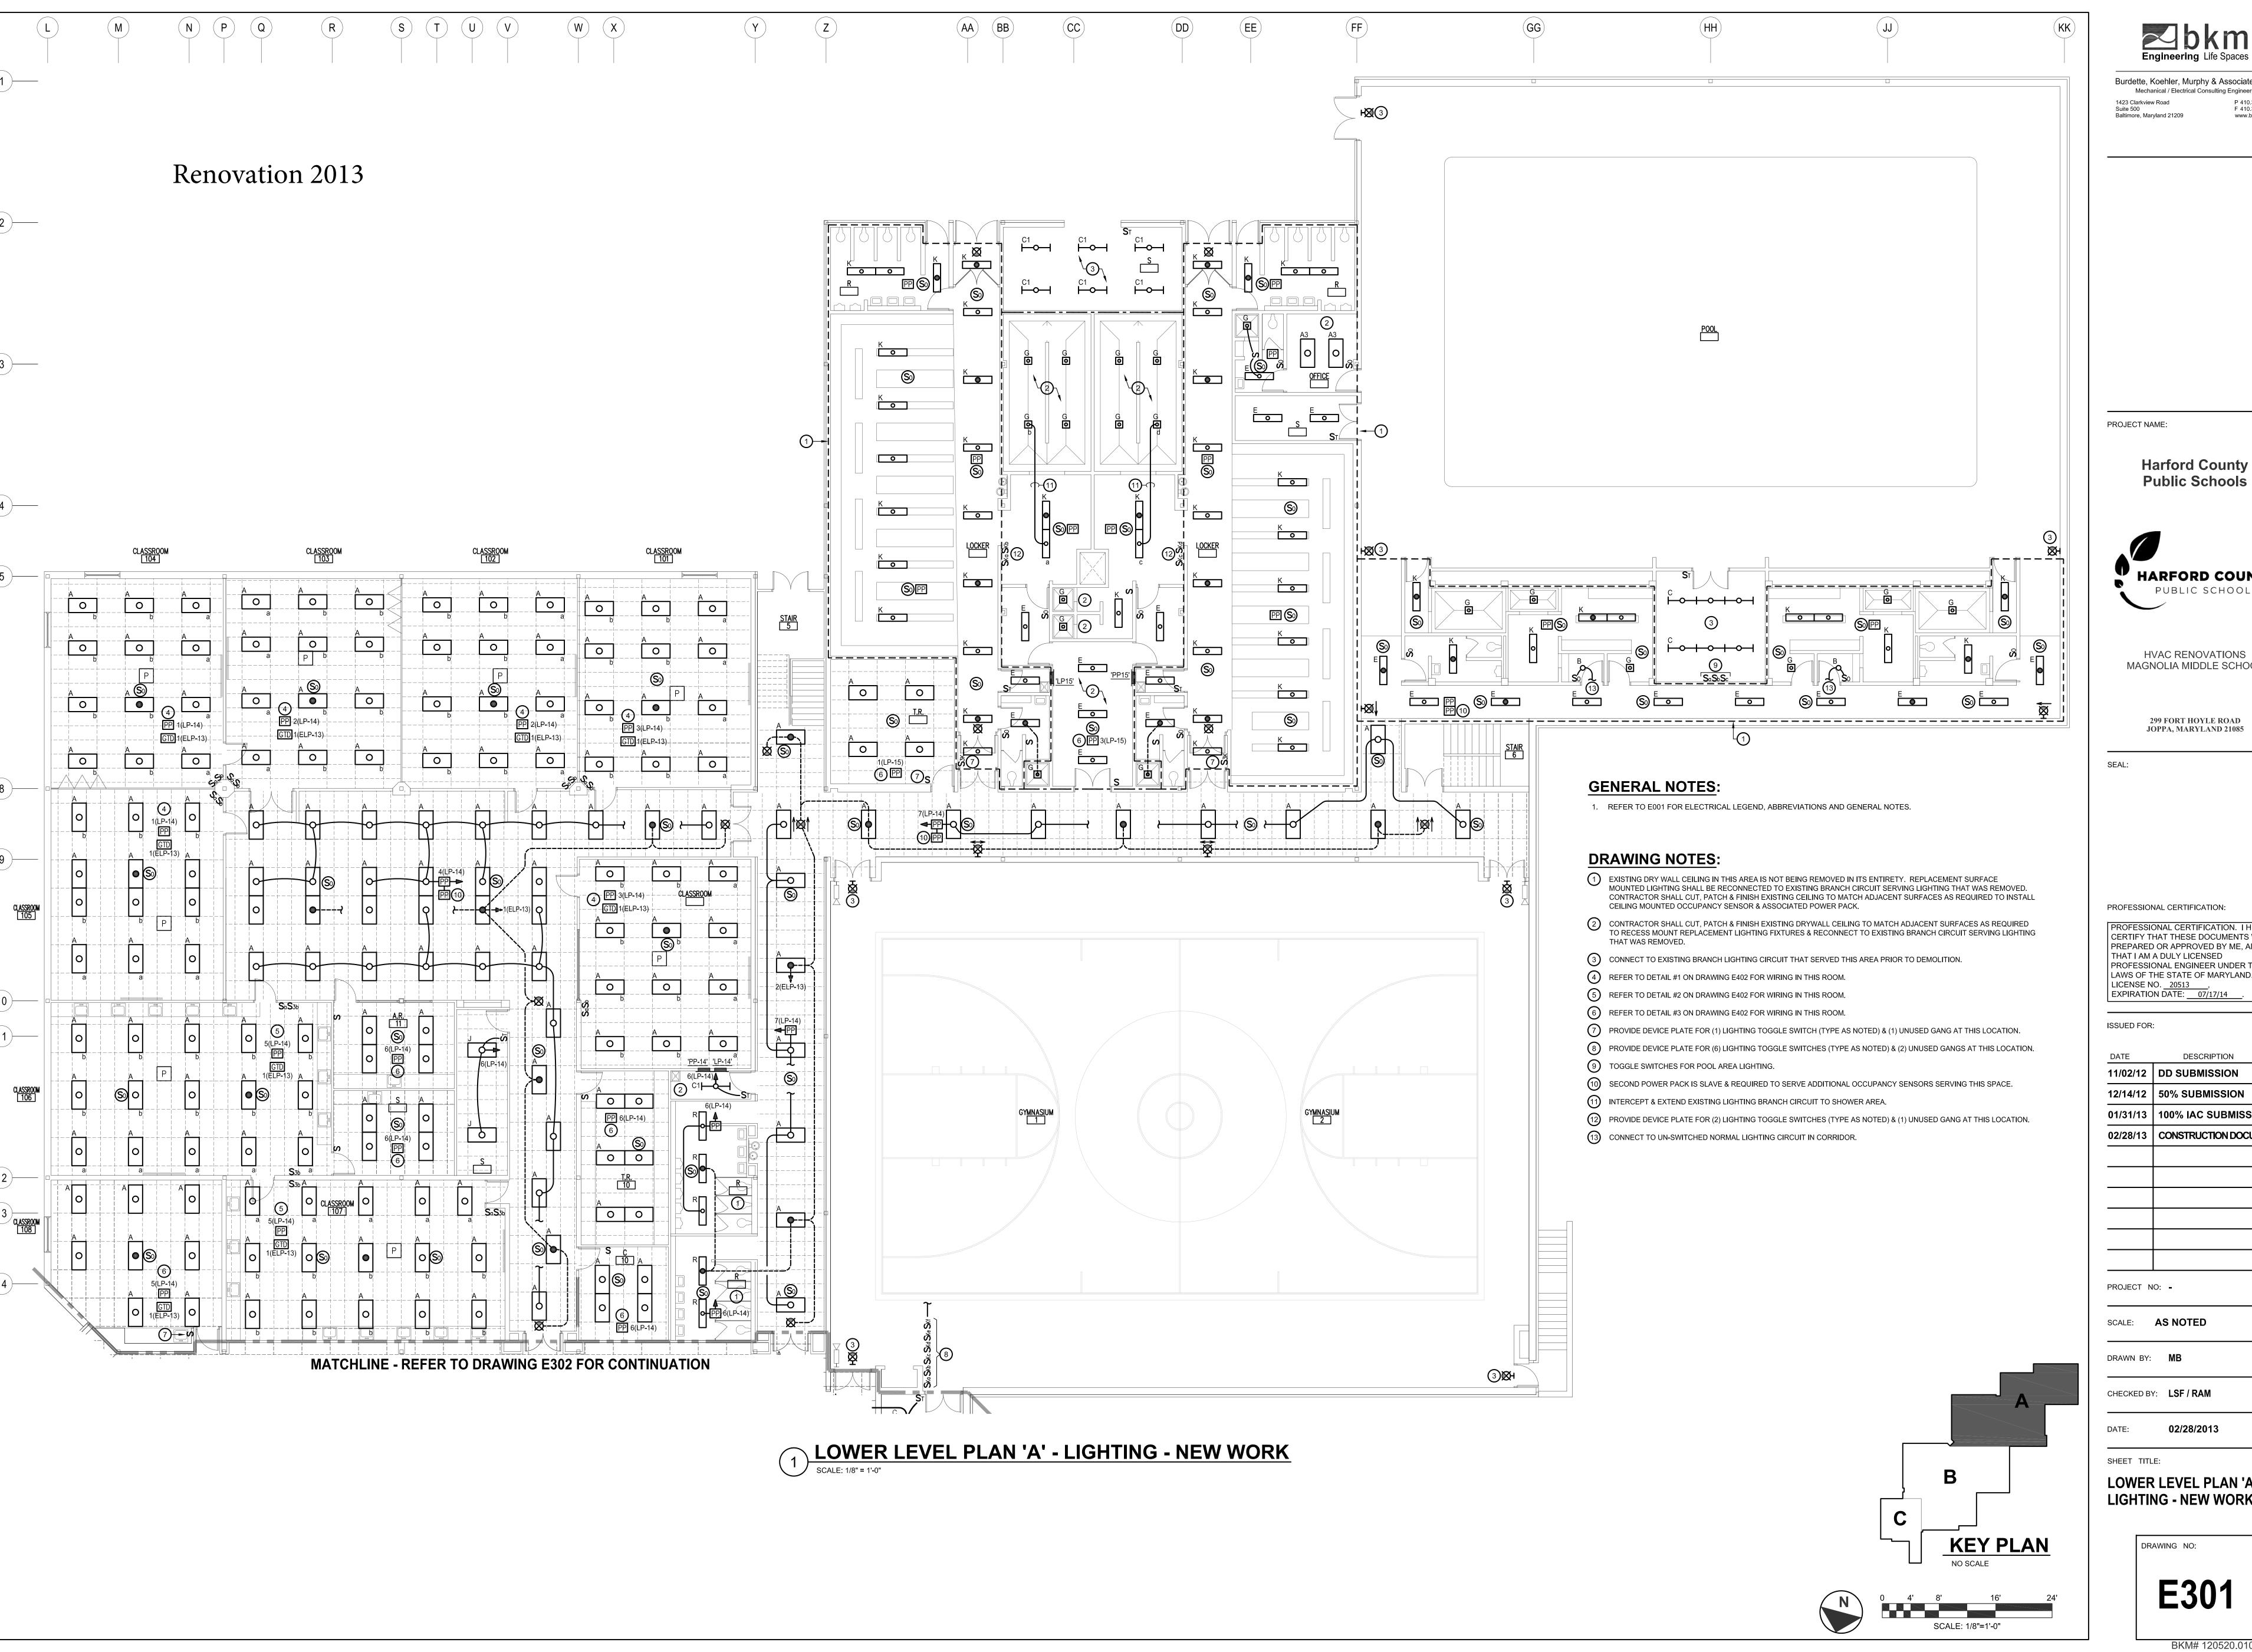



Harford County




299 FORT HOYLE ROAD **JOPPA, MARYLAND 21085**

PROFESSIONAL CERTIFICATION. I HEREBY CERTIFY THAT THESE DOCUMENTS WERE PREPARED OR APPROVED BY ME, AND THAT I AM A DULY LICENSED PROFESSIONAL ENGINEER UNDER THE LAWS OF THE STATE OF MARYLAND.

DATE	DESCRIPTION
11/02/12	DD SUBMISSION
12/14/12	50% SUBMISSION
01/31/13	100% IAC SUBMISSION
02/28/13	CONSTRUCTION DOCUMENT
	†

LOWER LEVEL PLAN 'A' **LIGHTING - NEW WORK**

E301

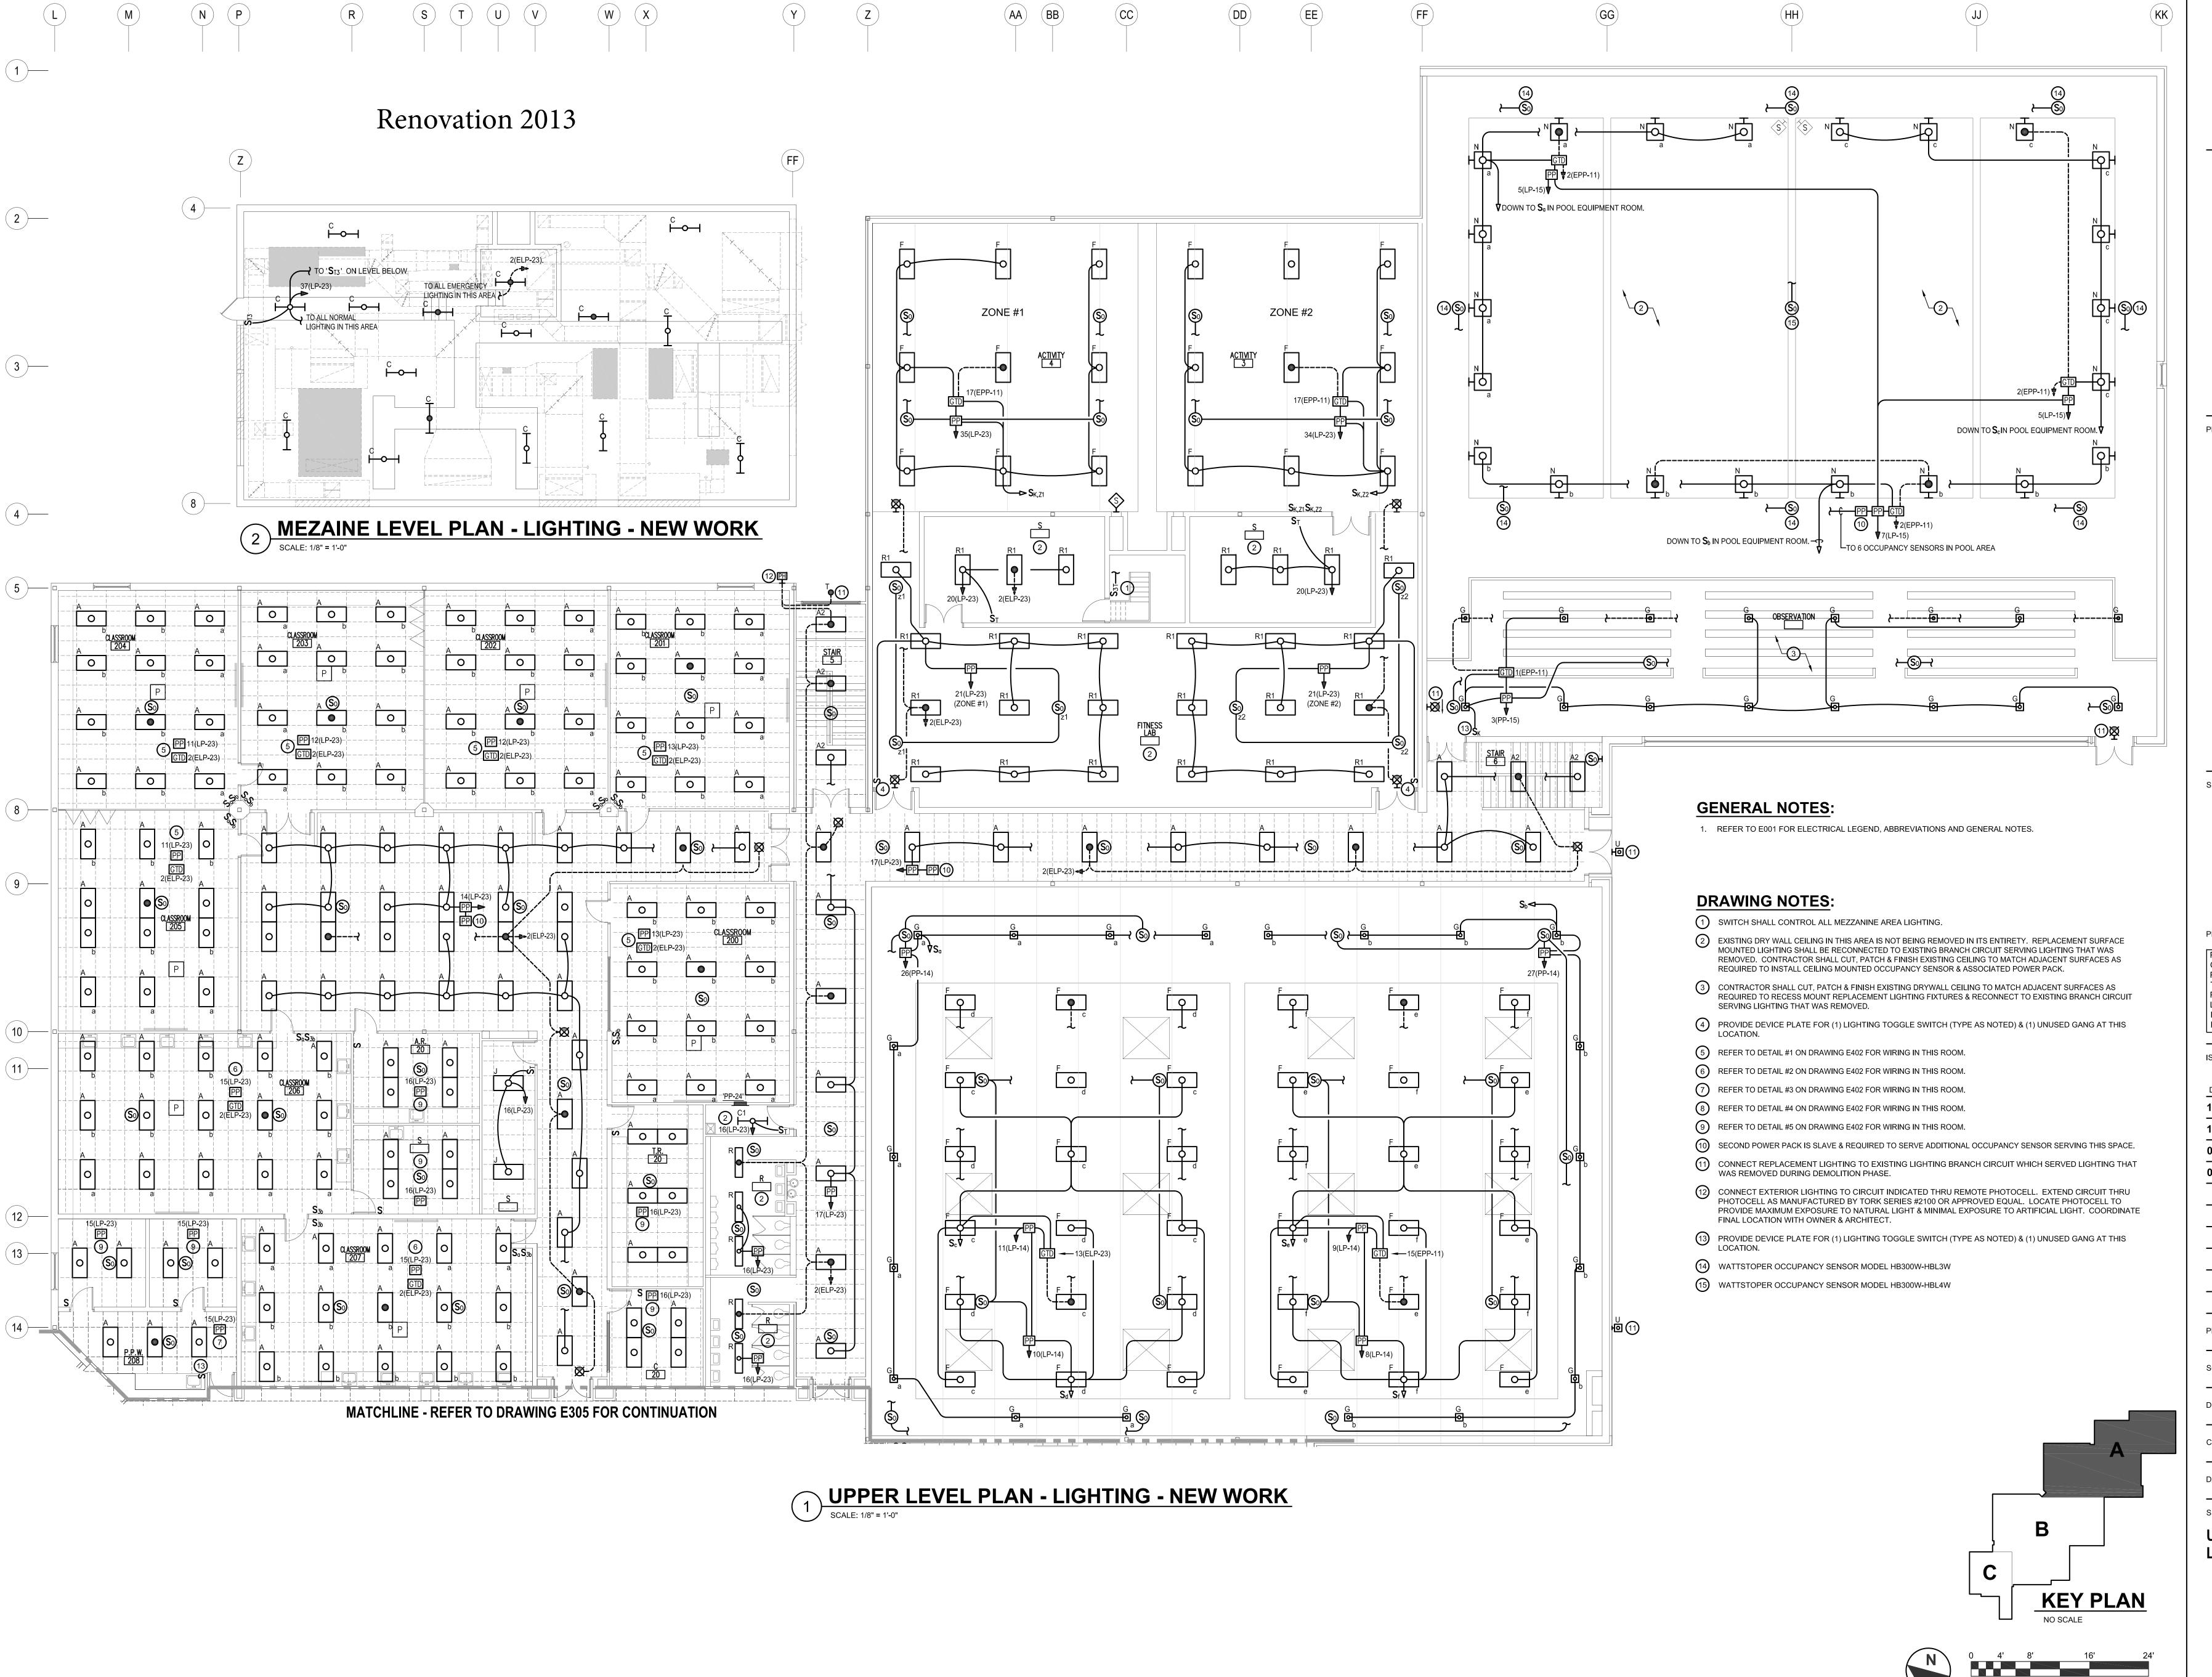



Burdette, Koehler, Murphy & Associa

Mechanical / Electrical Consulting Engine

1423 Clarkview Road P 41

Suite 500 F 41

Baltimore, Maryland 21209 www.

PROJECT NAME:

Harford County
Public Schools



HVAC RENOVATIONS MAGNOLIA MIDDLE SCHOOL

299 FORT HOYLE ROAD JOPPA, MARYLAND 21085

EAL:

PROFESSIONAL CERTIFICATION:

PROFESSIONAL CERTIFICATION. I HEREBY CERTIFY THAT THESE DOCUMENTS WERE PREPARED OR APPROVED BY ME, AND THAT I AM A DULY LICENSED PROFESSIONAL ENGINEER UNDER THE LAWS OF THE STATE OF MARYLAND. LICENSE NO. 20513 , EXPIRATION DATE: 07/17/14

ISSUED FOR:

DATE DESCRIPTION

11/02/12 DD SUBMISSION

12/14/12 50% SUBMISSION

01/31/13 100% IAC SUBMISSION

02/28/13 CONSTRUCTION DOCUMENTS

PROJECT NO: -

35ECT NO. =

SCALE: AS NOTED

DRAWN BY: MR

CHECKED BY: LSF / RAN


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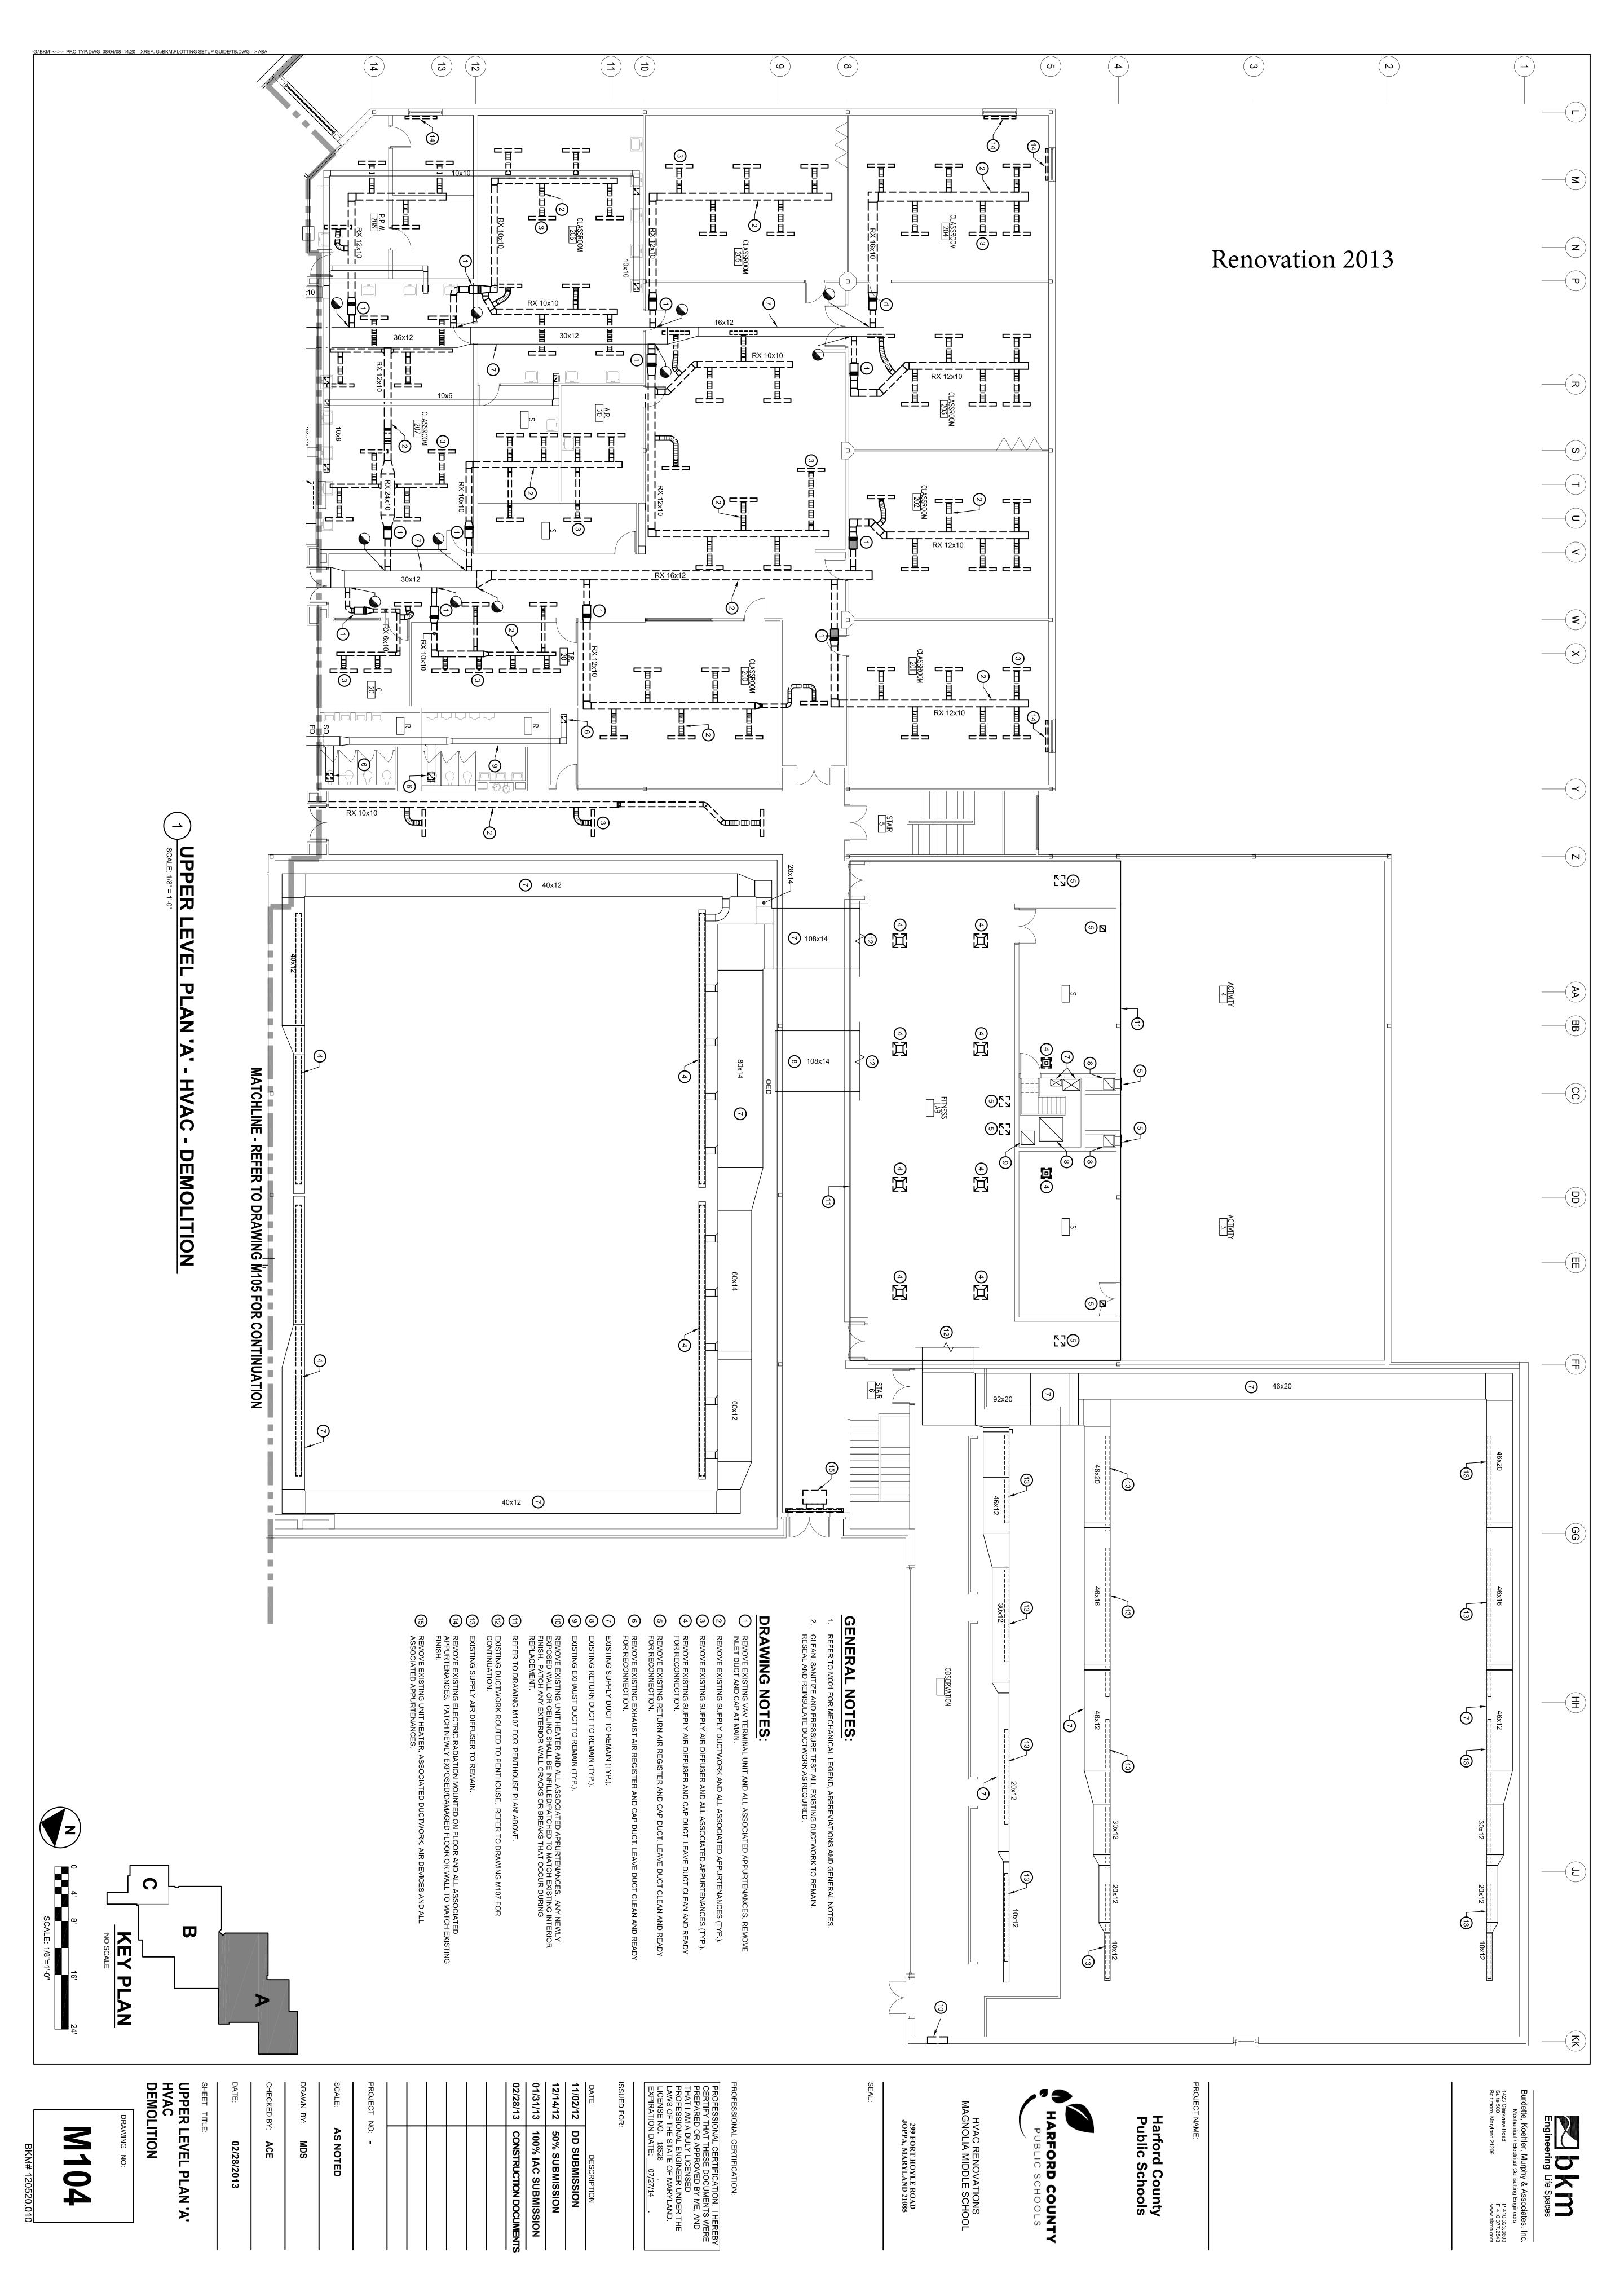
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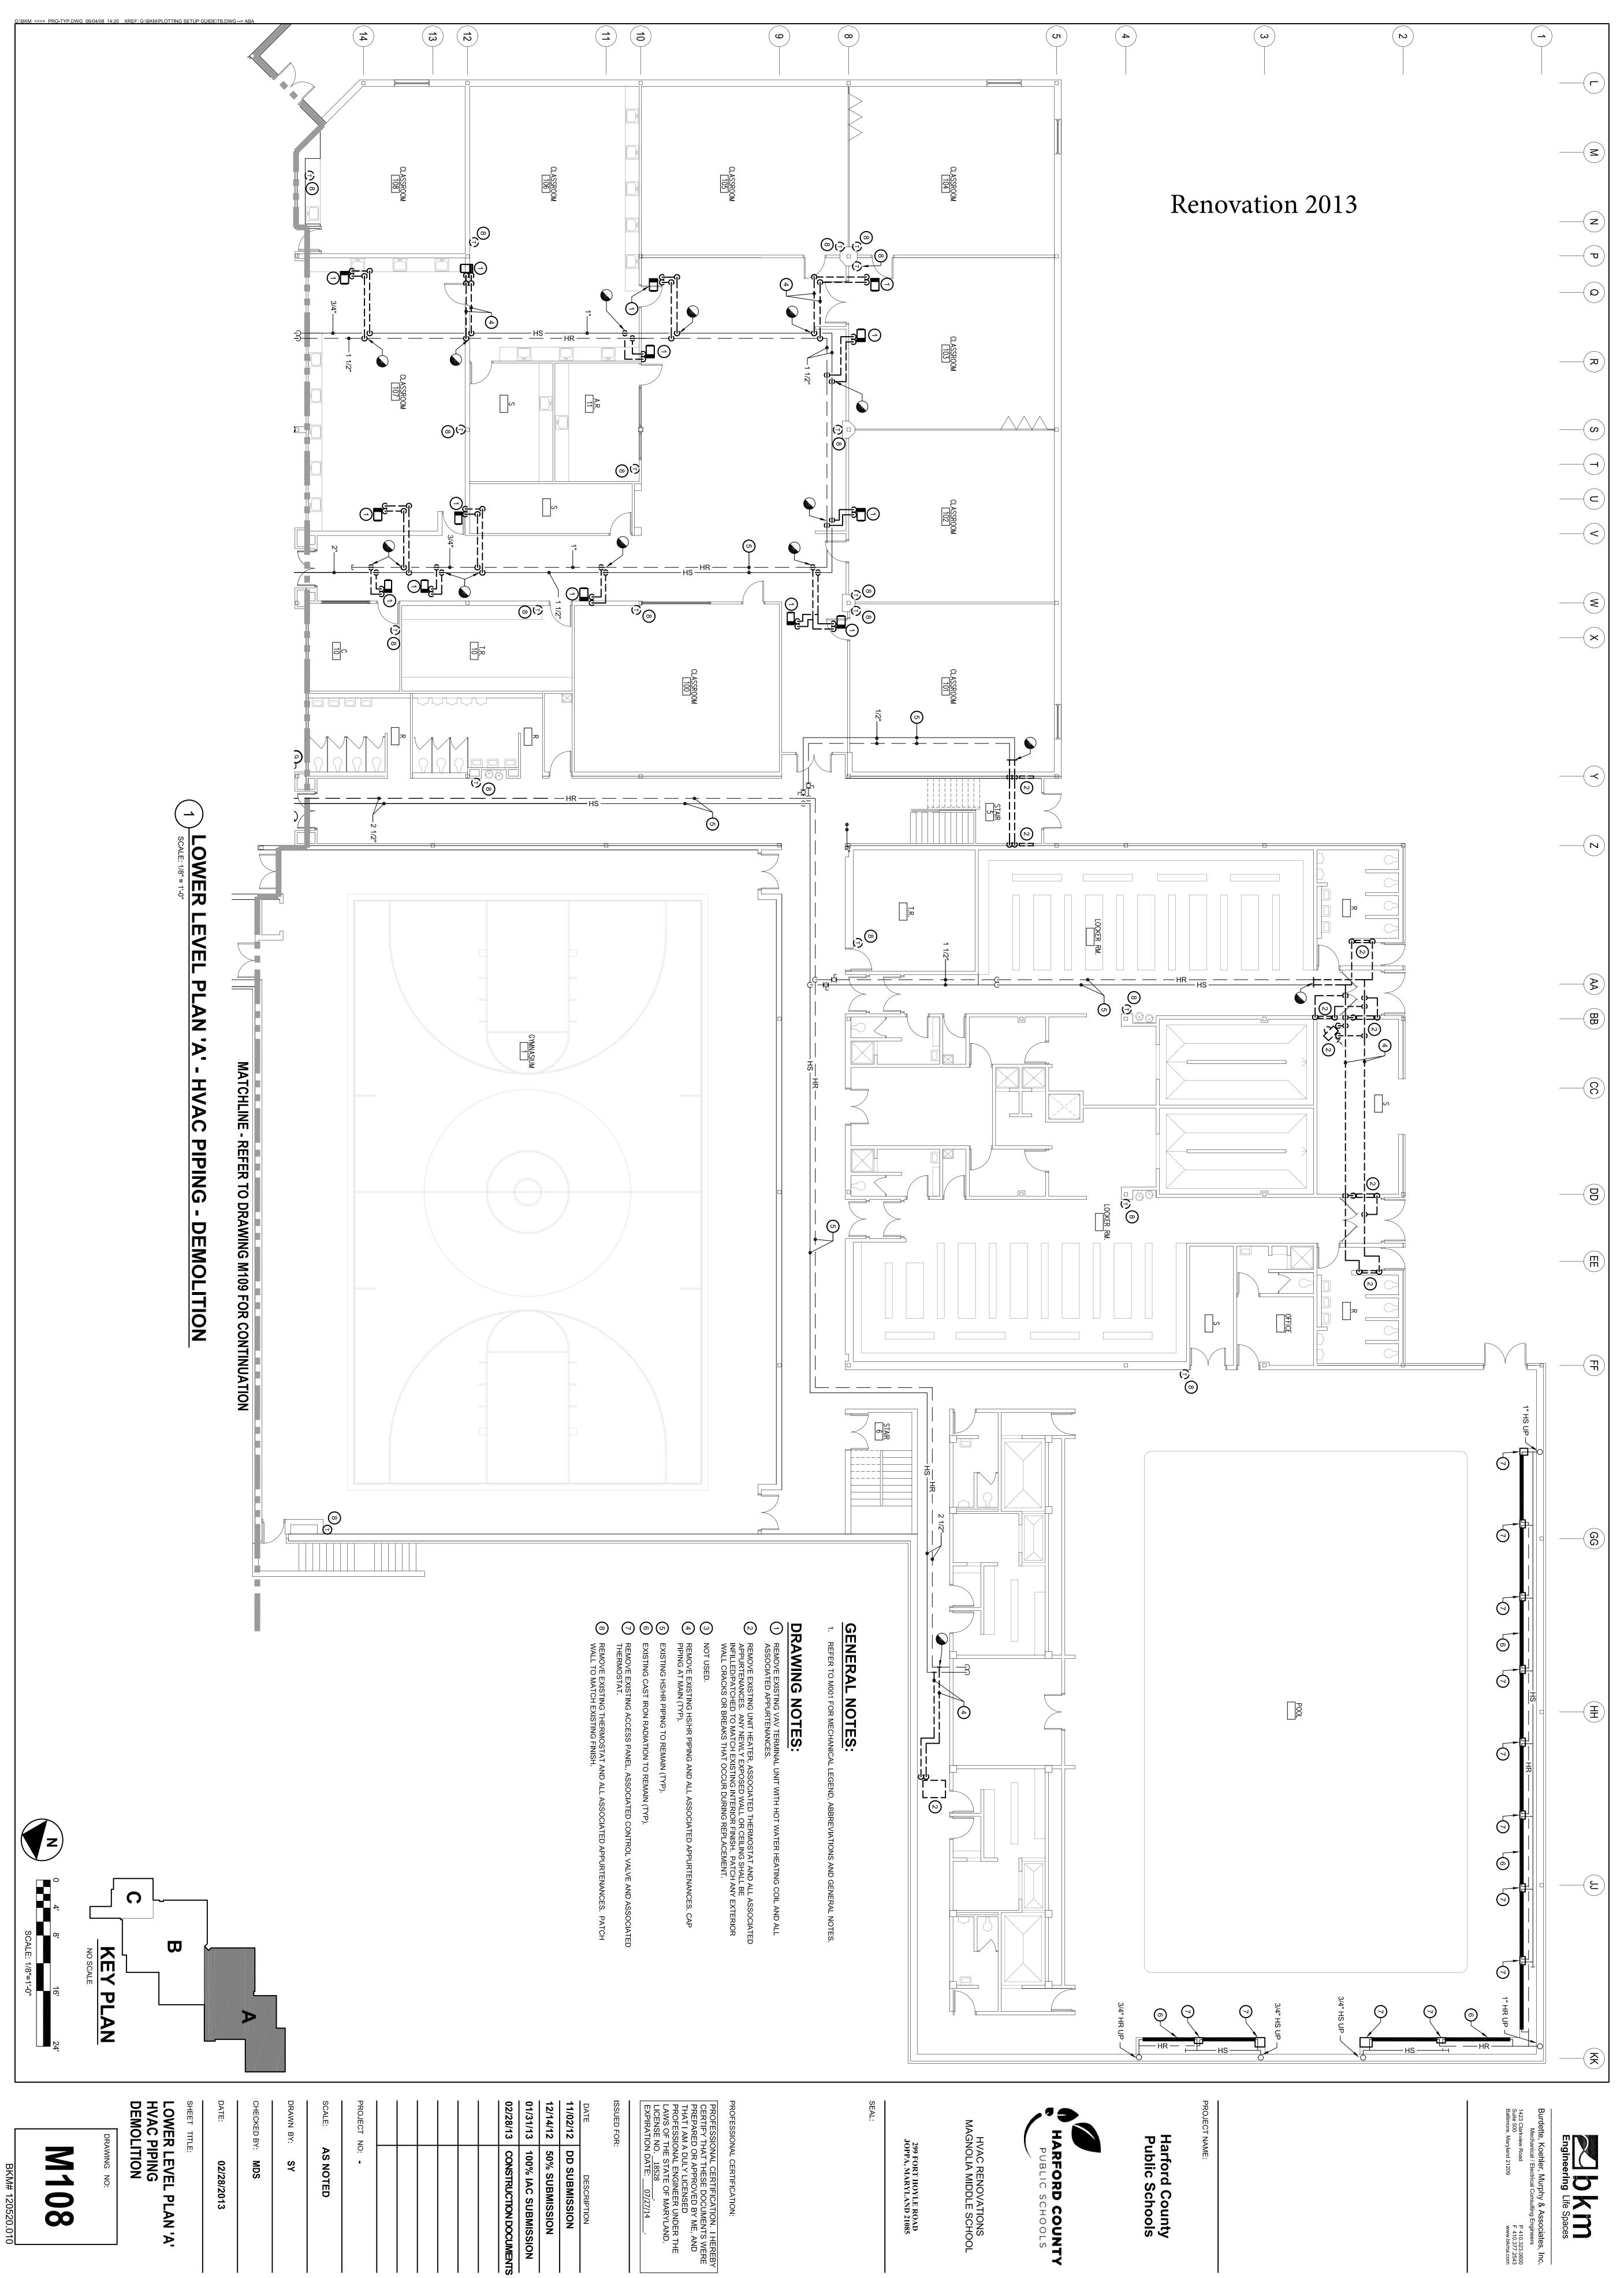
UPPER LEVEL PLAN 'A' LIGHTING - NEW WORK


E304


BKM# 120520.010





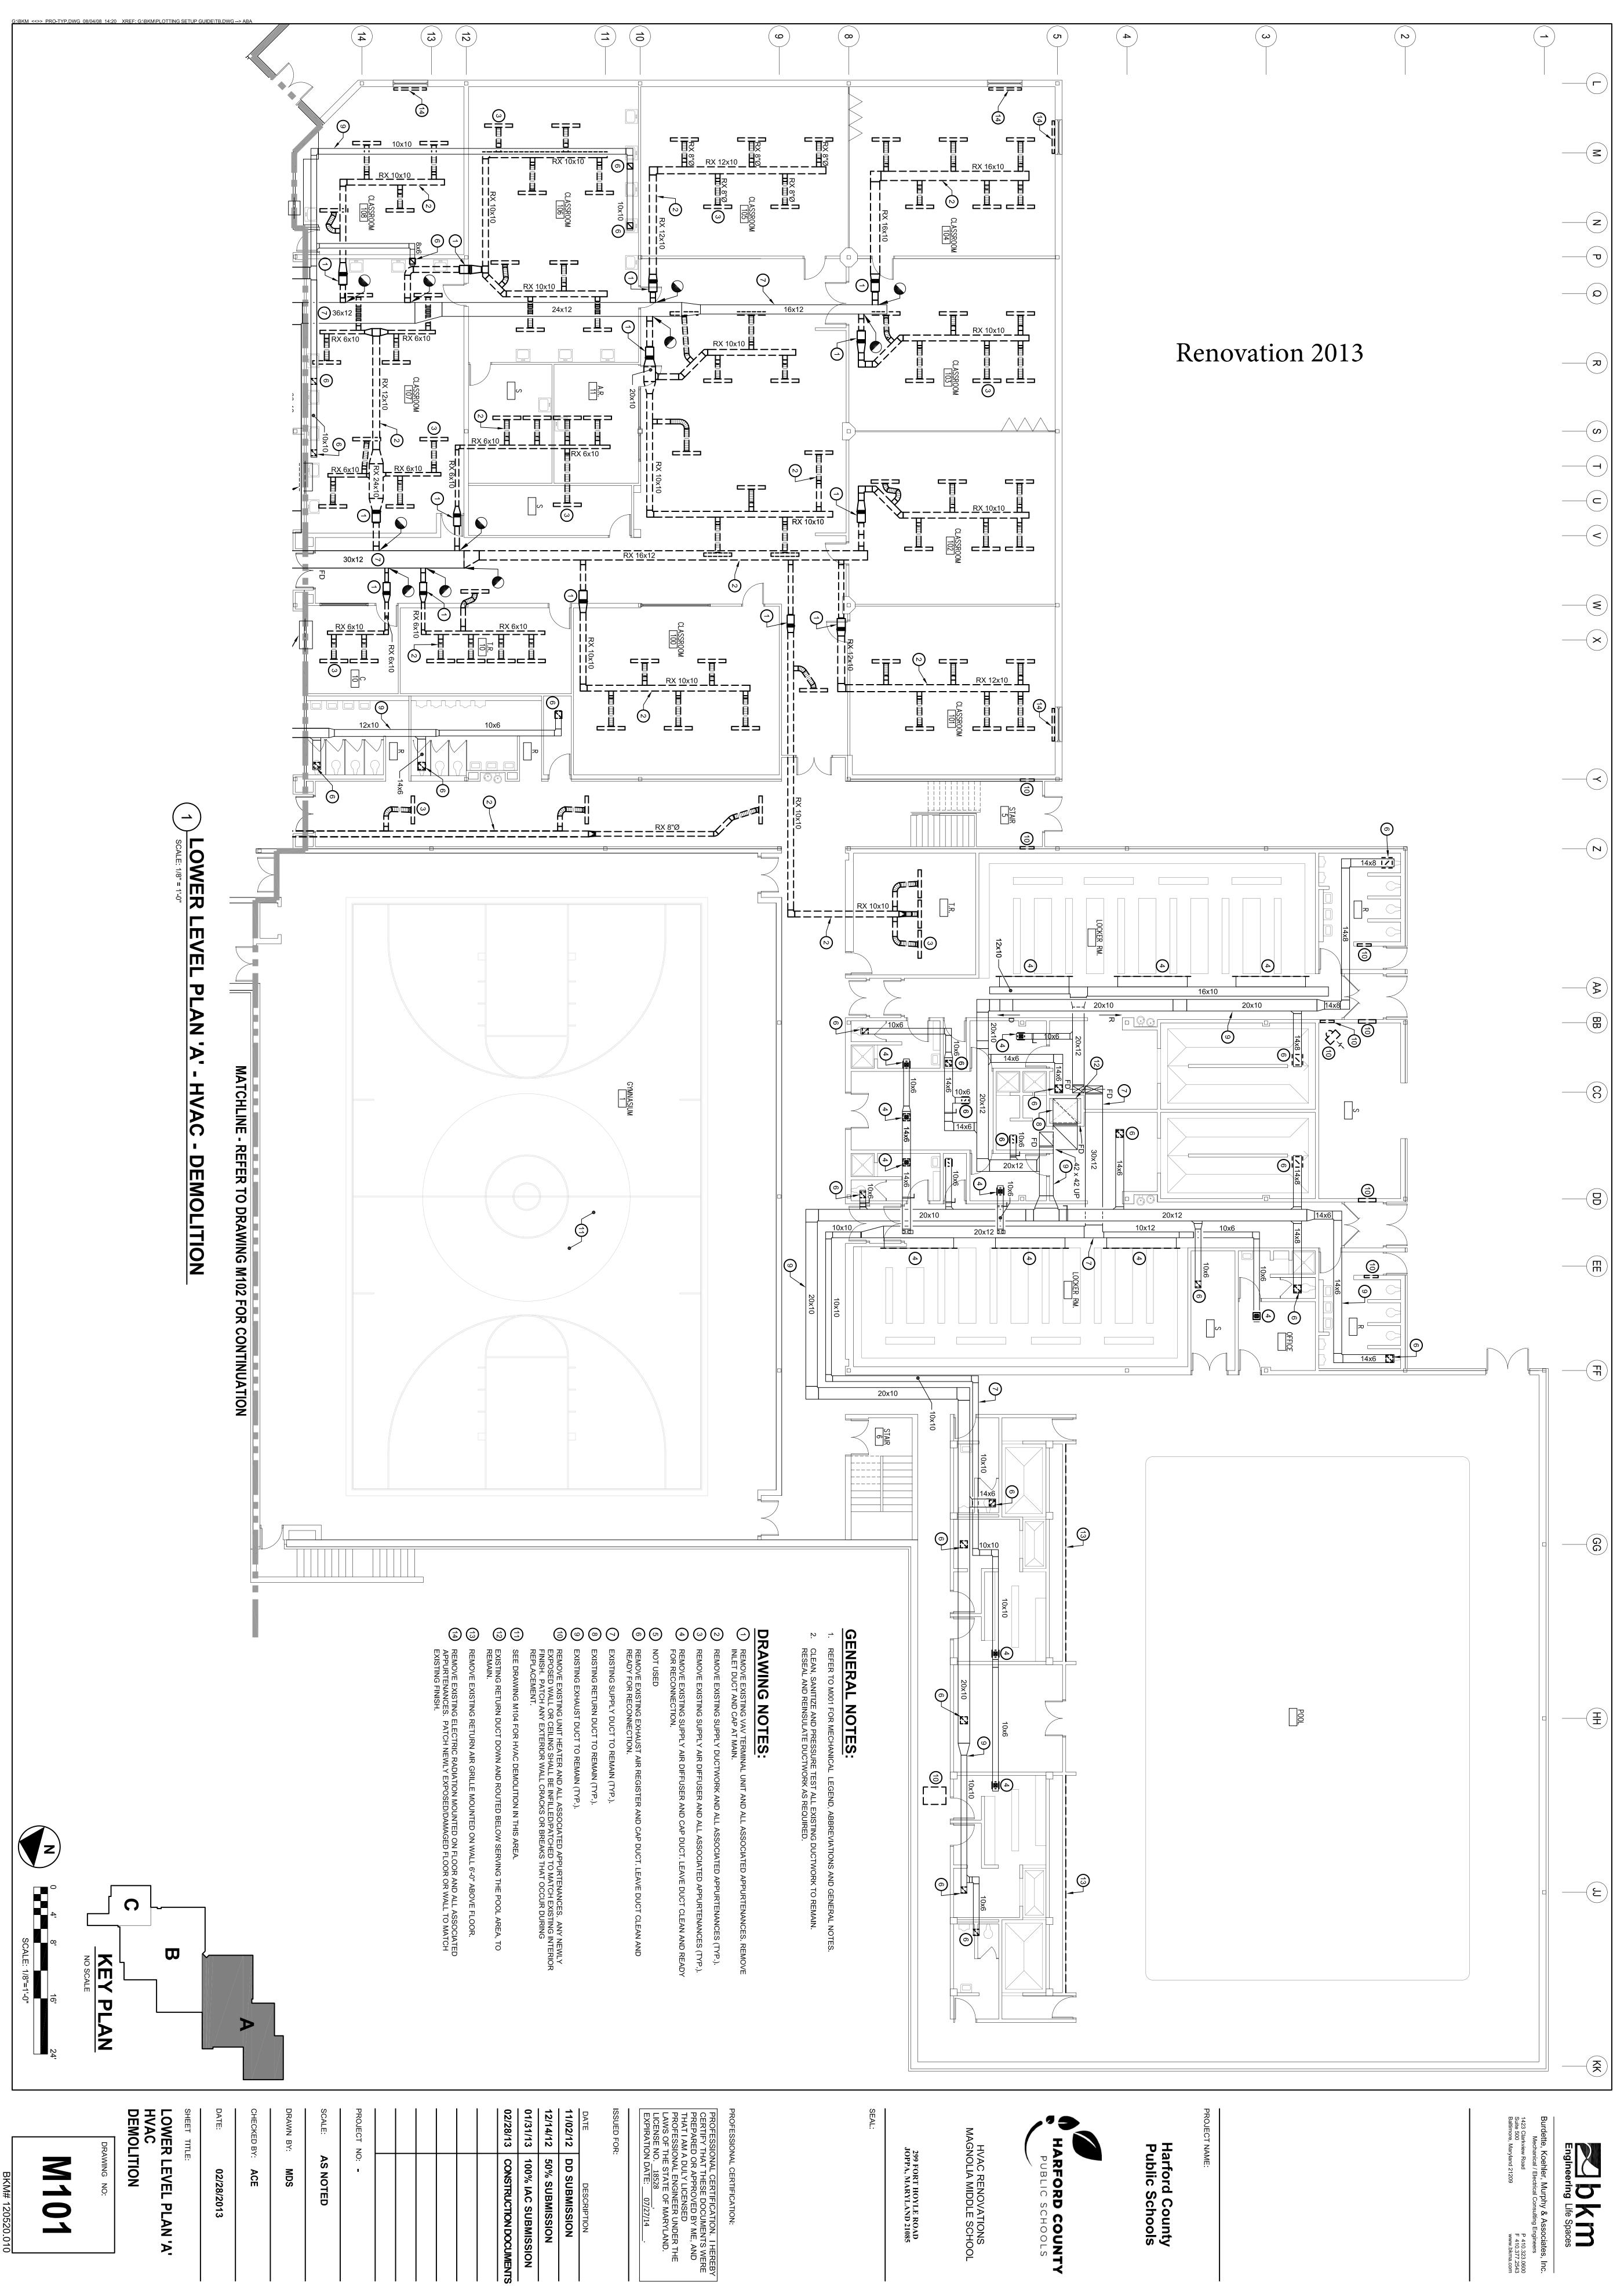

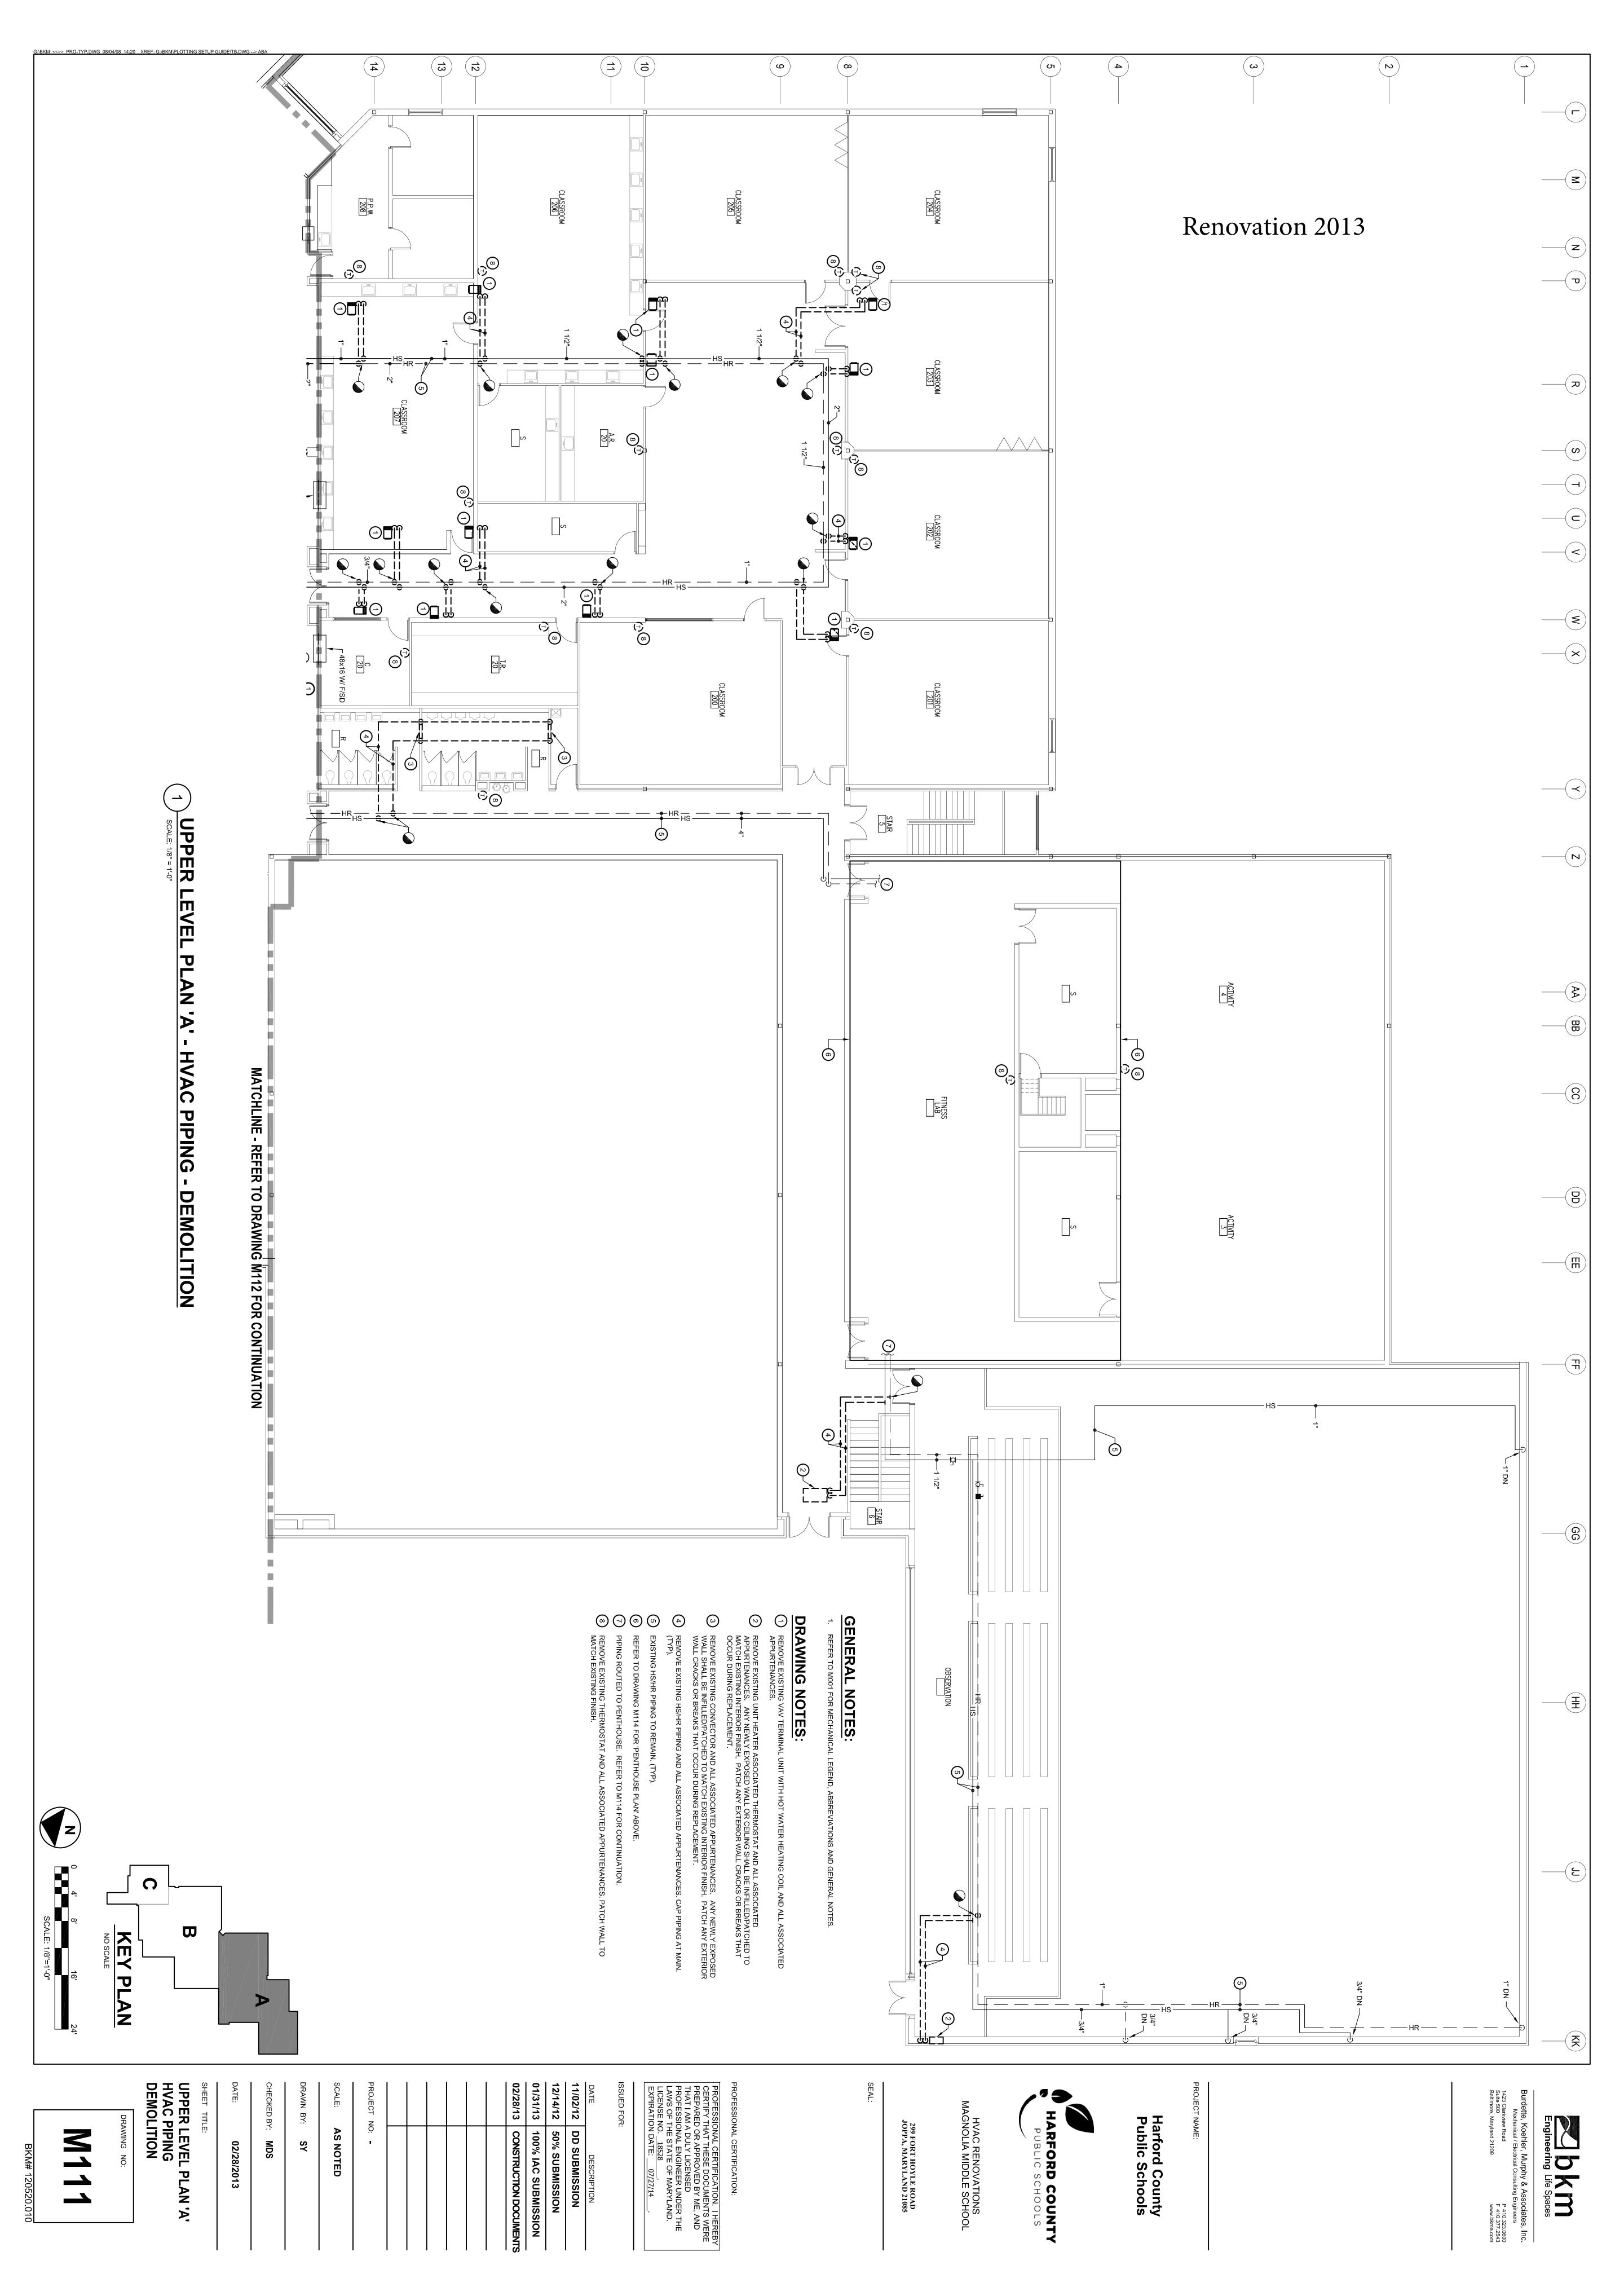

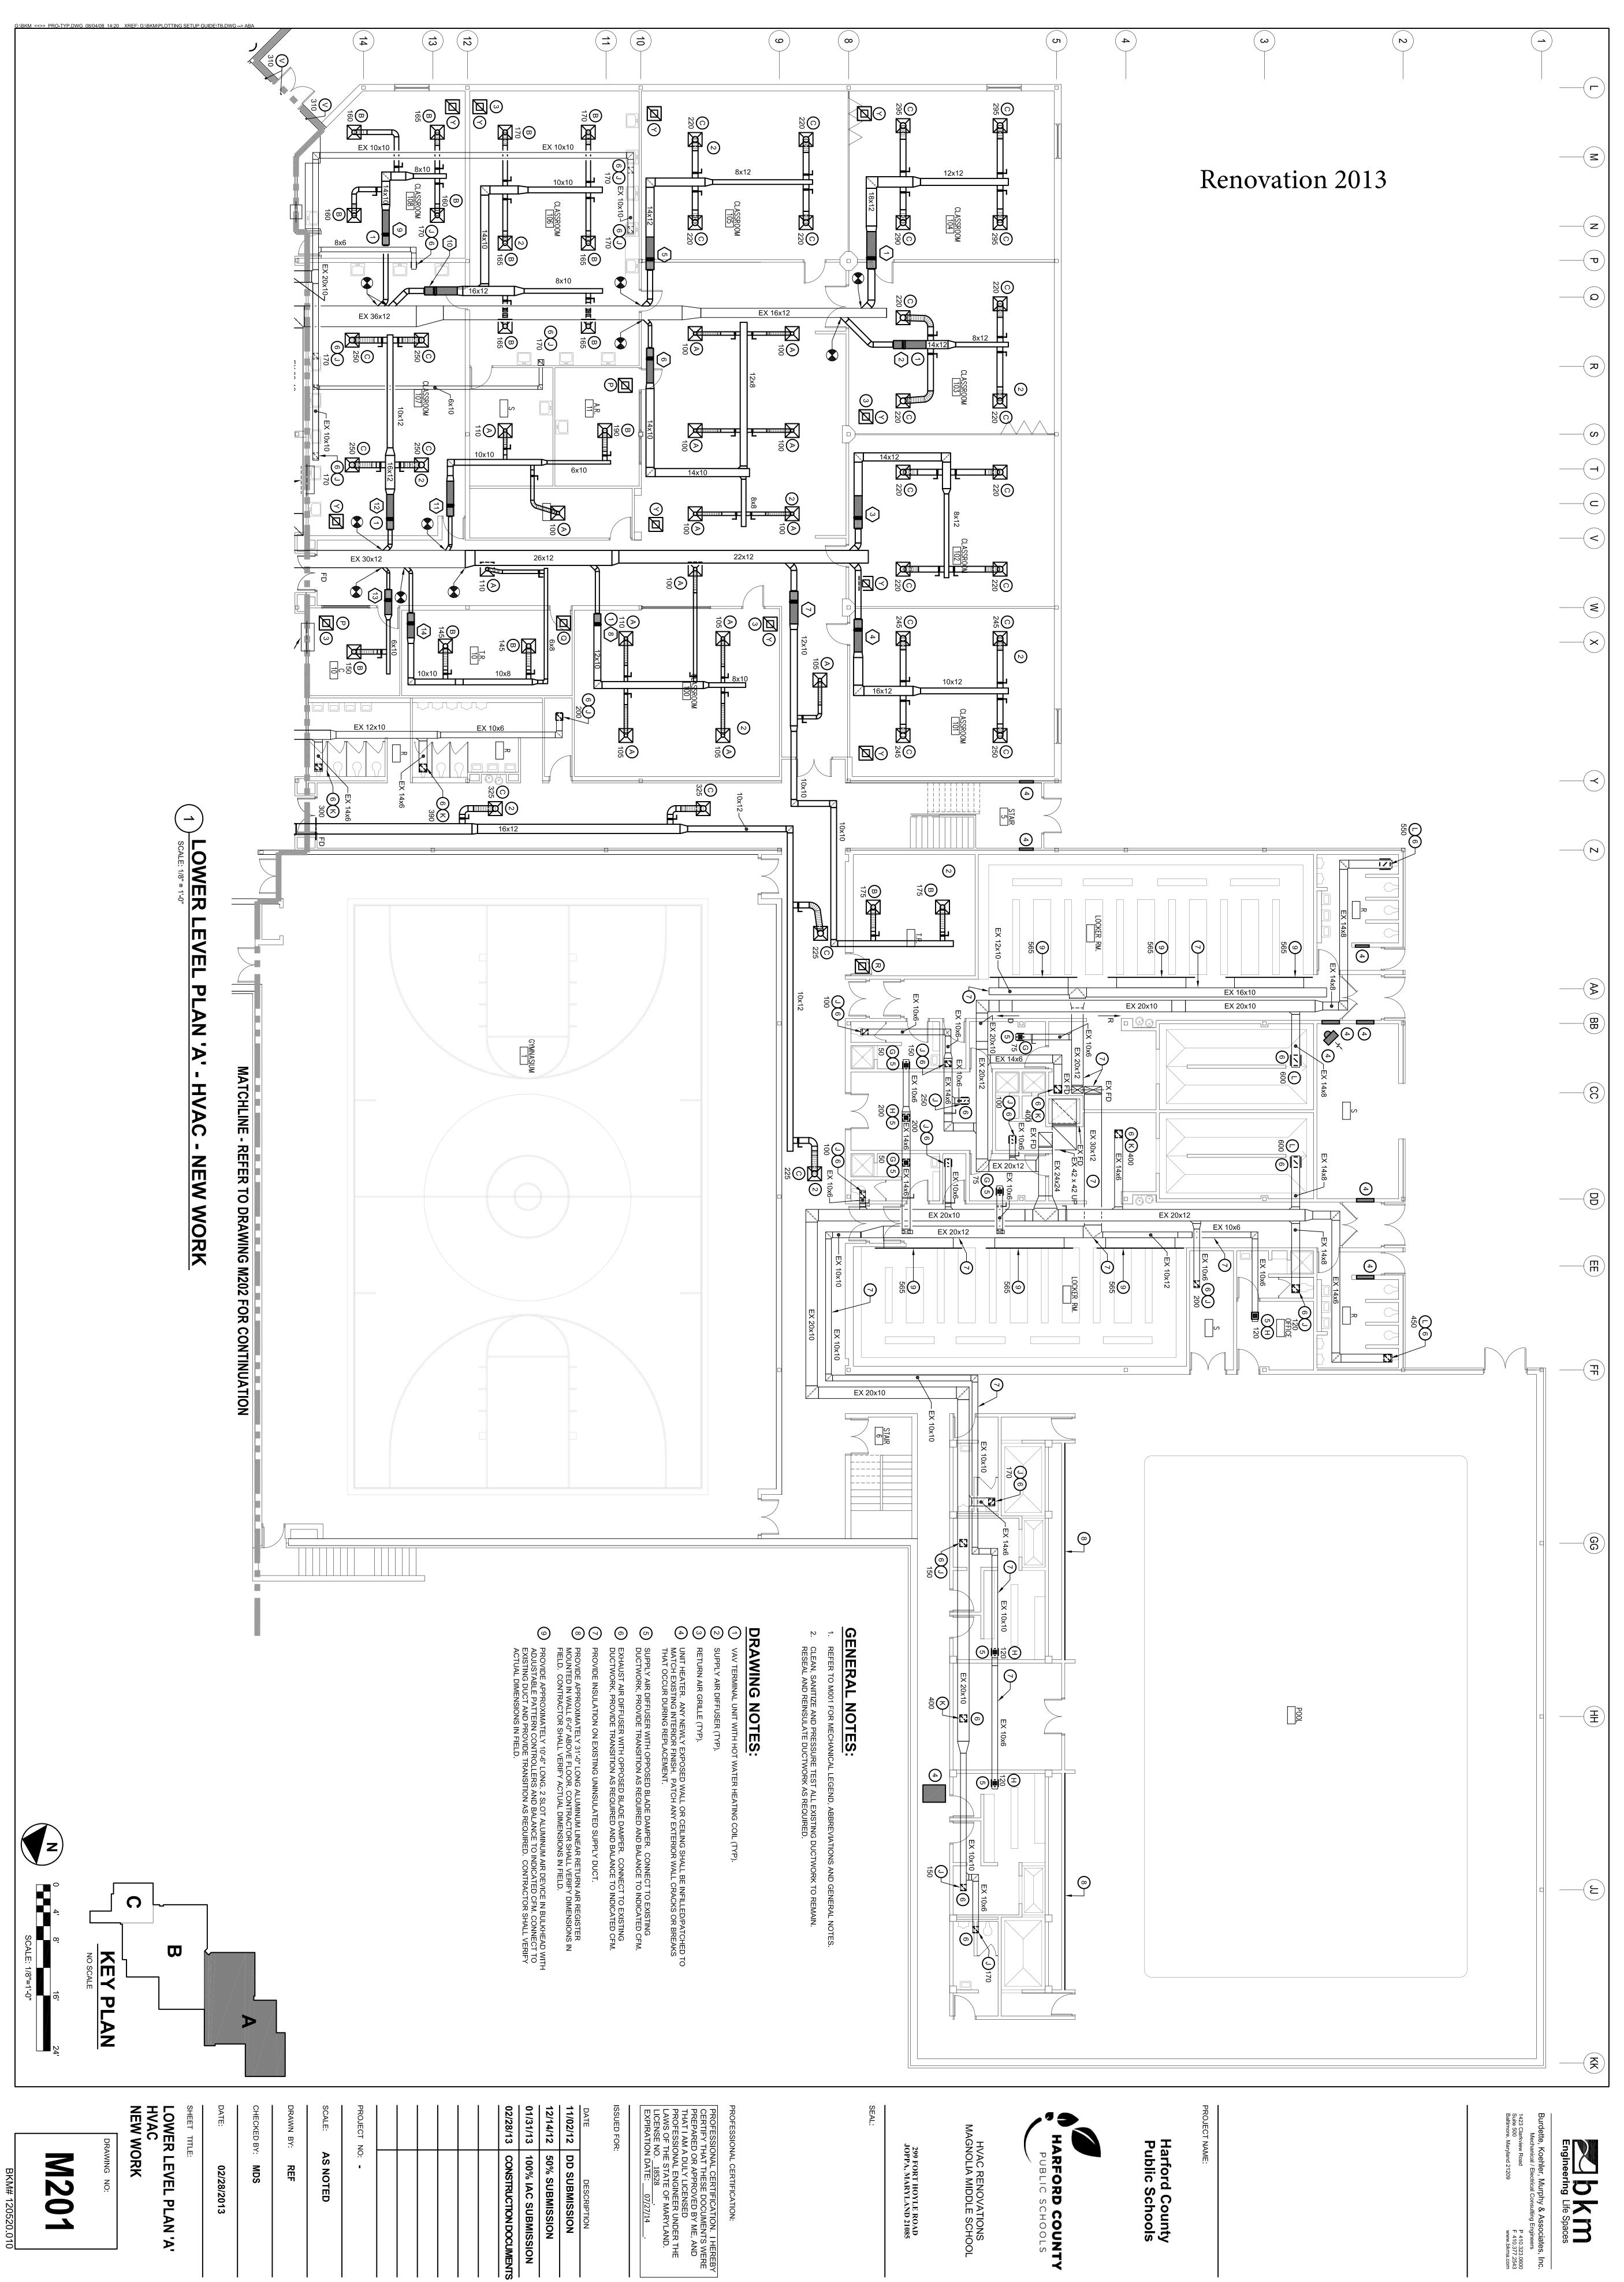

CONSTRUCTION DOCUMENTS

shler, Murphy & Associates, Inc.
al / Electrical Consulting Engineers
bad P 410.323.0600
F 410.377.2543
www.bkma.com

